

# NEWPORT NEWS REDEVELOPMENT and HOUSING AUTHORITY

# MARSHALL CT. APT. PHASE VII

741 34th STREET NEWPORT NEWS, VA 23607

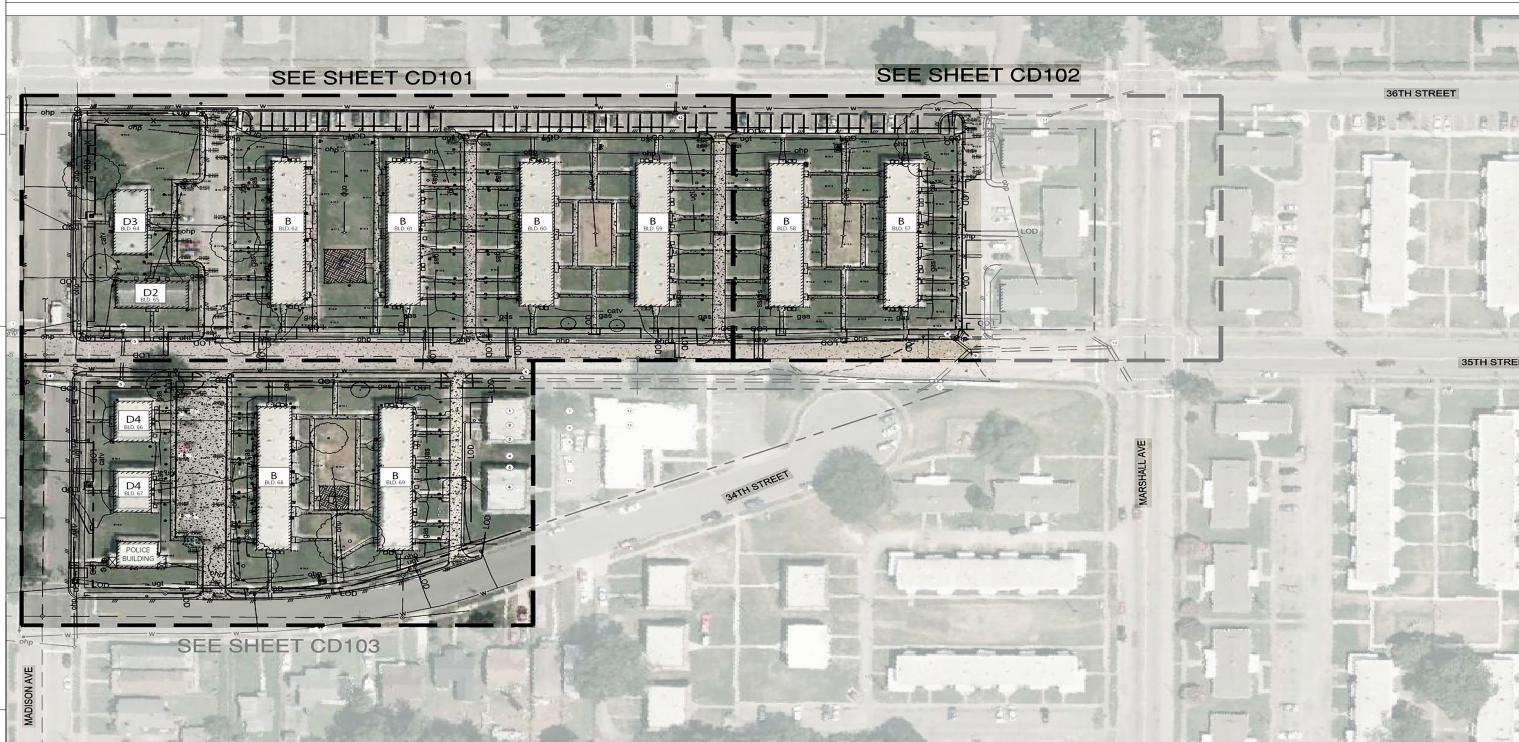

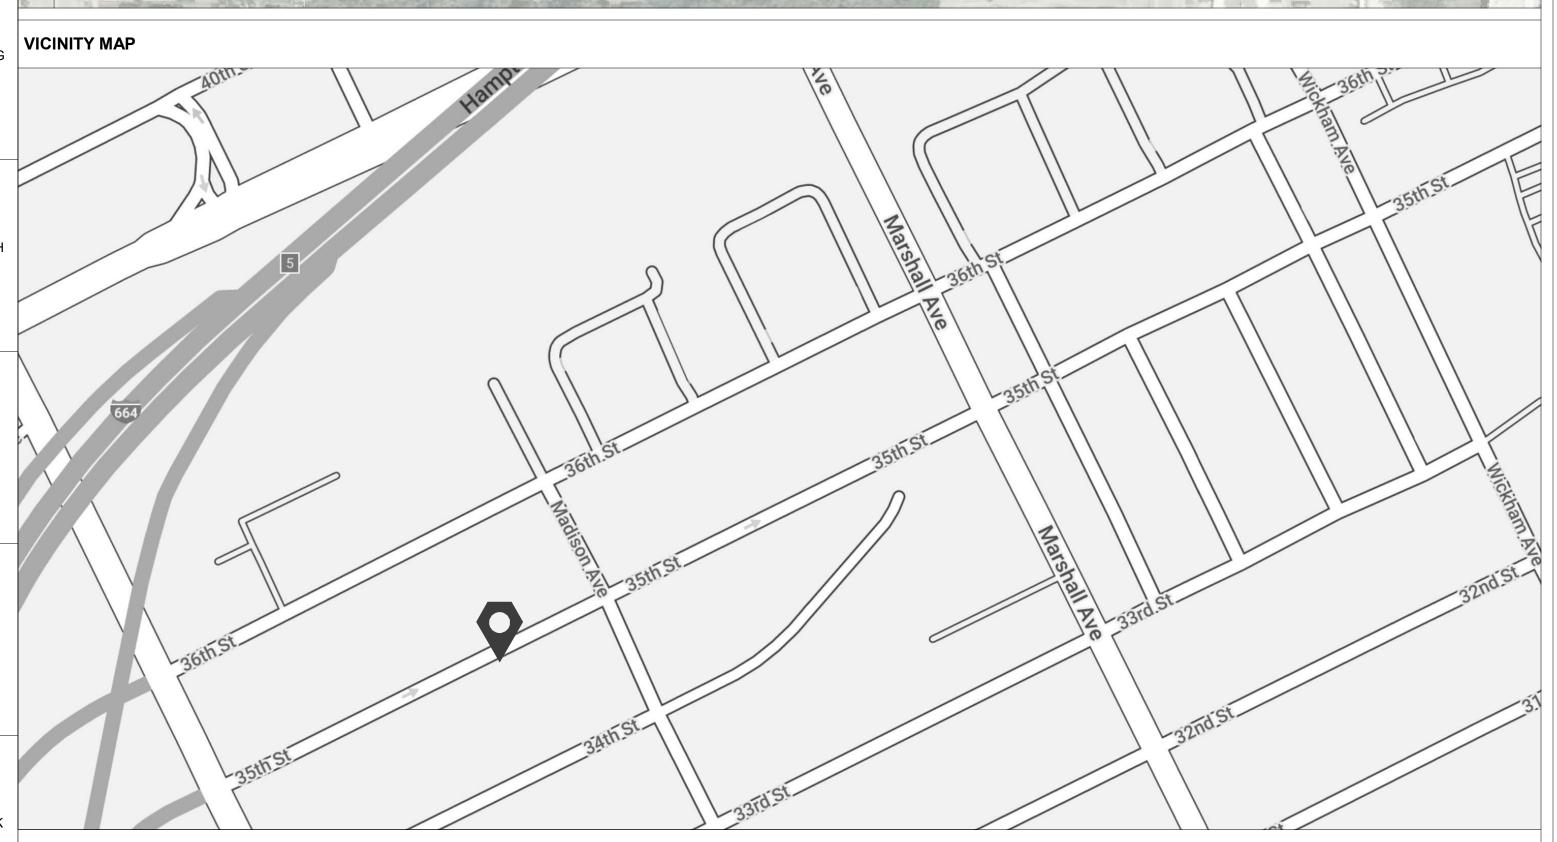

### **GENERAL CONTRACT NOTES**

### **PROJECT TEAM**

**ARCHITECT: CIVIL ENGINEER:** 

TRC COMPANIES 2 BAYPORT WAY, NEWPORT NEWS, 319 E PLUME STREET NORFOLK, VA 23510

### SHEET INDEX: DEMOLITION SITE PLAN

		PHASE VII DEMOLITION PLAN		
E .	Sheet Number	Sheet Name	Revisions	Date
西有			•	
	T100	TITLE SHEET		
	G-001	COVER SHEET		
	G-002	GENERAL NOTES ABBREVATION AND LEGEND		
-	G-003	EROSION AND SEDIMENT CONTROL NOTES		
	V-101	TOPOGRAPHIC SURVEY		
-	V-102	TOPOGRAPHIC SURVEY		
3	V-103	TOPOGRAPHIC SURVEY		
M.	C-100	OVERALL LAYOUT AND SHEET INDEX		
-	CD101	DEMOLITION AND E&S PHASE I PLAN		
- 1	CD102	DEMOLITION AND E&S PHASE I PLAN		
	CD103	DEMOLITION AND E&S PHASE I PLAN		
30	CS101	LAYOUT AND GRADING PLAN		
	CS102	LAYOUT AND GRADING PLAN		
FREE	CS103	LAYOUT AND GRADING PLAN		
	C-500	DETAILS		
EET	C-501	NEWPORT NEWS STORMWATER SUMMARY		
	C-502	DRAINAGE AREA PROPOSED CONDITION		
	C-503	DRAINAGE AREA PROPOSED CONDITION		

### SHEET INDEX NOTES FOR REFERENCE DOCUMENTATION SCHEDULES

1940 ORIGINAL CONSTRUCTION DRAWING SET:
This drawing set provides all available documentation of the original construction for buildings B, D2, D3, & D4. All construction that has occurred on the site after the 1940 has been built over this structure and therefor these drawings will provide insight into what the phase IIV project will encounter throughout the demolition process.

# 1984 STRUCTURAL RENOVATIONS SET: This set provides information from the 1984 structural renovations that were completed on buildings B, D2, D3, & D4 and

includes only the relevant CDs from the original set.

1992 COMPREHENSIVE RENOVATION - INTERIORS SET:
This set of CDs provide detailed drawings of all interior updates that occurred in the overall renovation that underwent in 1992.



319 E Plume Street Norfolk, VA 23510 757 627 1489

viadesignarchitects.com

### SHEET INDEX: REFERENCE PLANS

PLANTING PLANS - BLOCK 2 - NO.33 (40')

1940 ORIGINAL CONSTRUCTION DRAWING REF. SET 1				
Sheet Number	Sheet Name			
A-201	ARCHITECTURAL SITE PLAN - NO.5 (40')			
A-202	PLAN OF BLOCK 1 - NO.6 (40')			
A-203	PLAN OF BLOCK 2 - NO.7 (40')			
A-207	BUILDING B - NO.11 (40')			
A-210	BUILDING D3 PLANS, ELEVATIONS & DETAILS - NO.14 (40')			
A-211	BUILDING D4 PLANS, ELEVATIONS & DETAILS - NO.15 (40')			
A-212	TYPICAL CROSS SECTION - NO.16 (40')			
A-213	ROOF, LEADER & MISC. DETAILS - NO.17 (40')			
A-214	DOOR, WINDOW, & PARTITION DETAILS - NO.18 (40')			
A-15	STAIR DETAILS - NO.19 (40')			
PH-402	BUILDING A, B, &D – PLUMBING & HEATING - NO.27 (40')			
PH-403	BUILDING D2, D3, D4 & UNIT PLANS – PLUMBING & HEATING - NO.28 (40')			
P-404	GAS DISTRIBUTION SITE PLAN - NO.28A (40')			
E-501	BUILDING A, B & UNIT PLANS – ELECTRICAL PLANS - NO.29 (40')			
E-502	BUILDING D2, D3, D4 – ELECTRICAL PLANS - NO.30 (40')			
L-701	PLANTING PLANS – BLOCK 1 - NO.32 (40')			

Sheet Number	Sheet Name	
C - 0	TITLE PG MARSHALL COURTS & ORCUTT HOMES 1984 (84')	
C - 1	MARSHALL COURTS – BUILDING LOCATION PLAN (84')	
C - 2	SITE PLAN – BUILDINGS 13-18 & 35-40 (84')	
C - 5	SITE PLAN - BUILDINGS 9-12, 25-34 & 71-75 (84')	
C - 6	ORCUTT HOMES - BUILDING LOACATION PLAN (84')	
A - 1	BUILDINGS 1 - 24 ELEVATIONS (84')	
A - 4	BUILDINGS 25-34 & 75 ELEVATIONS (84')	
A - 5	WALL SECTIONS, DETAI LS (84')	
A - 6	TYPICAL DETAILS (84')	
A- 7	MISC. DETAILS (84')	
P - 1	ORCUTT HOMES - PLUMBING PLAN, TYPICAL DETAILS, LEGEND, NOTES (84')	
P-2	ORCUTT HOMES - PLUMBING PLAN, DIAGRAMS (84')	
E - 1	ELECTRICAL DISTRIBUTION PLAN (84')	

1984 STRUCTURAL RENOVATIONS REF. SET 2

ELECTRICAL RISER DIAGRAM, LIGHTING FIXTURE SCHEDULE (84')				
4000 COMPREHENCIVE DENOVATION. INTERIORO DEF. OF	_			

ELECTRICAL LEGEND, SCHEDULES & DETAILS (84')

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Number	Sneet Name
C1	SITE PLAN KEY (92')
C6	DETAIL SHEET (92')
A5	BUILDING TYPE B – FLOOR PLANS (NEW WORK) (92')
A6	BUILDING TYPE B – FLOOR PLANS (NEW WORK) (92')
A7	BUILDING TYPE A & B – BUILDING SECTIONS & DETAILS (92')
A8	BUILDING TYPE D2 – FLOOR PLANS (DEMOLITION & NEW WORK) (92')
A9	BUILDING TYPE D3 – FLOOR PLANS (DEMOLITION & NEW WORK) (92')
A10	BUILDING TYPE D2 & D3 – BUILDING SECTIONS, PARTIAL PLANS & DETAILS (92')
A11	BUILDING TYPE D4 – FLOOR PLANS (DEMOLITION & NEW WORK) (92')
A14	BUILDING TYPE D2 – FLOOR PLANS (DEMOLITION & NEW WORK) (92)  BUILDING TYPE D2 – FLOOR PLANS (DEMOLITION & NEW WORK HANDICAPPED CONVERSION) (92')
A15	BUILDING TYPE D3 – FLOOR PLANS (DEMOLITION & NEW WORK HANDICAPPED CONVERSION) (92')
A16	BUILDING TYPE D2 & D3 – ROOF FRAMING DETAIL (92')
A17	DOOR SCHEDULE, DOOR TYPES, & NOTES (92')
A18	DOOR & WINDOW DETAILS (92')
A19	CASEWORK ELEVATIONS, SECTIONS, & DETAILS (92')
P5	BUILDING TYPE B – FLOOR PLANS (NEW WORK) (92')
P6	BUILDING TYPE B – FLOOR PLANS (NEW WORK) (92')
P7	BUILDING TYPE D2 – FLOOR PLANS (DEMOLITION & NEW WORK) (92')
P8	BUILDING TYPE D3 – FLOOR PLANS (DEMOLITION & NEW WORK) (92')
P9	BUILDING TYPE D4 – FLOOR PLANS (DEMOLITION & NEW WORK) (92')
P11	BUILDING TYPE D2 - FLOOR PLANS (DEMOLITION & NEW WORK & HANDICAPPED CONVERSION) (92')
P12	BUILDING TYPE D3 - FLOOR PLANS (DEMOLITION & NEW WORK & HANDICAPPED CONVERSION) (92')
P14	RECREATION BUILDING & TYPE D4 RISER DIAGRAMS (92')
M5	BUILDING TYPE B – FLOOR PLANS (NEW WORK) (92')
M6	BUILDING TYPE B – FLOOR PLANS (NEW WORK) (92')
M7	BUILDING TYPE D2 - FLOOR PLANS (DEMOLITION & NEW WORK) (92')
M8	BUILDING TYPE D3 – FLOOR PLANS (DEMOLITION & NEW WORK) (92')
M9	BUILDING TYPE D4 – FLOOR PLANS (DEMOLITION & NEW WORK) (92')
M11	BUILDING TYPE D2 - FLOOR PLANS (DEMOLITION & NEW WORK & HANDICAPPED CONVERSION) (92')
M12	BUILDING TYPE D3 - FLOOR PLANS (DEMOLITION & NEW WORK & HANDICAPPED CONVERSION) (92")
M14	BUILDING MECHANICAL EQUIPMENT ROOM PLANS AND SECTIONS (92')
M17	BUILDING TYPE A & B SECTIONS & UNIT PIPING DETAILS (92')
M18	LEGEND. & SCHEDULES (92')
M19	SCHEDULES (92')
M20	MECHANICAL DETAILS (92')
E5	BUILDING TYPE B – FLOOR PLANS (NEW WORK) (92')
E6	BUILDING TYPE B – FLOOR PLANS (NEW WORK) (92')
E7	BUILDING TYPE D2 – FLOOR PLANS (DEMOLITION & NEW WORK) (92')
E8	BUILDING TYPE D3 – FLOOR PLANS (DEMOLITION & NEW WORK) (92')
E9	BUILDING TYPE D4 – FLOOR PLANS (DEMOLITION & NEW WORK) (92')

E11 BUILDING TYPE D2 – FLOOR PLANS (DEMOLITION & NEW WORK & HANDICAPPED CONVERSION) (92') E12 BUILDING TYPE D3 – FLOOR PLANS (DEMOLITION & NEW WORK & HANDICAPPED CONVERSION) (92')

VIA PROJ #: 17031-4

CHECKED BY: SHEET STATUS: CONSTRUCTION DOCUMENT

KEY PLAN:

SHEET TITLE:

TITLE SHEET

BUILDING:

SHEET NUMBER:

1-1/2" = 1'-0"

# MARSHALL COURTS APARTMENTS, NNRHA, PHASE 7

# NEWPORT NEWS, VIRGINIA

### CONTACT INFORMATION:

DEVELOPER/OWNER FIRM: NEWPORT NEWS REDEVELOPMENT AND HOUSING

**NEWPORT NEWS, VA 23607** DAVID STALEY

TELEPHONE NO: (757) 928-6170

CIVIL ENGINEERING FIRM: TRC COMPANIES TIM DEAN, PE

2 BAYPORT WAY, NEWPORT NEWS, VA 23606 ADDRESS: TELEPHONE NO. (757) 290-4602

TDEAN@TRCCOMPANIES.COM

SITE DATA

ADDRESS:

SITE LOCATION: 741 34TH STREET

NEWPORT NEWS, VA 23607 PARCEL ID:

ZONING: **OVERLAY DISTRICT NEIGHBORHOOD CONSERVATION DISTRICT** 

**CURRENT USE: OPEN SPACE** PROPOSED USE:

FEMA FIRM #:

5101030181D (EFFECTIVE 12/9/2014) FEMA FLOOD ZONE FLOOD ZONE X

COORDINATES: 36.99434,-76.41941

### **BUILDING DATA:**

FRONT SETBACK: SIDE SETBACK (INTERIOR LOT):

R8 - (I) 10 FT INTERIOR LOT FOR TWO-FAMILY DWELLINGS, NO SIDE YARD IS REQUIRED AT THE

432 LF

R4 - 10% OF LOT WIDTH; BUT, NO MORE THAN 10

SIDE SETBACK (CORNER LOT): 30FT

REAR SETBACK:

### SITE STATISTICAL DATA:

40
••
40
•

### MARSHALL COURTS APARTMENTS, NNRHA, PHASE 7


LIMITS OF DISTURBANCE (SITE AREA):	219,869 SF	5.05 A
PRE-DEVELOPMENT IMPERVIOUS:	128,393 SF	2.95 A
PRE-DEVELOPMENT GREEN SPACE:	91,476 SF	2.10 A
POST-DEVELOPMENT IMPERVIOUS:	46,996 SF	1.08 A
POST DEVELOPMENT GREEN SPACE:	172,873 SF	3.97 A
ON SITE:	207,237 SF	4.76 A
WITHIN ROW:	12,632 SF	0.29 A
34TH STREET:	332 LF	
35TH STREET:	1,030 LF	
36TH STREET:	732 LF	

### MARSHALL COURTS RENOVATIONS:

MADISON AVE:


LIMITS OF DISTURBANCE (SITE AREA):	98,446 SF	2.26 AC
PRE-DEVELOPMENT IMPERVIOÚS:	53,001 SF	1.217 A
PRE-DEVELOPMENT GREEN SPACE:	45,445 SF	1.043 A
POST-DEVELOPMENT IMPERVIOUS:	57,499 SF	1.320 A
POST DEVELOPMENT GREEN SPACE:	40,947 SF	0.940 A
ON SITE:	98,131 SF	2.253 A
WITHIN ROW:	315 SF	0.007 A

SANITARY SEWER FLOW: NOTE: NO CONNECTION PROPOSED.

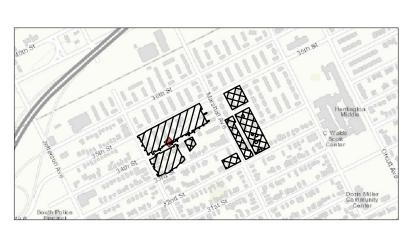

MARSHALL COURTS PHASE 7 LIMITS OF DISTURBANCE/SITE AREA = 5.05 AC

MARSHALL COURTS RENOVATIONS LIMITS OF DISTURBANCE/SITE AREA = 2.26 AC

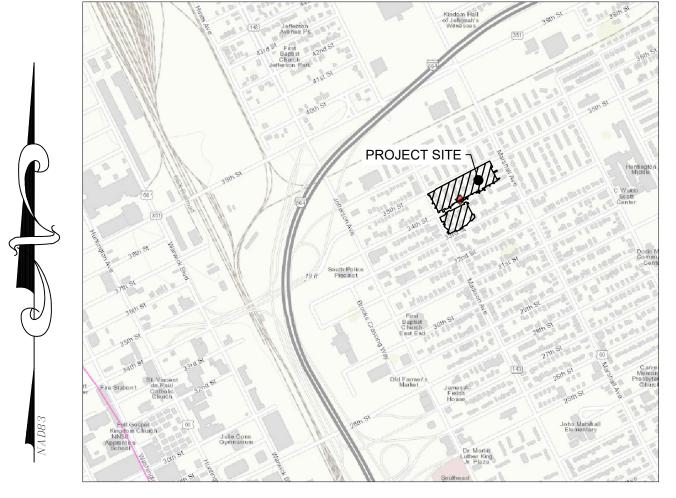

**VICINITY MAP** 1"=1000'

THIS PROJECT INCLUDES THE DEMOLITION OF EXISTING RESIDENTIAL BUILDINGS AND ASSOCIATED HARDSCAPE FEATURES. THIS WILL RESULT IN A REDUCTION OF IMPERVIOUS AREA BY 1.77 ACRES. BUILDING REMOVAL

	SHEET LIST TABLE
NUMBER	TITLE
G-001	COVER SHEET
G-002	GENERAL NOTES ABBREVATION AND LEGEND
G-003	EROSION AND SEDIMENT CONTROL NOTES
V-101	TOPOGRAPHIC SURVEY
V-102	TOPOGRAPHIC SURVEY
V-103	TOPOGRAPHIC SURVEY
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CD103	DEMOLITION AND E&S PHASE I PLAN
CS101	LAYOUT AND GRADING PLAN
CS102	LAYOUT AND GRADING PLAN
CS103	LAYOUT AND GRADING PLAN
C-500	DETAILS
C-502	DRAINAGE AREA EXISTING CONDITION
C-503	DRAINAGE AREA PROPOSED CONDITION

CITY APPROVAL STAMPS

I HEREBY CERTIFY THAT I AM THE RESPONSIBLE LAND DISTURBER FOR THIS PROJECT AND THAT I HAVE A VALID CERTIFICATION FROM THE STATE OF VIRGINIA

Vimothy K. Da-	VA PE LIC. # 041397
SIGNATURE	CERTIFICATION #
TIMOTHY K. DEAN	08/07/2024
NAME (PRINT)	DATE

RESPONSIBLE LAND DISTURBER (RLD) FOR THE PURPOSES OF PLAN REVIEW IS TIMOTHY K. DEAN, PE OF TRC, PE#041397. CONTRACTOR TO PROVIDE THE RLD NAME AND CERTIFICATION NUMBER OF THE INDIVIDUAL OF RESPONSIBLE CHARGE PRIOR TO CONSTRUCTION.

\* \* \* \* \* \* \*

THESE DOCUMENTS, INCLUDING DRAWINGS AND SPECIFICATIONS, WERE PREPARED BY TRC COMPANIES, PURSUANT TO A CONTRACT BY AND BETWEEN TRC AND VIA DESIGN ARCHITECTS, INC. WITH RESPECT TO THE PROJECT DESCRIBED IN SAID CONTRACT. ANY REUSE OR MODIFICATION OF SAID DOCUMENTS (WHETHER HARD COPY OR ELECTRONIC) WITHOUT WRITTEN VERIFICATION OR ADAPTATION BY TRC FOR THE SPECIFIC PURPOSE INTENDED WILL BE AT THE SOLE RISK OF THE INDIVIDUAL OR ENTITY UTILIZING SAID DOCUMENTS, DRAWINGS AND SPECIFICATIONS AND SUCH USE IS WITHOUT THE AUTHORIZATION OF TRC. TRC, SHALL HAVE NO LEGAL LIABILITY RESULTING FROM ANY AND ALL CLAIMS, DAMAGES, LOSSES, AND EXPENSES, INCLUDING ATTORNEY'S FEES ARISING OUT OF THE UNAUTHORIZED USE OF THESE DOCUMENTS, DRAWINGS, SPECIFICATIONS, REPORTS, AND STUDIES PREPARED AS A RESULT OF THE AFORESAID CONTRACT.

Vimothy N. Den	VA PE LIC. # 041397
SIGNATURE	CERTIFICATION #
TIMOTHY K. DEAN	08/07/2024
NAME (PRINT)	DATE

AUGUST 7, 2024

DAA PROJECT #2100194-010306

\* \* \* \* \* \* \*

NOTE: CONTRACTOR TO CONTACT MISS UTILITY (811) IN ADVANCE OF PLANNED WORK. ADVANCE TIME PERIOD SHALL BE IN ACCORDANCE WITH CURRENT MISS UTILITY GUIDELINES

(www.missutilityofvirginia.com).

001

**REVISIONS** 

DESIGNED BY:

PROJECT NUMBER:

AUGUST 7, 2024

2100194

G-00<sup>-</sup>

# **GENERAL NOTES:**

- AFTER OBTAINING THE LAND DISTURBING PERMIT AND AT LEAST 48 HOURS PRIOR TO ANY LAND DISTURBING ACTIVITY, THE CONTRACTOR SHALL CONTACT PLANNING/CIVIL INSPECTIONS AT 757-933-2311 TO SCHEDULE A PRE-CONSTRUCTION MEETING. FAILURE TO CONTACT PLANNING/CIVIL INSPECTIONS PRIOR TO ANY LAND DISTURBING ACTIVITY MAY RESULT IN A STOP WORK ORDER OR OTHER LEGAL ACTION. CITY REFUSE COLLECTION WILL NOT BE PROVIDED TO THIS SITE.
- RIGHT-OF-WAY DEDICATIONS (YES/NO)
- THE PROPERTY SHOWN HEREON IS LOCATED IN FLOOD ZONE X BASED ON A SCALED LOCATION ON FIRM PANEL #5101030181D (EFFECTIVE DATE 12/9/2014). THIS FLOOD DETERMINATION IS NOT A RECOMMENDATION BY TRC/DRAPER ADEN ASSOCIATES TO NOT PURCHASE OR PURCHASE FLOOD INSURANCE COVERAGE AND DOES NOT IMPLY THAT THE REFERENCED PROPERTY WILL OR WILL NOT BE FREE FROM FLOOD DAMAGE.
- HORIZONTAL DATUM: THIS PLAN IS BASED ON THE VIRGINIA STATE PLANE COORDINATE SYSTEM, SOUTH ZONE, NAD 1983/1993 (HARN).
- COORDINATE VALUES SHOWN ARE EXPRESSED IN U.S. SURVEY FEET. VERTICAL CONTROL: THIS PLAN IS BASED ON NAVD, 1988.
- ALL EXCAVATED MATERIAL SHALL BE DISPOSED OF IN A LAWFUL MANNER.
- 8. ANY AND ALL MATERIALS OR DEBRIS TRACKED ONTO A PUBLIC OR PRIVATE ROAD SURFACE WILL BE REMOVED THOROUGHLY AT THE END OF EACH DAY. SEDIMENT SHALL BE REMOVED FROM THE ROADS BY SHOVELING OR SWEEPING AND WILL BE TRANSPORTED TO A SEDIMENT CONTROLLED DISPOSAL AREA.
- 9. THE CERTIFYING DESIGN PROFESSIONAL IS RESPONSIBLE AND LIABLE FOR THE DESIGN AND THE CONTENTS OF THIS APPROVED PLAN.
- 10. THIS PROPERTY IS LOCATED WITHIN THE NEIGHBORHOOD CONSERVATION DISTRICT.
- 11. WATER METERS: CONTRACT WATERWORKS REGARDING DEMOLITION OR DISCONNECT OF EXISTING WATER METERS PRIOR TO BEGINNING DEMOLITION.

- 2. DIMENSIONS AT BUILDING ARE TO OUTSIDE FACE, UNLESS OTHERWISE INDICATED.
- THE CONTRACTOR SHALL SECURE ALL NECESSARY PERMITS FOR THIS PROJECT FROM THE CITY OF NEWPORT NEWS OR STATE AGENCIES.
- THE BUILDING PERMIT WILL BE OBTAINED AND PAID FOR BY THE OWNER. ALL OTHER PERMITS, LOCAL LICENSE FEES, BUSINESS FEES, TAXES, OR SIMILAR ASSESSMENTS IMPOSED BY THE APPROPRIATE POLITICAL SUBDIVISION SHALL BE OBTAINED AND PAID FOR BY THE CONTRACTOR.
- ALL PAVING MATERIALS AND DRAINAGE STRUCTURES SHALL BE BUILT AND INSTALLED IN ACCORDANCE WITH VIRGINIA DEPARTMENT OF TRANSPORTATION STANDARDS AND SPECIFICATIONS.
- 6. THE LOCATION OF EXISTING SEWER, WATER OR GAS LINES, CONDUITS OR OTHER STRUCTURES ACROSS, UNDERNEATH, OR OTHERWISE ALONG THE LINE OF PROPOSED WORK ARE NOT NECESSARILY SHOWN ON THE PLANS, AND IF SHOWN ARE ONLY APPROXIMATE. CONTRACTOR SHALL VERIFY LOCATION AND ELEVATION OF ALL UNDERGROUND UTILITIES SHOWN ON THE PLANS IN AREAS OF CONSTRUCTION PRIOR TO STARTING WORK. CONTACT ENGINEER IMMEDIATELY IF LOCATION OR ELEVATION IS DIFFERENT FROM THAT SHOWN ON THE PLANS, IF THERE APPEARS TO BE A CONFLICT, OR UPON DISCOVERY OF ANY UTILITY NOT SHOWN ON THE PLANS. FOR ASSISTANCE IN LOCATING EXISTING UTILITIES CALL "MISS UTILITY", 1-800-552-7001.
- WHERE PAVEMENT IS BEING REMOVED, THE CONTRACTOR SHALL REMOVE AGGREGATE BASE
- DAMAGE TO UTILITIES (INCLUDING UNDERGROUND) OR PROPERTY OF OTHERS BY CONTRACTOR DURING CONSTRUCTION SHALL BE REPAIRED TO PRECONSTRUCTION CONDITIONS BY CONTRACTOR AT NO COST TO OWNER.
- 9. EXISTING PAVEMENT AND OTHER SURFACES DISTURBED BY CONTRACTOR (WHICH ARE NOT TO BE REMOVED) SHALL BE REPAIRED TO LIKE-NEW CONDITION.
- 10. THE CONTRACTOR IS REQUIRED TO MAINTAIN ALL DITCHES, PIPES, AND OTHER DRAINAGE STRUCTURES FREE FROM OBSTRUCTION UNTIL WORK IS ACCEPTED BY THE OWNER. THE CONTRACTOR IS RESPONSIBLE FOR ANY DAMAGES CAUSED BY FAILURE TO MAINTAIN DRAINAGE STRUCTURES IN OPERABLE CONDITION.
- 11. THE CONTRACTOR SHALL HAVE A SET OF APPROVED PLANS AVAILABLE AT THE SITE AT ALL TIMES WHEN WORK IS BEING PERFORMED. A DESIGNATED RESPONSIBLE EMPLOYEE SHALL BE AVAILABLE FOR CONTACT BY INSPECTORS.
- 12. LANDSCAPING AND SITE IMPROVEMENTS WILL BE INSTALLED AND MAINTAINED SO AS NOT TO INTERFERE WITH SIGHT DISTANCE NEEDS OF DRIVERS WITHIN THE PARKING AREA AND AT ENTRANCE/EXIT LOCATIONS.
- 13. THE CONTRACTOR SHALL NOTIFY THE CITY ENGINEER AT LEAST 24 HOURS PRIOR TO STARTING WORK ON THIS PROJECT.
- 14. THE CONTRACTOR AND/OR THE DEVELOPER IS RESPONSIBLE FOR THE COST OF REPAIR OR REPLACEMENT OF ANY TRAFFIC CONTROL EQUIPMENT THAT EITHER NEEDS TO BE RELOCATED OR THAT IS DAMAGED AS A RESULT OF THIS PROJECT. ANY WORK INVOLVING THE TRAFFIC CONTROL EQUIPMENT SHALL BE COORDINATED THROUGH THE CITY OF NEWPORT NEWS TRAFFIC ENGINEERING.
- 15. VERIFY THE PROPOSED LAYOUT WITH ITS RELATIONSHIP TO THE EXISTING SITE SURVEY. ALSO VERIFY ALL DIMENSIONS, SITE CONDITIONS, AND MATERIAL SPECIFICATIONS AND NOTIFY THE OWNER AND ENGINEER OF ANY ERRORS, OMISSIONS, OR DISCREPANCIES BEFORE COMMENCING OR PROCEEDING WITH WORK.
- 16. DEVIATIONS FROM, OR CHANGES TO THESE PLANS WILL NOT BE ALLOWED, UNLESS OTHERWISE APPROVED BY THE CITY OF NEWPORT NEWS, DEPARTMENT OF ENGINEERING.
- 17. MAKE EXPLORATORY EXCAVATIONS AND LOCATE EXISTING UTILITIES SUFFICIENTLY AHEAD OF CONSTRUCTION TO PERMIT REVISIONS TO THE PLANS IF NECESSARY. THE EXISTENCE AND/OR LOCATION OF UTILITIES SHOWN ON THESE PLANS MAY BE ONLY APPROXIMATELY CORRECT. TAKE PRECAUTIONARY MEASURES TO PROTECT THE UTILITIES SHOWN HEREON AND ANY OTHER EXISTING UTILITIES NOT OF RECORD OR NOT SHOWN ON THESE PLANS. REPAIR AT YOUR OWN EXPENSE, ANY EXISTING UTILITIES DAMAGED DURING CONSTRUCTION. IF A UTILITY IS DAMAGED DURING CONSTRUCTION, STOP WORK IMMEDIATELY AND NOTIFY THE ENGINEER.
- 18. PROPERLY SECURE THE CONSTRUCTION AREA AT ALL TIMES AGAINST UNAUTHORIZED ENTRY AND ADEQUATELY PROTECT EQUIPMENT, MATERIALS, AND COMPLETED WORK FROM THEFT AND VANDALISM. THE OWNER IS NOT RESPONSIBLE FOR THE LOSS OF ANY MATERIAL STORED AT THE SITE.
- 19. ASSUME SOLE AND COMPLETE RESPONSIBILITY FOR JOB SITE CONDITIONS DURING THE COURSE OF CONSTRUCTION OF THIS PROJECT INCLUDING SAFETY OF ALL PERSONS AND PROPERTY. THIS REQUIREMENT SHALL APPLY CONTINUOUSLY AND NOT BE LIMITED TO NORMAL WORKING HOURS; AND SHALL DEFEND, INDEMNIFY, AND HOLD THE OWNER AND THE ENGINEER HARMLESS FROM ANY AND ALL LIABILITY, REAL AND ALLEGED, IN CONNECTION WITH THE PERFORMANCE OF WORK ON THIS PROJECT, EXCEPT FOR LIABILITY ARISING FROM "THE SOLE NEGLIGENCE OF THE OWNER OR THE ENGINEER."
- 20. ALL TURF AREAS THAT ARE IMPACTED OR DISTURBED BY VEHICLES, EQUIPMENT, OR ACTIVITY SHALL BE REPAIRED, REGRADED, AND RESEEDED TO THE SATISFACTION OF THE OWNER.
- 21. PERFORM ALL WORK USING DIMENSIONS SHOWN ON THESE PLANS. DO NOT USE SCALES, RULERS, DIVIDERS, MAP WHEELS OR OTHER MEASURING DEVICES TO DETERMINE SPATIAL RELATIONSHIPS ON THESE DRAWINGS.
- 22. ALL UNSUITABLE MATERIAL SHALL BE REMOVED FROM THE CONSTRUCTION LIMITS OF PAVED
- 23. CONTRACTOR SHALL THOROUGHLY CLEAN SEWER LINES FROM 5' OUTSIDE OF BUILDING TO NEXT DOWNSTREAM MANHOLE OR CLEAN OUT PRIOR TO TURNING PROJECT OVER TO OWNER. COORDINATE WITH ARCHITECTURAL AND PLUMBING DRAWINGS.
- 24. TOPOGRAPHIC SURVEY USED FOR THESE PLANS WAS PREPARED BY DRAPER ADEN ASSOCIATES AND ALL EXISTING SPOT ELEVATIONS SHOWN ARE BASED ON THIS TOPOGRAPHIC SURVEY.

### **GRADING NOTES**

ALL SPOT ELEVATIONS NOTED WITH "MG" ARE INTENDED TO MATCH EXISTING GRADE. SPECIFIED ELEVATIONS ARE APPROXIMATE BASED ON THE TOPOGRAPHIC SURVEY. CONTRACTOR TO FIELD VERIFY AND NOTIFY THE ENGINEER OF RECORD OF ANY DEVIATION.

CITY OF NEWPORT NEWS GENERAL NOTES:

CONSTRUCTION

1. ALL CONSTRUCTION METHODS AND MATERIALS SHALL CONFORM WITH THE CURRENT NEWPORT NEWS DESIGN CRITERIA MANUAL, VDOT STANDARDS AND SPECIFICATIONS, VDOT ROAD AND BRIDGES STANDARDS AND SPECIFICATIONS, LATEST EDITION OF THE HAMPTON ROADS PLANNING DISTRICT COMMISSION (HRPDC) REGIONAL CONSTRUCTION STANDARDS, THE NEWPORT NEWS SPECIAL PROVISIONS OF THE HRPDC REGIONAL CONSTRUCTION STANDARDS, THE STORMWATER MANAGEMENT HANDBOOK, VIRGINIA DEQ STORMWATER DESIGN SPECIFICATIONS, VIRGINIA EROSION AND SEDIMENT CONTROL REGULATIONS AND ANY OTHER APPLICABLE CITY OR STATE ORDINANCE, CODE AND/OR LAW.

2. EXTERIOR CONCRETE SHALL BE VIRGINIA DEPARTMENT OF TRANSPORTATION (VDOT) CLASS A3. 3. THE CONTRACTOR SHALL BE RESPONSIBLE FOR LOCATING AND PROTECTING ALL EXISTING UTILITIES WHETHER OR NOT THEY ARE SHOWN ON THE PLAN. THE CONTRACTOR SHALL REPAIR, AT THEIR OWN EXPENSE, ALL UTILITIES DAMAGED BY CONSTRUCTION ACTIVITIES. THE CONTRACTOR SHALL FOLLOW ALL "MISS UTILITIES OF VIRGINIA" POLICIES PRIOR TO STARTING ANY CONSTRUCTION ACTIVITY 4. ALL COSTS ASSOCIATED WITH THE REQUIRED RELOCATION/ADJUSTMENT OF UTILITIES AND/OR OBSTRUCTIONS (POWER POLES, TELEPHONE PEDESTALS, GUY WIRES, WATER METERS, STREETLIGHTS, ETC.) DUE TO CONSTRUCTION OF THE PROJECT ARE THE RESPONSIBILITY OF THE

5. ALL COSTS ASSOCIATED WITH THE INSTALLATION AND UPGRADE OF STREETLIGHTS AND OTHER UTILITIES FOR THE CONSTRUCTION OF THE PROJECT ARE THE RESPONSIBILITY OF THE OWNER/DEVELOPER.

6. THERE SHALL BE ONE (1) R7-8 HANDICAP SIGN WITH AN ADDITIONAL PLATE READING "PENALTY \$100 - \$500 TOW-AWAY ZONE" PER HANDICAP PARKING SPACE PROVIDED. AT LEAST ONE (1) OUT OF EVERY EIGHT (8) HANDICAP SPACES SHALL BE VAN ACCESSIBLE. ALL DESIGNATED VAN ACCESSIBLE SPACES SHALL HAVE "VAN ACCESSIBLE" ADDED TO THE SIGN ASSEMBLY. THE REQUIRED HANDICAP SIGN ASSEMBLAGE SHALL BE MOUNTED IN ACCORDANCE WITH THE CURRENT ANSI A117.1 STANDARD FOR ACCESSIBLE AND USABLE BUILDINGS AND FACILITIES.

7. FIRE HYDRANTS MUST BE LOCATED SO THAT AT LEAST ONE HYDRANT IS CAPABLE OF REACHING THE REAR OF THE BUILDING. THE REQUIRED DISTANCES FROM THE FIRE HYDRANTS, AS WELL AS THE REQUIRED FIRE FLOW, IS SET BY THE CURRENT EDITION OF THE WATER DESIGN STANDARDS OF NEWPORT NEWS WATERWORKS. MINIMUM FIRE HYDRANT SPACING IS CURRENTLY EVERY 400 FEET FOR COMMERCIAL/INDUSTRIAL APPLICATION, AND EVERY 600 FEET FOR RESIDENTIAL

8. THE HYDRANT DISTANCES SHALL BE MEASURED BY AN APPROVED ROUTE AROUND THE EXTERIOR OF THE FACILITY OR BUILDING, AND SHALL BE MEASURED ALONG THE NATURAL AND UNOBSTRUCTED PATH OF VEHICLE TRAVEL.

9. ANY BUSHES, TREES, FENCING OR ANY OTHER POTENTIAL OBSTRUCTION SHALL BE IDENTIFIED AND BE A MINIMUM OF 3 FEET FROM FIRE HYDRANTS AND OTHER FIRE SUPPRESSION EQUIPMENT. 10. FIRE DEPARTMENT CONNECTIONS (FDC) SHALL BE LOCATED ON A STREET FRONT, A MINIMUM OF 40 FEET FROM THE BUILDING, AND

NO MORE THAN 100 FEET FROM A FIRE HYDRANT. 11. MINIMUM WIDTH OF ALL FIRE LANES SHALL BE 20 FEET UNLESS OTHERWISE APPROVED BY THE FIRE CODE OFFICIAL. MINIMUM HEIGHT OF CANOPIES (AND/OR OTHER ITEMS) THAT OVERHANG INTO THE FIRE LANE MUST BE 13 FEET AND 6 INCHES. FIRE LANES SHALL

BE SURFACED WITH HEAVY DUTY ASPHALT PER THE CURRENT CITY STANDARDS. 12. A FIRE APPARATUS ACCESS ROAD SHALL EXTEND TO WITHIN 150 FEET OF ALL PORTIONS OF THE BUILDING AND ALL PORTIONS OF THE EXTERIOR WALLS OF THE FIRST STORY OF THE BUILDING AS MEASURED BY AN APPROVED ROUTE AROUND THE EXTERIOR OF THE

BUILDING/FACILITY. (CERTAIN EXCEPTIONS. SUCH AS A FIRE SPRINKLER SYSTEM. MAY APPLY.) 13. FIRE APPARATUS ACCESS ROADS SHALL HAVE AN UNOBSTRUCTED WIDTH OF NOT LESS THAN 20 FEET UNLESS OTHERWISE REQUIRED BY THE FIRE CODE OFFICIAL AND AN UNOBSTRUCTED VERTICAL CLEARANCE OF 13 FEET 6 INCHES. THE FIRE CODE OFFICIAL IS AUTHORIZED TO REQUIRE MORE THAN ONE FIRE APPARATUS ACCESS ROAD BASED ON OCCUPANCY USE, LOCATION, ETC.

14. FIRE APPARATUS ACCESS ROADS SHALL BE DESIGNED AND MAINTAINED TO SUPPORT THE IMPOSED LOAD OF FIRE APPARATUS AND SHALL BE SURFACED TO ACCOMMODATE ALL WEATHER DRIVING CONDITIONS. (THE CURRENT MINIMUM WEIGHT LOAD UTILIZED FOR FIRE APPARATUS CALCULATION IS 80,000 POUNDS.) DEAD END FIRE APPARATUS ROADS IN EXCESS OF 150 FEET IN LENGTH SHALL BE PROVIDED WITH AN APPROVED AREA FOR TURNING AROUND FIRE APPARATUS. THE REQUIRED TURNING RADIUS OF A FIRE APPARATUS ACCESS ROAD SHALL BE DETERMINED BY THE FIRE CODE OFFICIAL. (THE CURRENT MINIMUM TURNING RADIUS FOR FIRE APPARATUS IS 29 FEET.)

15. AN APPROVED WATER SUPPLY FOR FIRE PROTECTION, EITHER TEMPORARY OR PERMANENT, SHALL BE MADE AVAILABLE AS SOON AS COMBUSTIBLE MATERIALS ARRIVE ON SITE.

16. APPROVED VEHICLE ACCESS FOR FIREFIGHTING SHALL BE PROVIDED TO ALL CONSTRUCTION OR DEMOLITION SITES. VEHICLE ACCESS SHALL BE PROVIDED TO WITHIN 100 FEET OF TEMPORARY OR PERMANENT FIRE DEPARTMENT CONNECTIONS. VEHICLE ACCESS SHALL BE PROVIDED BY EITHER TEMPORARY OR PERMANENT ROADS, CAPABLE OF SUPPORTING VEHICLE LOADING UNDER ALL WEATHER CONDITIONS. VEHICLE ACCESS SHALL BE MAINTAINED UNTIL PERMANENT FIRE APPARATUS ACCESS HAS BEEN FULLY CONSTRUCTED. SEWER

17. ALL PROPOSED PVC SANITARY SEWER PIPE AND FITTINGS SHALL BE ASTM 3034 SDR 26.

18. ALL PROPOSED DUCTILE IRON SANITARY SEWER PIPE SHALL BE MINIMUM THICKNESS CLASS 52.

19. ALL PROPOSED DUCTILE IRON SANITARY SEWER FORCE MAIN COMPACT FITTINGS SHALL HAVE A MINIMUM ACCEPTABLE PRESSURE RATING OF 250 PSI.

20. ALL SANITARY SEWER GRAVITY PIPES PLACED BELOW 10 FEET IN COVER OR LESS THAN 3 FEET IN COVER SHALL BE MADE OF DUCTILE

21. A NEWPORT NEWS STANDARD ACCESS POINT/CLEANOUT SHALL BE PLACED AT THE CITY RIGHT OF WAY FOR ALL SANITARY SEWER LATERALS. 22. ANY SANITARY SEWER GRAVITY LINE THAT CROSSES A WATER LINE WITH 18 INCHES OR LESS OF VERTICAL SEPARATION OR A MAIN THE RUNS PARALLEL TO A WATER LINE WITH LESS THAN 10 FEET OF SEPARATION, SHALL BE MADE OF DUCTILE IRON. 23. REINFORCED CONCRETE PIPE ARE REQUIRED IN AREAS SUBJECT TO TRAFFIC LOADS.

24. ALL PROPOSED ON-SITE PAVEMENT MARKINGS SHALL BE REFLECTORIZED TYPE A (PAINT) OR TYPE B (PREFORMED OR THERMOPLASTIC MATERIAL) IN ACCORDANCE WITH THE LATEST EDITION OF THE VDOT ROAD AND BRIDGE SPECIFICATIONS. PARKING SPACES SHALL BE DELINEATED BY 4-INCH WHITE LINES, (FEDERAL STANDARD COLOR #595-17886 OR EQUIVALENT), HANDICAPPED PARKING SPACES SHALL BE DELINEATED BY 4-INCH BLUE LINES (BENNETE'S PAINT BLUE WAVE Q13-28T OR EQUIVALENT) FOR SPACES AND SYMBOLS, FIRE LANES AND PARCEL PICK-UP MARKINGS SHALL BE 4-INCH YELLOW (FEDERAL STANDARD COLOR #595-13538 OR EQUIVALENT)

25. ALL PROPOSED PAVEMENT MARKINGS WITHIN CITY RIGHT OF WAY SHALL BE REFLECTORIZED TYPE B (PREFORMED OR THERMOPLASTIC MATERIAL) IN ACCORDANCE WITH THE LATEST EDITION OF THE VDOT ROAD AND BRIDGE SPECIFICATIONS AND AS OUTLINED IN THE NEWPORT NEWS/DEPARTMENT OF ENGINEERING'S "PAVEMENT MARKINGS - MATERIALS AND APPLICATIONS" SPECIFICATIONS EXCEPT AS OTHERWISE NOTED HEREIN. FEDERAL STANDARD COLOR #595-17886 OR EQUIVALENT SHALL DELINEATE WHITE MARKINGS, HANDICAPPED PARKING SPACES SHALL BE DELINEATED BY BENNETE'S PAINT BLUE WAVE Q13-28T OR EQUIVALENT FOR SPACES/SYMBOLS AND FEDERAL STANDARD COLOR #595-13538 OR EQUIVALENT SHALL DELINEATE YELLOW MARKINGS. ALL PERMANENT MARKINGS MUST BE SPOTTED AND FIELD VERIFIED BY THE CITY PRIOR TO INSTALLATION BY THE CONTRACTOR. 26. ALL PAVEMENT MARKINGS, SIGNAGE AND OTHER PERMANENT TRAFFIC CONTROL DEVICES DISTURBED DURING CONSTRUCTION ACTIVITIES SHALL BE REPLACED/REINSTALLED. THESE ITEMS MUST BE SPOTTED AND FIELD VERIFIED BY THE CITY PRIOR TO INSTALLATION BY THE CONTRACTOR.

**LANDSCAPING** 27. WITHIN LANDSCAPED AND GREEN AREAS, HEALTHY EXISTING TREES OF A MINIMUM 6-INCH DIAMETER AT BREAST HEIGHT, MEASURED AT LEAST 4 FEET AND 6 INCHES ABOVE GRADE, FOR SINGLE STEMMED, DECIDUOUS TREES, AND A MINIMUM OF 8 FEET IN HEIGHT FOR MULTI-STEMMED OR EVERGREEN TREES, SHALL BE RETAINED, PRESERVED AND PROTECTED DURING CONSTRUCTION. 28. ALL EXISTING TREES TO REMAIN ON-SITE, LOCATED WITHIN 50 FEET OF THE LIMITS OF CONSTRUCTION, MUST BE TREE PROTECTED IN

ACCORDANCE WITH THE CITY SITE REGULATIONS (CHAPTER 33.02 OF THE NEWPORT NEWS CODE OF ORDINANCES). 29. THE PROPERTY OWNER/DEVELOPER, AS APPLICABLE, SHALL BE RESPONSIBLE FOR THE PERPETUATION AND MAINTENANCE OF ALL SITE IMPROVEMENTS, INCLUDING LANDSCAPING, REQUIRED BY THE CITY SITE REGULATIONS (CHAPTER 33.02 OF THE NEWPORT NEWS CODE OF ORDINANCES) AND AS SHOWN ON THE APPROVED PLAN.

30. TREES MAY NOT BE SEVERELY TRIMMED BEYOND THE ANSI A300 STANDARDS FOR TREE CARE OPERATIONS AS AMENDED. IF TREES ARE SEVERELY PRUNED IN SUCH A WAY TO REMOVE 50% OR MORE OF THEIR HEIGHT/SPREAD, THEY WILL BE CONSIDERED DAMAGED AND SHALL BE REPLACED WITH TREES MEETING THE REQUIREMENTS OF CHAPTER 33.02 OF THE NEWPORT NEWS CODE OF ORDINANCES. LIGHTING

31. FOR THE FOLLOWING SITE USES: EDUCATIONAL, CHURCH, PARKS, RESIDENTIAL, MANUFACTURING OR INDUSTRIAL THE FOLLOWING LIGHTING NOTE MUST BE INCLUDED ON THE PLAN, "EXTERIOR LIGHTING MUST PROVIDE A MINIMUM ILLUMINATION LEVEL OF 0.6 FOOT-CANDLES FOR PARKING/DRIVING AREAS, 1.1 FOOT-CANDLES FOR OPEN WALKWAYS AND 4.3 FOOT-CANDLES FOR ENCLOSED WALKWAYS. LIGHTING MUST BE INSTALLED AND MAINTAINED IN ACCORDANCE WITH CURRENT NEWPORT NEWS REGULATIONS. LIGHTING SHALL BE DIRECTED INWARD TO THE SITE AND SHIELDED SO AS NOT TO ILLUMINATE OR PRODUCE GLARE ONTO ADJACENT PROPERTIES AND/OR ONTO THE CITY RIGHT OF WAY."

32. FOR ALL OTHER USES INCLUDING BUT NOT LIMITED TO: MEDICAL, OFFICE PARK, SHOPPING, WHOLESALE AND RETAIL THE FOLLOWING LIGHTING NOTE MUST BE INCLUDED ON THE PLAN, "EXTERIOR LIGHTING MUST PROVIDE A MINIMUM ILLUMINATION LEVEL OF 0.9 FOOT-CANDLES FOR PARKING/DRIVING AREAS, 2.2 FOOT-CANDLES FOR OPEN WALKWAYS AND 4.3 FOOT-CANDLES FOR ENCLOSED WALKWAYS. LIGHTING MUST BE INSTALLED AND MAINTAINED IN ACCORDANCE WITH CURRENT NEWPORT NEWS REGULATIONS. LIGHTING SHALL BE DIRECTED INWARD TO THE SITE AND SHIELDED SO AS NOT TO ILLUMINATE OR PRODUCE GLARE ONTO

ADJACENT PROPERTIES AND/OR ONTO THE CITY RIGHT OF WAYS." PERMITS AND PRE-CONSTRUCTION 33. FOR ANY LAND DISTURBING ACTIVITIES GREATER THAN 2,500 SQUARE FEET A LAND DISTURBANCE/VSMP PERMIT IS REQUIRED FROM

THE DEPARTMENT OF PLANNING.

34. FOR ANY LAND DISTURBANCE GREATER THAN 1 ACRE A CONSTRUCTION GENERAL PERMIT (CGP) IS REQUIRED. THE VIRGINIA STORMWATER MANAGEMENT PROGRAM (VSMP) AUTHORITY, NEWPORT NEWS, SHALL ISSUE THE LAND DISTURBANCE/VSMP PERMIT PRIOR TO ANY WORK. A STORMWATER POLLUTION PREVENTION PLAN (SWPPP) SHALL BE PREPARED FOR THE PROJECT AND A HARD COPY BE PRESENTED TO THE ENVIRONMENTAL SERVICES INSPECTOR AT THE PRE-CONSTRUCTION MEETING. 35. PRIOR TO CONSTRUCTION WITHIN ANY CITY RIGHT OF WAY, THE CONTRACTOR SHALL OBTAIN A RIGHT OF WAY PERMIT FROM THE DEPARTMENT OF PLANNING. THE OWNER/DEVELOPER OR THEIR REPRESENTATIVE SHALL SUBMIT AN ITEMIZED COST LIST OF THE WORK WITHIN THE CITY RIGHT OF WAY. A TEMPORARY TRAFFIC CONTROL PLAN SHALL BE SUBMITTED FOR REVIEW AND APPROVAL. 36. ALL TEMPORARY PAVEMENT MARKINGS, SIGNAGE AND OTHER TRAFFIC CONTROL DEVICES SHALL MEET THE FABRICATION AND/OR

INSTALLATION REQUIREMENTS OF THE MANUAL ON UNIFORM TRAFFIC CONTROL DEVICES (MUTCD), LATEST EDITION. 37. PRIOR TO ANY MOBILIZATION OR CONSTRUCTION ACTIVITY, THE CONTRACTOR SHALL REQUEST AND ATTEND A PRE-CONSTRUCTION MEETING WITH THE DEPARTMENT OF ENGINEERING'S CONSTRUCTION INSPECTOR AND THE ENVIRONMENTAL SERVICES INSPECTOR. TO REQUEST THE MEETING CALL 757-933-2311.

38. PRIOR TO INSTALLATION OF THE LANDSCAPING MATERIALS, AN INSPECTION WITH THE LANDSCAPE PLANNER IS REQUIRED. PLEASE CONTACT THE PLANNING DEPARTMENT AT 757-926-8761. 39. PLANS FOR AUTOMATIC SPRINKLER SYSTEMS SHALL BE REVIEWED AND APPROVED BY THE DEPARTMENT OF CODES COMPLIANCE

PRIOR TO INSTALLATION. 40. SIGNS ARE REVIEWED AND APPROVED UNDER A SEPARATE SUBMITTAL AND REVIEW BY THE DEPARTMENT OF CODES COMPLIANCE. 41. THE CITY MANAGER, OR DESIGNEE, CAN STOP SITE CONSTRUCTION, IMPROVEMENTS AND/OR ALTERATIONS IN THE EVENT OF ANY DEVIATION FROM THE APPROVED PLAN OR ON THE DISCOVERY OF UNEXPECTED ADVERSE IMPACTS OF THE DEVELOPMENT ACTIVITY ON ADJACENT PROPERTY OR PUBLIC FACILITIES.

**LEGEND** 

<b>EXISTING</b>		PROPOSED	<b>EXISTING</b>		PROPOSED
1000	CONTOURS	<del></del>	SCO	SANITARY CLEANOUT	•
× 1561.3	GROUND ELEVATION	TC 89.5	$\odot$	SANITARY MANHOLE	
× 1501.5	TREE LINE	BC 89.0	1	SANITARY STRUCTURE KEY	(1)
	DECIDUOUS TREE	N/A	uge	UNDERGROUND ELECTRIC -	UGE
	DECIDOO03 TREE	IN/A		LIGHT POLE	
	CONIFEROUS TREE	N/A	-0-	ELECTRIC POLE	•
	COMI ENCOC INCE		E	ELECTRIC MANHOLE	E
	SHRUB	N/A		WATER -	6" W
XX	FENCE	xx	——— fp	FIRE LINE -	8" FW
N/A	CONSTRUCTION FENCE	-0	$\otimes$	WATER VALVE	•
N/A	SAFETY FENCE	<del>-</del>	N/A	THRUST BLOCK	<b>-</b>
	PROPERTY LINE/ROW			FIRE HYDRANT	<b>-</b>
$\odot$	IRON ROD FOUND	N/A	⊖wM	WATER METER	<b>⊕</b>
	IRON ROD SET	N/A	© VVM	AIR RELEASE VALVE	•
	MONUMENT FOUND	N/A	(V)	WATER MANHOLE	<b>(</b>
	MONUMENT SET	N/A	catv	CABLE TV -	CATV
	EASEMENT		©	CABLE TV MANHOLE	©
	BENCHMARK	N/A	*	CABLE TV PEDESTAL	<b>⊞</b>
N/A	SITE DISTANCE LINE		ugt	UNDERGROUND TELEPHONE -	UGT
	BUILDING			TELEPHONE BOX	$\boxtimes$
Δ , , Δ , , , Δ , , , , , , , , , , , ,	CONCRETE	A	T	TELEPHONE MANHOLE	T
	SIGN	<del></del>	$\Diamond$	TELEPHONE PEDESTAL	$\Diamond$
0	BOLLARD	•	-0-	TELEPHONE POLE	•
-	BOREHOLE	<del>-</del>	g	GAS LINE -	G
	STORM SEWER	 		GAS DRIP	
0	STORM CLEANOUT	•		GAS METER	
	STORM MANHOLE	6	©	GAS MANHOLE	G
	STORM DRAINAGE INLET		<b>⊗</b> <sub>GV</sub>	GAS VALVE	•
$\overline{\langle 1 \rangle}$	STORM STRUCTURE KEY	$\langle 1 \rangle$	+ + + +	RESOURCE MANAGEMENT	
	CANITADY CEMED		+ + +	AREA (RMA)	

### ABBREVIATIONS AND **SYMBOLS**

SANITARY SEWER

### <u>SYMBOLS</u>

CY

D.B.

CENTERLINE PROPERTY LINE DIAMETER DEGREE

AREA ACRE(S) AMERICAN WATER WORKS ASSOCIATION BOTTOM OF CURB BLDG. BUILDING BOTT. BOTTOM CF **CUBIC FEET** CG **CURB AND GUTTER** C.I. CAST IRON CI **CURB INLET** CIP CAST IN PLACE CONSTRUCTION JOINT CLR. CLEAR C.O. **CLEANOUT** CONC. CONCRETE CONT. CONTINUOUS

CUBIC YARD(S)

DEED BOOK

M.J.

O.C.

DUCTILE IRON DROP INLET PB DIAMETER DS DOWNSPOUT PSI E.F. **EACH FACE** PVC ELEV. **ELEVATION** EOP EDGE OF PAVEMENT ES&C EROSION AND SEDIMENT CONTROL RD EX. EXISTING REQ'D. **EXPANSION** E.W. EACH WAY FACE OF CURB FINISHED FLOOR SPEC FLOW LINE FOOT (FEET) SPECS GΑ GAUGE SQ. GALV. STM GALVANIZED GS STD. **GROUND SHOT** ID INSIDE DIAMETER SW INV. INVERT SWM JOINT SY LAT LATERAL TC POUND LB TDC LBS POUNDS TEMP. LINEAR FOOT (FEET) TYP. MAT'L MATERIAL UNO MAX. MAXIMUM VAR. MFR. MANUFACTURER **VDOT** MG MATCH GRADE MH MANHOLE VESCH MIN. MINIMUM

MECHANICALLY JOINED

ON CENTER

**OUTSIDE DIAMETER** PARCEL BOOK PROPERTY LINE POUNDS PER SQUARE INCH POINT OF TANGENCY POLYVINYL CHLORIDE RADIUS REINFORCED CONCRETE PIPE ROOF DRAIN REQUIRED **RIGHT-OF-WAY** SLOPE SANITARY SQUARE FOOT (FEET) SPECIFICATION SPECIFICATIONS **SQUARE** STORM STANDARD SIDEWALK STORM WATER MANAGEMENT SQUARE YARD(S) TOP OF CURB TURNED DOWN CURB TEMPORARY TYPICAL UNLESS NOTED OTHERWISE VARIABLE VIRGINIA DEPARTMENT OF TRANSPORTATION VIRGINIA EROSION AND SEDIMENT CONTROL HANDBOOK WATER VALVE

WELDED WIRE FABRIC

SITE DISTANCE

**LEGEND** 

TIMOTHY K. DEAN Lic. No. 041397 08/07/2024

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NO.  $\geq$  $\triangleleft$ Д Ш BR  $\triangleleft$  $\triangleleft$ NOTE 0 Z

**REVISIONS** 

ESIGNED BY: RAWN BY:

HECKED BY:

SCALE: NONE AUGUST 7, 2024 ROJECT NUMBER:

G-002

2100194

		Erosion and Sediment Control Plan Minimum Standards (MS) Checklist - August 30, 2013	
<b>'es</b> X	No	WS1: Permanent or temporary soil stabilization shall be applied to denuded areas within seven days after final grade is reached on any portion of the site. Temporary soil stabilization shall be applied within seven days to denuded areas that may not be at final grade but will remain dormant for longer than 14 days. Permanent stabilization shall be applied to areas that are to be left dormant for more than one year.	Describe how MS is addressed on plan  The stabilization practices and limits of clearing an grading are shown on sheet CD100 and CS100.  The seeding specifications are provided on detail sheet C-500.
	Х	<b>MS2:</b> During construction of the project, soil stock piles and borrow areas shall be stabilized or protected with sediment trapping measures. The applicant is responsible for the temporary protection and permanent stabilization of all soil stockpiles on site as well as borrow areas and soil intentionally transported from the project site.	There are no soil stock piles or borrow areas proposed on site.
×		MS3: A permanent vegetative cover shall be established on denuded areas not otherwise permanently stabilized. Permanent vegetation shall not be considered established until a ground cover is achieved that is uniform, mature enough to survive and will inhibit erosion.	The requirements for establishing the permanent vegetative cover are provided on detail sheet C-50 and shown on sheet CG100.
ζ		<b>MS4:</b> Sediment basins and traps, perimeter dikes, sediment barriers and other measures intended to trap sediment shall be constructed as a first step in any land-disturbing activity and shall be made functional before upslope land disturbance takes place.	All measures intended to trap sediment during construction are shown on sheet CD100. As described in the sequence of construction on sheet G-004, all of these measures will be constructed a a first step in any land disturbing activity and will b made functional before upslope land disturbing takes place.
	Х	MS5: Stabilization measures shall be applied to earthen structures such as dams, dikes and diversions immediately after installation.	There are no earthen structures as part of this proposed development.
		<b>MS6:</b> Sediment traps and sediment basins shall be designed and constructed based upon the total drainage area to be served by the trap or basin. a. The minimum storage capacity of a sediment trap shall be 134 cubic yards per acre of drainage area and the trap shall only control drainage areas less	There are no sediment traps or sediment basins being proposed for this development.
	Х	than three acres.  b. Surface runoff from disturbed areas that is comprised of flow from drainage areas greater than or equal to three acres shall be controlled by a sediment basin. The minimum storage capacity of a sediment basin shall be 134 cubic yards per acre of drainage area. The outfall system shall, at a minimum, maintain the structural integrity of the basin during a 25-year storm of 24-hour duration. Runoff coefficients used in runoff calculations shall correspond to a bare earth condition or those conditions expected to exist while the sediment basin is utilized.	
	Х	<b>MS7:</b> Cut and fill slopes shall be designed and constructed in a manner that will minimize erosion. Slopes that are found to be eroding excessively within one year of permanent stabilization shall be provided with additional slope stabilizing measures until the problem is corrected.	There are no cut and fill slopes associated with the project.
	Х	MS8: Concentrated runoff shall not flow down cut or fill slopes unless contained within an adequate temporary or permanent channel, flume or slope drain structure.	There are no cut and fill slopes associated with the project.
	Х	MS9: Whenever water seeps from a slope face, adequate drainage or other protection shall be provided.	There are no cut and fill slopes associated with the project.
,		<b>MS10:</b> All storm sewer inlets that are made operable during construction shall be protected so that sediment-laden water cannot enter the conveyance system without first being filtered or otherwise treated to remove sediment.	Inlet protection is shown on sheet CD100 and CG100 for all inlets that will be operable during construction.
	Х	<b>MS11:</b> Before newly constructed stormwater conveyance channels or pipes are made operational, adequate outlet protection and any required temporary or permanent channel lining shall be installed in both the conveyance channel and receiving channel.	Stormwater for this project is discharging into a closed conduit system.
	Х	<b>MS12:</b> When work in a live watercourse is performed, precautions shall be taken to minimize encroachment, control sediment transport and stabilize the work area to the greatest extent possible during construction. Nonerodible material shall be used for the construction of causeways and cofferdams. Earthen fill may be used for these structures if armored by nonerodible cover materials.	There is no live watercourse within or adjacent to this proposed development.
	X	<b>MS13:</b> When a live watercourse must be crossed by construction vehicles more than twice in any six-month period, a temporary vehicular stream crossing constructed of nonerodible material shall be provided.	There is no live watercourse within or adjacent to this proposed development.
	Х	MS14: All applicable federal, state and local chapters pertaining to working in or crossing live watercourses shall be met.	There is no live watercourse within or adjacent to this proposed development.
	Х	MS15: The bed and banks of a watercourse shall be stabilized immediately after work in the watercourse is completed.	There is no live watercourse within or adjacent to this proposed development.
(		<ul> <li>MS16: Underground utility lines shall be installed in accordance with the following standards in addition to other applicable criteria:</li> <li>a. No more than 500 linear feet of trench may be opened at one time.</li> <li>b. Excavated material shall be placed on the uphill side of trenches.</li> <li>c. Effluent from dewatering operations shall be filtered or passed through an approved sediment trapping device, or both, and discharged in a manner that does not adversely affect flowing streams or off-site property.</li> <li>d. Material used for backfilling trenches shall be properly compacted in order to minimize erosion and promote stabilization.</li> <li>e. Restabilization shall be accomplished in accordance with this chapter.</li> <li>f. Applicable safety chapters shall be complied with.</li> </ul>	Location of underground utility lines are shown on sheet CU100. Details for the trenching and backfilling of utilities are included on the Sheet C-501, and the adjacent criteria will be followed during construction.
		MS17: Where construction vehicle access routes intersect paved or public roads, provisions shall be made to minimize the transport of sediment by vehicular tracking onto the paved surface. Where sediment is transported onto a paved or public road surface, the road surface shall be cleaned thoroughly at the end of each day. Sediment shall be removed from the roads by shoveling or sweeping and transported to a sediment control disposal area. Street washing shall be allowed only after sediment is removed in this manner. This provision shall apply to individual development lots as well as to larger land-disturbing activities.	A temporary construction entrance located at the point of vehicular ingress and egress on the construction site is shown on sheet CD100, and we be provided to reduce the soil transport onto the public roads and other paved areas. All material of debris tracked onto a public road surface will be cleaned thoroughly. Sediment will be removed from roads by shoveling and sweeping and it will be transported to a sediment-controlled disposal are
		MS18: All temporary erosion and sediment control measures shall be removed within 30 days after final site stabilization or after the temporary measures are no longer needed, unless otherwise authorized by the VESCP authority. Trapped sediment and the disturbed soil areas resulting from the disposition of temporary measures shall be permanently stabilized to prevent further erosion and sedimentation.	These requirements are specified in Managemen Strategies note #6 on sheet G-004.
		<ul> <li>MS19: Properties and waterways downstream from development sites shall be protected from sediment deposition, erosion and damage due to increases in volume, velocity and peak flow rate of stormwater runoff for the stated frequency storm of 24-hour duration in accordance with the following standards and criteria. Stream restoration and relocation projects that incorporate natural channel design concepts are not man-made channels and shall be exempt from any flow rate capacity and velocity requirements for natural or man-made channels:</li> <li>a. Concentrated stormwater runoff leaving a development site shall be discharged directly into an adequate natural or man-made receiving channel, pipe or storm sewer system. For those sites where runoff is discharged into a pipe or pipe system, downstream stability analyses at the outfall of the pipe or pipe system shall be performed.</li> <li>b. Adequacy of all channels and pipes shall be verified in the following manner: The applicant shall demonstrate that the total drainage area to the</li> </ul>	<ul> <li>a. Concentrated runoff leaving the site for the 10-year storm has been analyzed and is show to be less than that of the pre-development condition, removing the requirement to analyz the downstream system.</li> <li>b. As a result of a decrease in stormwater discharge from the site, the energy balance equation indicates that this project is in</li> </ul>
		point of analysis within the channel is one hundred times greater than the contributing drainage area of the project in question;  (a) Natural channels shall be analyzed by the use of a two-year storm to verify that stormwater will not overtop channel banks nor cause erosion of channel bed or banks.  (b) All previously constructed man-made channels shall be analyzed by the use of a ten-year storm to verify that stormwater will not overtop its	compliance with the requirement for having an adequate storm sewer system to discharge in c. The receiving man-made system was proven
		<ul> <li>banks and by the use of a two-year storm to demonstrate that stormwater will not cause erosion of channel bed or banks; and</li> <li>(c) Pipes and storm sewer systems shall be analyzed by the use of a ten-year storm to verify that stormwater will be contained within the pipe or system.</li> <li>c. If existing natural receiving channels or previously constructed man-made channels or pipes are not adequate, the applicant shall: 1) Improve</li> </ul>	be adequate for accepting the discharge from this site.
		the channels to a condition where a ten-year storm will not overtop the banks and a two-year storm will not cause erosion to channel the bed or banks; or 2) Improve the pipe or pipe system to a condition where the ten-year storm is contained within the appurtenances; Develop a site design that will not cause the pre-development peak runoff rate from a twoyear storm to increase when runoff outfalls into a natural channel or will not cause the predevelopment peak runoff rate from a ten-year storm to increase when runoff outfalls into a manmade channel; or Provide a combination of channel improvement, stormwater detention or other measures which is satisfactory to the VESCP authority to prevent	<ul> <li>d. Improvement to the receiving downstream system are not required.</li> <li>e. The drainage report considered both pre and post development conditions.</li> </ul>
		downstream erosion. d. The applicant shall provide evidence of permission to make the improvements.	f. A stormwater detention facility is not being proposed for this development.
		<ul> <li>e. All hydrologic analyses shall be based on the existing watershed characteristics and the ultimate development condition of the subject project.</li> <li>f. If the applicant chooses an option that includes stormwater detention, he shall obtain approval from the VESCP of a plan for maintenance of the detention facilities. The plan shall set forth the maintenance requirements of the facility and the person responsible for performing the</li> </ul>	g. Stormwater from this site discharges into a closed conduit system.
		<ul> <li>maintenance.</li> <li>g. Outfall from a detention facility shall be discharged to a receiving channel, and energy dissipators shall be placed at the outfall of all detention facilities as necessary to provide a stabilized transition from the facility to the receiving channel.</li> <li>h. All on-site channels must be verified to be adequate.</li> </ul>	h. No onsite channels are being proposed with the phase of the development.
		i. Increased volumes of sheet flows that may cause erosion or sedimentation on adjacent property shall be diverted to a stable outlet, adequate channel, pipe or pipe system, or to a detention facility.	Sheet flow is directed to an adequate pipe system.
		j. In applying these stormwater management criteria, individual lots or parcels in a residential, commercial or industrial development shall not be considered to be separate development projects. Instead, the development, as a whole, shall be considered to be a single development project. Hydrologic parameters that reflect the ultimate development condition shall be used in all engineering calculations.	j. The site is considered its own entity, and thus

II. detain and release over a 24-hour period the expected rainfall resulting from the one year, 24- hour storm; and

biological integrity of rivers, streams and other waters of the state.

I. detain the water quality volume and to release it over 48 hours;

Management Program (VSMP) Permit Regulations.

defined in any regulations promulgated pursuant to § 10.1-562 or 10.1-570 of the Act.

Permit Regulations shall be deemed to satisfy the requirements of Minimum Standard 19.

if the practices are designed to

All measures used to protect properties and waterways shall be employed in a manner which minimizes impacts on the physical, chemical and

requirements for natural or man-made channels shall satisfy the flow rate capacity and velocity requirements for natural or man-made channels

III. reduce the allowable peak flow rate resulting from the 1.5, 2, and 10-year, 24-hour storms to a level that is less than or equal to the peak

reduction factor that is equal to the runoff volume from the site when it was in a good forested condition divided by the runoff volume from the

site in its proposed condition, and shall be exempt from any flow rate capacity and velocity requirements for natural or man-made channels as

flow rate from the site assuming it was in a good forested condition, achieved through multiplication of the forested peak flow rate by a

n. For plans approved on and after July 1, 2014, the flow rate capacity and velocity requirements of § 10.1-561 A of the Act and this subsection

shall be satisfied by compliance with water quantity requirements in the Stormwater Management Act (§ 10.1-603.2 et seg. of the Code of

Virginia) and attendant regulations, unless such land-disturbing activities are in accordance with 4VAC50-60-48 of the Virginia Stormwater

Compliance with the water quantity minimum standards set out in 4VAC50-60-66 of the Virginia Stormwater Management Program (VSMP)

Any plan approved prior to July 1, 2014, that provides for stormwater management that addresses any flow rate capacity and velocity

### **EROSION CONTROL NARRATIVE**

THIS PROJECT IS GENERALLY DESCRIBED AS THE DEMOLITION OF EXISTING RESIDENTIAL BUILDINGS AND HARDSCAPE FEATURES ALONG WITH ASSOCIATED UTILITIES, CONVERTING THE DEVELOPED LAND INTO OPEN SPACE. THE TOTAL REDUCTION OF IMPERVIOUS AREA ASSOCIATED WITH THE DEMOLITION OF THE EXISTING DEVELOPMENT IS 1.87 ACRES.

THE EXISTING SITE CONDITION IS A MULTIPLE RESIDENTIAL BUILDINGS WITH ASSOCIATED HARDSCAPE FEATURES AND

### THE SOILS ON THE SITE, PER USDA NRCS SOIL MAPPING, ARE CLASSIFIED AS TOMOTLEY URBAN LAND COMPLEX. THE HYDROLOGIC SOIL GROUP IS B/D. THE K FACTOR IS MODERATE TO MODERATELY HIGH RANGING FROM 0.20 TO 1.98. THIS IS A DEMOLITION SITE WHICH REQUIRES THE REMOVAL OF HARD SURFACES. EXPOSED SOILS WILL BE ON A FLAT SURFACE ENVELOPED BY A SILT FENCE WITH LIMITED INGRESS EGRESS AT CONSTRUCTION ENTRANCES ONLY. THE DISTURBED

AREAS WILL BE SEEDED AS NEEDED.

THE SUBJECT PROPERTY IS BORDERED BY MADISON AVENUE TO THE WEST, 36TH STREET TO THE NORTH, 34TH STREET TO THE SOUTH, AND MARSHALL AVENUE TO THE EAST.

THERE ARE NO CRITICAL EROSION AREAS IDENTIFIED FOR THIS SITE.

TEMPORARY CONSTRUCTION ENTRANCE - 3.02 A STONE PAD, LOCATED AT THE POINT OF VEHICULAR INGRESS AND EGRESS TO THE CONSTRUCTION SITE. THE PURPOSE IS TO PREVENT OR REDUCE THE AMOUNT OF MUD TRANSPORTED TO THE PUBLIC ROAD. SEDIMENT DISLODGED OR WASHED FROM THE VEHICLE SHOULD BE CONTAINED WITHIN A PROPER SEDIMENT TRAPPING AREA. ALL VEHICLES ENTERING AND EXISTING A DISTURBED AREA SHALL USE THE ENTRANCE.

TO BE INSTALLED DOWN SLOPE OF DISTURBED AREAS TO FILTER SEDIMENT LADEN RUNOFF.

### INLET PROTECTION - 3.07

TO BE INSTALLED ON EXISTING INLETS PRIOR TO CONSTRUCTION AND ALL PROPOSED INLETS AS THEY ARE INSTALLED TO FILTER SEDIMENT LADEN RUNOFF BEFORE ENTERING STORM DRAIN INLETS AND PIPING SYSTEMS.

GENERAL: A PERMANENT VEGETATIVE COVER SHALL BE ESTABLISHED ON DENUDED AREAS NOT OTHERWISE PERMANENTLY STABILIZED BY CONCRETE, PAVEMENT OR LANDSCAPED MULCHED BEDS. PERMANENT VEGETATION SHALL NOT BE CONSIDERED ESTABLISHED UNTIL A GROUND COVER IS ACHIEVED THAT IS UNIFORM. MATURE ENOUGH TO SURVIVE AND WILL INHIBIT EROSION. NEW VEGETATION SHALL BE MAINTAINED FOR ONE FULL YEAR AFTER PLANTING. NEW SEEDING SHALL BE SUPPLIED WITH ADEQUATE MOISTURE, ESPECIALLY LATE IN THE SEASON, AND IN ABNORMALLY HOT OR DRY WEATHER. STABILIZATION PRACTICES SHALL BE ACCOMPLISHED IN ACCORDANCE WITH THE APPROPRIATE VESCH STD. & SPEC. AND AS PER THE EROSION AND SEDIMENT CONTROL PLAN. SELECTION OF THE APPROPRIATE SEED MIXTURE FOR TEMPORARY SEEDING WILL DEPEND UPON THE TIME OF YEAR IT IS APPLIED.

A 2" TO 4" LAYER OF TOPSOIL SHALL BE APPLIED TO ALL LANDSCAPED AND GRASSED AREAS. THE TOPSOIL SHALL BE FREE OF ROCKS AND DEBRIS. TOPSOIL ALLOWS A STRONGER AND HEALTHIER STAND OF GRASS TO ESTABLISH QUICKLY TO STABILIZE UNPAVED AREAS OF THE SITE.

### 2. TEMPORARY SEEDING - 3.31

TEMPORARY SEEDING SHALL BE APPLIED OVER ALL DISTURBED AREAS THAT WILL NOT BE BROUGHT TO FINAL GRADE WITHIN 14 DAYS. AREAS SHALL BE RESEEDED AS REQUIRED TO MAINTAIN A HEALTHY STAND OF VEGETATION WHICH IS CAPABLE OF PREVENTING EROSION. TEMPORARY SEEDING MIXES AND MAINTENANCE PROCEDURES SHALL BE AS DESCRIBED IN VESCH STD. & SPEC. 3.31.

### PERMANENT SEEDING - 3.32 PERMANENT SEEDING SHALL BE APPLIED TO ALL AREAS WITHIN SEVEN (7) DAYS OF ACHIEVING FINAL GRADE WHICH

WILL NOT RECEIVE HARDSCAPE OR OTHER LANDSCAPE. PERMANENT SEEDING SHALL ALSO BE USED ON ALL AREAS NOT AT FINAL GRADE BUT WILL BE LEFT DORMANT FOR A PERIOD OF MORE THAN ONE (1) YEAR. IF CONFLICTS EXIST BETWEEN THE PROJECT SPECIFICATIONS AND THE VESCH STD. & SPEC. 3.32, THE MORE STRINGENT REQUIREMENT SHALL APPLY. PERMANENT SEEDING MIXES AND RATES, SOIL TESTING REQUIREMENTS AND MAINTENANCE PROCEDURES ARE FOUND IN VESCH STD. & SPEC. 3.32.

DUST CONTROL MEASURES SHALL BE USED OVER THE ENTIRE SITE TO REDUCE SURFACE AND AIR MOVEMENT OF DUST DURING LAND DISTURBANCE, DEMOLITION, AND CONSTRUCTION ACTIVITIES. MANAGEMENT STRATEGIES

- 1. CONSTRUCTION WILL BE SEQUENCED SO THAT GRADING OPERATIONS CAN BEGIN AND END AS QUICKLY AS POSSIBLE
- 2. THE CONSTRUCTION ENTRANCE, THE PROPOSED SILT FENCES AND INLET PROTECTION MUST BE INSTALLED FIRST WITH MINIMAL AMOUNTS OF CLEARING AND GRADING.
- 3. DUST CONTROL OR OTHER STABILIZATION WILL FOLLOW IMMEDIATELY AFTER GRADING.
- 4. THE CONTRACTOR (JOB SUPERINTENDENT) SHALL BE RESPONSIBLE FOR THE INSTALLATION AND MAINTENANCE OF ALL EROSION AND SEDIMENT CONTROL PRACTICES.
- 5. WITHIN 30 DAYS AFTER ACHIEVING ADEQUATE STABILIZATION, THE TEMPORARY EROSION AND SEDIMENT CONTROLS SHALL BE REMOVED ONLY WITH THE APPROVAL OF THE CITY OF NEWPORT NEWS ENVIRONMENTAL INSPECTOR. TRAPPED SEDIMENT AND THE DISTURBED SOIL AREAS RESULTING FROM THE DISPOSITION OF TEMPORARY MEASURES SHALL BE PERMANENTLY STABILIZED TO PREVENT FURTHER EROSION AND SEDIMENTATION.
- 6. ALL STAGING OF CONSTRUCTION VEHICLES AND EQUIPMENT SHALL BE ONSITE. NO VEHICLES WILL BE ALLOWED TO PARK WITHIN THE RIGHT-OF-WAY OF ANY PUBLIC STREET UNLESS THE VEHICLE IS BEING USED AS PART OF AN ACTIVE CONSTRUCTION ZONE WITHIN THE ROADWAY.

### PERMANENT STABILIZATION

PERMANENT STABILIZATION SHALL BE APPLIED TO ALL DISTURBED AREAS THAT ARE TO BE LEFT DORMANT FOR A YEAR OR MORE. ALL AREAS WITHIN THE LIMITS OF DISTURBANCE SHALL BE STABILIZED WITH PERMANENT SEEDING. LANDSCAPING OR PAVEMENT FOLLOWING THE FINAL GRADING (SEE PERMANENT SEEDING TABLE SHEET C-500).

### **EROSION CONTROL SEQUENCE OF CONSTRUCTION**

- 1. OBTAIN ALL APPLICABLE LOCAL, STATE AND FEDERAL PERMITS.
- 2. INSTALL TEMPORARY STONE CONSTRUCTION ENTRANCE.
- 3. INSTALL THE STORM DRAIN INLET PROTECTION AND SILT FENCE.
- 4. CALL (757) 933-2311 TO REQUEST A PRE-CONSTRUCTION MEETING WITH CITY OFFICIALS 48 HOURS PRIOR TO DEMOLITION.
- 5. BEGIN SITE DEMOLITION ACTIVITIES INCLUDING SELECTIVE SITE DEMOLITION ACTIVITIES PER COORDINATION WITH APPROPRIATE AUTHORITIES AND UTILITY OWNERS. PROVIDE TEMPORARY STABILIZATION WITH TEMPORARY SEEDING.
- 6. ADJUST ALL EROSION CONTROL DEVICES AS NECESSARY (INCLUDING SILT FENCE, AND INLET PROTECTION) IN ORDER TO
- 7. CONTRACTOR TO HAUL ON TOP SOIL AS NEEDED AND SPREAD DAILY. NO STOCK PILING OF SOIL WILL BE REQUIRED BEYOND THAT WHICH ACCUMULATES ON ONE DAY.

MAINTAIN PROPER FUNCTION. EACH DEVICE SHALL BE MAINTAINED AS NECESSARY TO PROMOTE CORRECT OPERATION.

- 8. MAINTAIN EROSION CONTROL DEVICES DURING DEMOLITION AND GRADING.
- 9. STABILIZE SITE WITH PERMANENT SEEDING AND MULCHING DURING AND AT THE CONCLUSION OF CONSTRUCTION PER VESCH STDS.
- 10. AFTER ALL UPSLOPE AREAS HAVE BEEN STABILIZED, AND ONLY WITH THE APPROVAL OF THE CITY OF NEWPORT NEWS

### EROSION CONTROL INSPECTOR, REMOVE ALL REMAINING EROSION CONTROL DEVICES.

### MAINTENANCE

was only analyzed within its property lines.

The proposed erosion and sediment control

This plan will be approved after July 1, 2014.

compliance with 10.1-561 A of the Act and the

water quantity requirements in the Stormwater

Management Act (10.1-603.2 et seq. of the

Code of Virginia) and attendanct regulations.

The project is in conformance with the water

quantity minimum standards for channel and

Beach City Code, Appendix D.

flood protection according to the City of Virginia

The flow rate capacity and velocity are in

water of the state.

devices are designed to minimize impacts to the

PRIOR TO ANY LAND DISTURBING ACTIVITY, A LAND DISTURBANCE PERMIT MUST BE SECURED. IN GENERAL, ALL EROSION AND SEDIMENT CONTROL MEASURES SHALL BE INSPECTED PER THE REQUIREMENTS OF THE VIRGINIA EROSION AND SEDIMENT CONTROL HANDBOOK. DURING CONSTRUCTION, THE CONTRACTOR'S DESIGNATED RLD WILL BE RESPONSIBLE FOR INSPECTIONS AND REPAIR OF DAMAGED EROSION/SEDIMENT CONTROL MEASURES. THE FOLLOWING ITEMS WILL BE CHECKED IN PARTICULAR:

- 1. THE STONE CONSTRUCTION ENTRANCE SHALL BE MAINTAINED IN A CONDITION WHICH WILL PREVENT TRACKING OR FLOW OF MUD OFF OF THE SITE. THE STONE MAY NEED TO BE WASHED AND REWORKED OR ADDITIONAL STONE ADDED TO ENSURE THE ENTRANCE IS PROPERLY FUNCTIONING.
- 2. THE SILT FENCE AND INLET PROTECTION BARRIERS SHALL BE CHECKED FOR UNDERMINING AND DETERIORATION OF OR DAMAGE TO THE FABRIC. DAMAGES SHALL BE IMMEDIATELY REPAIRED. SEDIMENT SHALL BE REMOVED WHEN THE LEVEL OF SEDIMENT DEPOSITION REACHES ONE HALF THE HEIGHT OF THE BARRIER. a. LOW POINTS IN THE SILT FENCE SHALL BE CHECKED FOR DAMAGE CAUSED BY PONDING WATER. IF DAMAGE IS FOUND, ADDITIONAL ROWS OF SILT FENCE SHALL BE PLACED BEHIND AND PARALLEL TO THE PRIMARY ROW AT INCREMENTS OF ONE

- 3. THE STORM DRAIN INLET PROTECTION SHALL BE INSPECTED AFTER EACH RAIN AND REPAIRS MADE AS NEEDED. SEDIMENT SHALL BE REMOVED ONCE IT HAS REACHED ONE HALF THE DESIGN DEPTH OF THE TRAP. REMOVED SEDIMENT SHALL BE DEPOSITED IN A SUITABLE AREA AND IN SUCH A MANNER THAT IT WILL NOT ERODE. IF THE STONE FILTER BECOMES CLOGGED WITH SEDIMENT SO THAT IT NO LONGER ADEQUATELY PERFORMS ITS FUNCTION, THE STONE MUST BE PULLED AWAY FOR THE BLOCKS, CLEANED AND/OR REPLACED.
- 4. THE SEEDED AND MULCHED AREAS SHALL BE CHECKED REGULARLY TO ENSURE THAT A GOOD STAND IS MAINTAINED. AREAS SHOULD BE FERTILIZED AND RESEEDED AS NEEDED. REFER TO ESC TECHNICAL BULLETIN #4. PROVIDE REMEDIAL STABILIZATION AND SEEDING FOR A PERIOD OF ONE YEAR AFTER CONSTRUCTION.

### CITY OF NEWPORT NEWS EROSION AND SEDIMENT CONTROL STANDARDS

### EROSION AND SEDIMENT CONTROL GENERAL NOTES

- 1. THE CONTRACTOR SHALL COMPLY WITH THE CURRENT LAWS AND REGULATIONS OF THE CITY OF NEWPORT NEWS, THE COMMONWEALTH OF VIRGINIA, AND AS DEEMED NECESSARY BY THE DIRECTOR OF ENGINEERING BEFORE, DURING, AND AFTER CONSTRUCTION ON THE SITE. ALL MINIMUM STANDARDS AND SPECIFICATIONS REGARDING THE INSTALLATION AND MAINTENANCE OF ALL EROSION AND SEDIMENT CONTROL PRACTICES SHALL BE FOLLOWED BY THE CONTRACTOR.
- 2. A LAND DISTURBANCE PERMIT IS REQUIRED FOR THE PROJECT AND SHALL BE OBTAINED IN THE PLANNING DEPT., 2ND FLOOR OF CITY HALL. A RESPONSIBLE LAND DISTURBER SHALL BE IDENTIFIED ON ALL LAND DISTURBANCE PERMITS. FAILURE TO COMPLY WITH ANY OF THE REQUIREMENTS IDENTIFIED HERE WILL INITIATE A NOTICE TO COMPLY (NTC), NOTICE OF VIOLATION (NOV), STOP WORK ORDERS (SWO), CIVIL PENALTIES, OR NULLIFY THE PERMIT.
- ALL STORMWATER BEST MANAGEMENT PRACTICES NEED TO BE CONSTRUCTED AND INSTALLED AS PER THE APPROVED PLAN. THE CONTRACTOR OR OWNER MUST CONTACT THE CITY'S ENVIRONMENTAL INSPECTION STAFF AT (757) 933-2311 TO SCHEDULE A PRE-CONSTRUCTION MEETING 48 HOURS IN ADVANCE OF LAND DISTURBANCE.
- 4. ALL APPROPRIATE EROSION CONTROL MEASURES SUCH AS, BUT NOT LIMITED TO, TREE PROTECTION, SILT FENCE, CONSTRUCTION ENTRANCE, AND INLET PROTECTION SHALL BE INSTALLED PRIOR TO THE START OF CONSTRUCTION AND MUST BE REVIEWED AND APPROVED BY A CITY INSPECTOR BEFORE ANY CLEARING OPERATIONS BEGIN. THE CONTRACTOR OR OWNER MUST CONTACT THE CITY'S ENVIRONMENTAL INSPECTION STAFF AT (757) 933-2311 TO SCHEDULE ALL INSPECTIONS.
- 5. A COPY OF THE APPROVED EROSION AND SEDIMENT CONTROL PLAN AND LAND DISTURBANCE PERMIT MUST BE MAINTAINED AT THE SITE FOR THE DURATION OF ALL CONSTRUCTION AND LAND DISTURBING ACTIVITIES THE CONTRACTOR SHALL CONSTRUCT AND MAINTAIN ALL APPROVED MEASURES AS SHOWN ON THE APPROVED PLANS. ANY ADDITIONAL MEASURES DEEMED REQUIRED BY THE CITY, DUE TO FIELD CONDITIONS, SHALL BECOME PART OF THE EROSION AND SEDIMENT CONTROL PLAN FOR THE PROPERTY. ALL FIELD CHANGES MUST BE APPROVED BY EITHER THE CITY'S INSPECTOR OR ENGINEER PRIOR TO INSTALLATION. ALL APPROVED FIELD CHANGES SHALL BE SENT TO THE PLANNING TO BE ATTACHED TO THE APPROVED PLAN.
- 7. DURING DEWATERING OPERATIONS, WATER SHALL BE PUMPED INTO AN APPROVED FILTERING DEVICE.
- 8. THE CONTRACTOR MAY NOT CHANGE OR ALTER ANY OF THE APPROVED MEASURES WITHOUT FIRST NOTIFYING THE CITY'S INSPECTOR OR ENGINEER. FAILURE TO DO SO MAY RESULT IN A NOV, SWO, CIVIL PENALTIES, AND/OR REVOCATION OF THE LAND DISTURBANCE PERMIT.
- 9. THE CONTRACTOR SHALL CONSTRUCT AND MAINTAIN ALL MEASURES TO PREVENT SOIL FROM ERODING ONTO ADJACENT PROPERTY, STREETS, DRAINAGE SYSTEMS, AND WATERWAYS. ALL DEVICES SHALL BE CLEANED OF SEDIMENT, MUD, DEBRIS, AND OTHER ERODED MATERIAL DURING THE SITE CLEARING AND DEVELOPMENT. INSPECTION OF ALL DEVICES SHALL BE AT A MINIMUM EVERY TWO (2) WEEKS AND REQUIRED AFTER EVERY RUNOFF PRODUCING EVENT. ALL INSPECTION AND MAINTENANCE ACTIVITIES SHALL BE DOCUMENTED AND AVAILABLE FOR REVIEW AT THE CITY'S REQUEST.
- 10. TEMPORARY AND PERMANENT SEEDING OPERATIONS SHALL BE INITIATED WITHIN SEVEN (7) DAYS AFTER REACHING FINAL GRADE OR UPON SUSPENSION OF GRADING OPERATIONS FOR AN ANTICIPATED DURATION OF GREATER THAN FOURTEEN (14) DAYS OR UPON COMPLETION OF GRADING OPERATIONS FOR A SPECIFIC AREA.
- 11. EROSION AND CONTROL MEASURES SHALL BE KEPT IN PLACE FOR THE DURATION OF THE CLEARING AND CONSTRUCTION OPERATIONS AND AT A MAXIMUM FOR THE SPECIFIED TIME FOR EACH MEASURE AS IDENTIFIED IN THE VESC HANDBOOK, OR WHEN FULL STABILIZATION HAS OCCURRED FOR THE ENTIRE A FINAL INSPECTION BY THE CITY INSPECTOR SHALL DETERMINE WHEN THIS FACT IS ACCOMPLISHED AND ALL TEMPORARY MEASURES AND DEVICES CAN BE REMOVED.
- 12. THE CONTRACTOR SHALL MONITOR AND TAKE PRECAUTIONS TO CONTROL DUST AND OTHER AIR POLLUTANTS, INCLUDING BY NOT LIMITED TO USING WATER OR CHEMICALS, LIMITING THE NUMBER OF VEHICLES ALLOWED ONSITE, MINIMIZING THE OPERATING SPEED OF ALL VEHICLES, ETC. ALSO, THE CONTRACTOR WILL BE RESPONSIBLE FOR THE DAILY SWEEPING OF PUBLIC RIGHT-OF-WAY SHOULD SEDIMENT ACCUMULATE ON PAVED SURFACES.
- 13. CONTRACTOR SHALL SUBMIT A SEPARATE EROSION AND SEDIMENT CONTROL PLAN FOR ANY OFF-SITE AREAS ASSOCIATED WITH THE LAND DISTURBANCE AND SOIL REMOVAL IDENTIFIED HEREIN. A SEPARATE SUBMITTAL IS NOT
- NECESSARY FOR THE FOLLOWING SITUATIONS: A. NO MATERIAL WILL BE HAULED OR TRANSPORTED OFF-SITE AND APPROPRIATE EROSION AND SEDIMENT CONTROL MEASURES SHALL BE INSTALLED AND MAINTAINED AROUND ALL STOCKPILES AND STORAGE AREAS, OR
- ALL MATERIAL TO BE HAULED OR TRANSPORTED OFF- SITE WILL BE DEPOSITED AT A FEDERAL, STATE, AND LOCALLY APPROVED SITE. THE CONTRACTOR SHALL IDENTIFY ON THE PLANS WHAT DISPOSAL SITE WILL BE USED.
- 14. FOR ALL PROPOSED LAND DISTURBANCE ACTIVITIES THAT ARE ONE ACRE OR GREATER IN TOTAL AREA, A VIRGINIA STORMWATER MANAGEMENT PROGRAM (VSMP) PERMIT MUST FIRST BE OBTAINED FROM THE CITY OF NEWPORT NEWS: THE "VSMP AUTHORITY", PRIOR TO ANY ACTUAL SOIL DISTURBANCE TAKING PLACE. FAILURE TO DO SO WILL RESULT IN THE ISSUANCE OF A NOTICE- OF-VIOLATION. IT IS THE OWNER'S AND/OR CONTRACTOR'S RESPONSIBILITY TO CONTACT THE CITY OF NEWPORT NEWS, DEPARTMENT OF PLANNING, FOR PERMIT DETAILS, APPLICATION, AND APPROVALS.
- 15. APPROVAL OF AN EROSION AND SEDIMENT CONTROL PLAN AND ACQUISITION OF A LAND DISTURBING PERMIT DOES NOT RELIEVE THE OWNER/DEVELOPER FROM OBTAINING APPLICABLE FEDERAL, STATE, AND OTHER LOCAL PERMITS, OR FROM COMPLYING WITH PERTINENT FEDERAL, STATE, AND LOCAL LAWS AND REGULATIONS.
- A CONSTRUCTION RECORD DRAWING FOR PERMANENT STORMWATER MANAGEMENT FACILITIES SHALL BE SUBMITTED TO THE CITY OF NEWPORT NEWS FOR ACCEPTANCE. THE CONSTRUCTION RECORD DRAWING SHALL BE APPROPRIATELY SEALED AND SIGNED BY A PROFESSIONAL ENGINEER OR LAND SURVEYOR LICENSED IN THE COMMONWEALTH OF VIRGINIA CERTIFYING THAT THE STORMWATER MANAGEMENT FACILITIES HAVE BEEN CONSTRUCTED IN ACCORDANCE WITH THE APPROVED PLAN.

### STATE MINIMUM STANDARDS FOR EROSION CONTROL

### GENERAL EROSION AND SEDIMENT CONTROL NOTES

- ES-1 UNLESS OTHERWISE INDICATED, ALL VEGETATIVE AND STRUCTURAL EROSION AND SEDIMENT CONTROL PRACTICES WILL BE CONSTRUCTED AND MAINTAINED ACCORDING TO MINIMUM STANDARDS AND SPECIFICATIONS OF THE VIRGINIA EROSION AND SEDIMENT CONTROL HANDBOOK AND VIRGINIA REGULATIONS 9VAC25-840 EROSION AND SEDIMENT CONTROL REGULATIONS.
- ES-2 THE PLAN APPROVING AUTHORITY MUST BE NOTIFIED ONE WEEK PRIOR TO THE PRE-CONSTRUCTION CONFERENCE, ONE WEEK PRIOR TO THE COMMENCEMENT OF LAND DISTURBING ACTIVITY, AND ONE WEEK PRIOR TO THE FINAL INSPECTION.
- ES-3 ALL EROSION AND SEDIMENT CONTROL MEASURES ARE TO BE PLACED PRIOR TO OR AS THE FIRST STEP IN
- A COPY OF THE APPROVED EROSION AND SEDIMENT CONTROL PLAN SHALL BE MAINTAINED ON THE SITE AT ALL
- PRIOR TO COMMENCING LAND DISTURBING ACTIVITIES IN AREAS OTHER THAN INDICATED ON THESE PLANS (INCLUDING, BUT NO LIMITED TO, OFF-SITE BORROW OR WASTE AREAS), THE CONTRACTOR SHALL SUBMIT A SUPPLEMENTARY EROSION CONTROL PLAN TO THE OWNER FOR REVIEW AND APPROVAL BY THE PLAN APPROVING AUTHORITY.
- THE CONTRACTOR IS RESPONSIBLE FOR INSTALLATION OF ANY ADDITIONAL EROSION CONTROL MEASURES NECESSARY TO PREVENT EROSION AND SEDIMENTATION AS DETERMINED BY THE PLAN APPROVING AUTHORITY
- ALL DISTURBED AREAS ARE TO DRAIN TO APPROVED SEDIMENT CONTROL MEASURES AT ALL TIMES DURING LAND DISTURBING ACTIVITIES AND DURING SITE DEVELOPMENT UNTIL FINAL STABILIZATION IS ACHIEVED.
- ES-8 DURING DEWATERING OPERATIONS, WATER WILL BE PUMPED INTO AN APPROVED FILTERING DEVICE.
- THE CONTRACTOR SHALL INSPECT ALL EROSION CONTROL MEASURES PERIODICALLY AND AFTER EACH RUNOFF-PRODUCING RAINFALL EVENT. ANY NECESSARY REPAIRS OR CLEANUP TO MAINTAIN THE EFFECTIVENESS OF THE EROSION CONTROL DEVICES SHALL BE MADE IMMEDIATELY.

TIMOTHY K. DEAN Lic. No. 041397 08/07/2024

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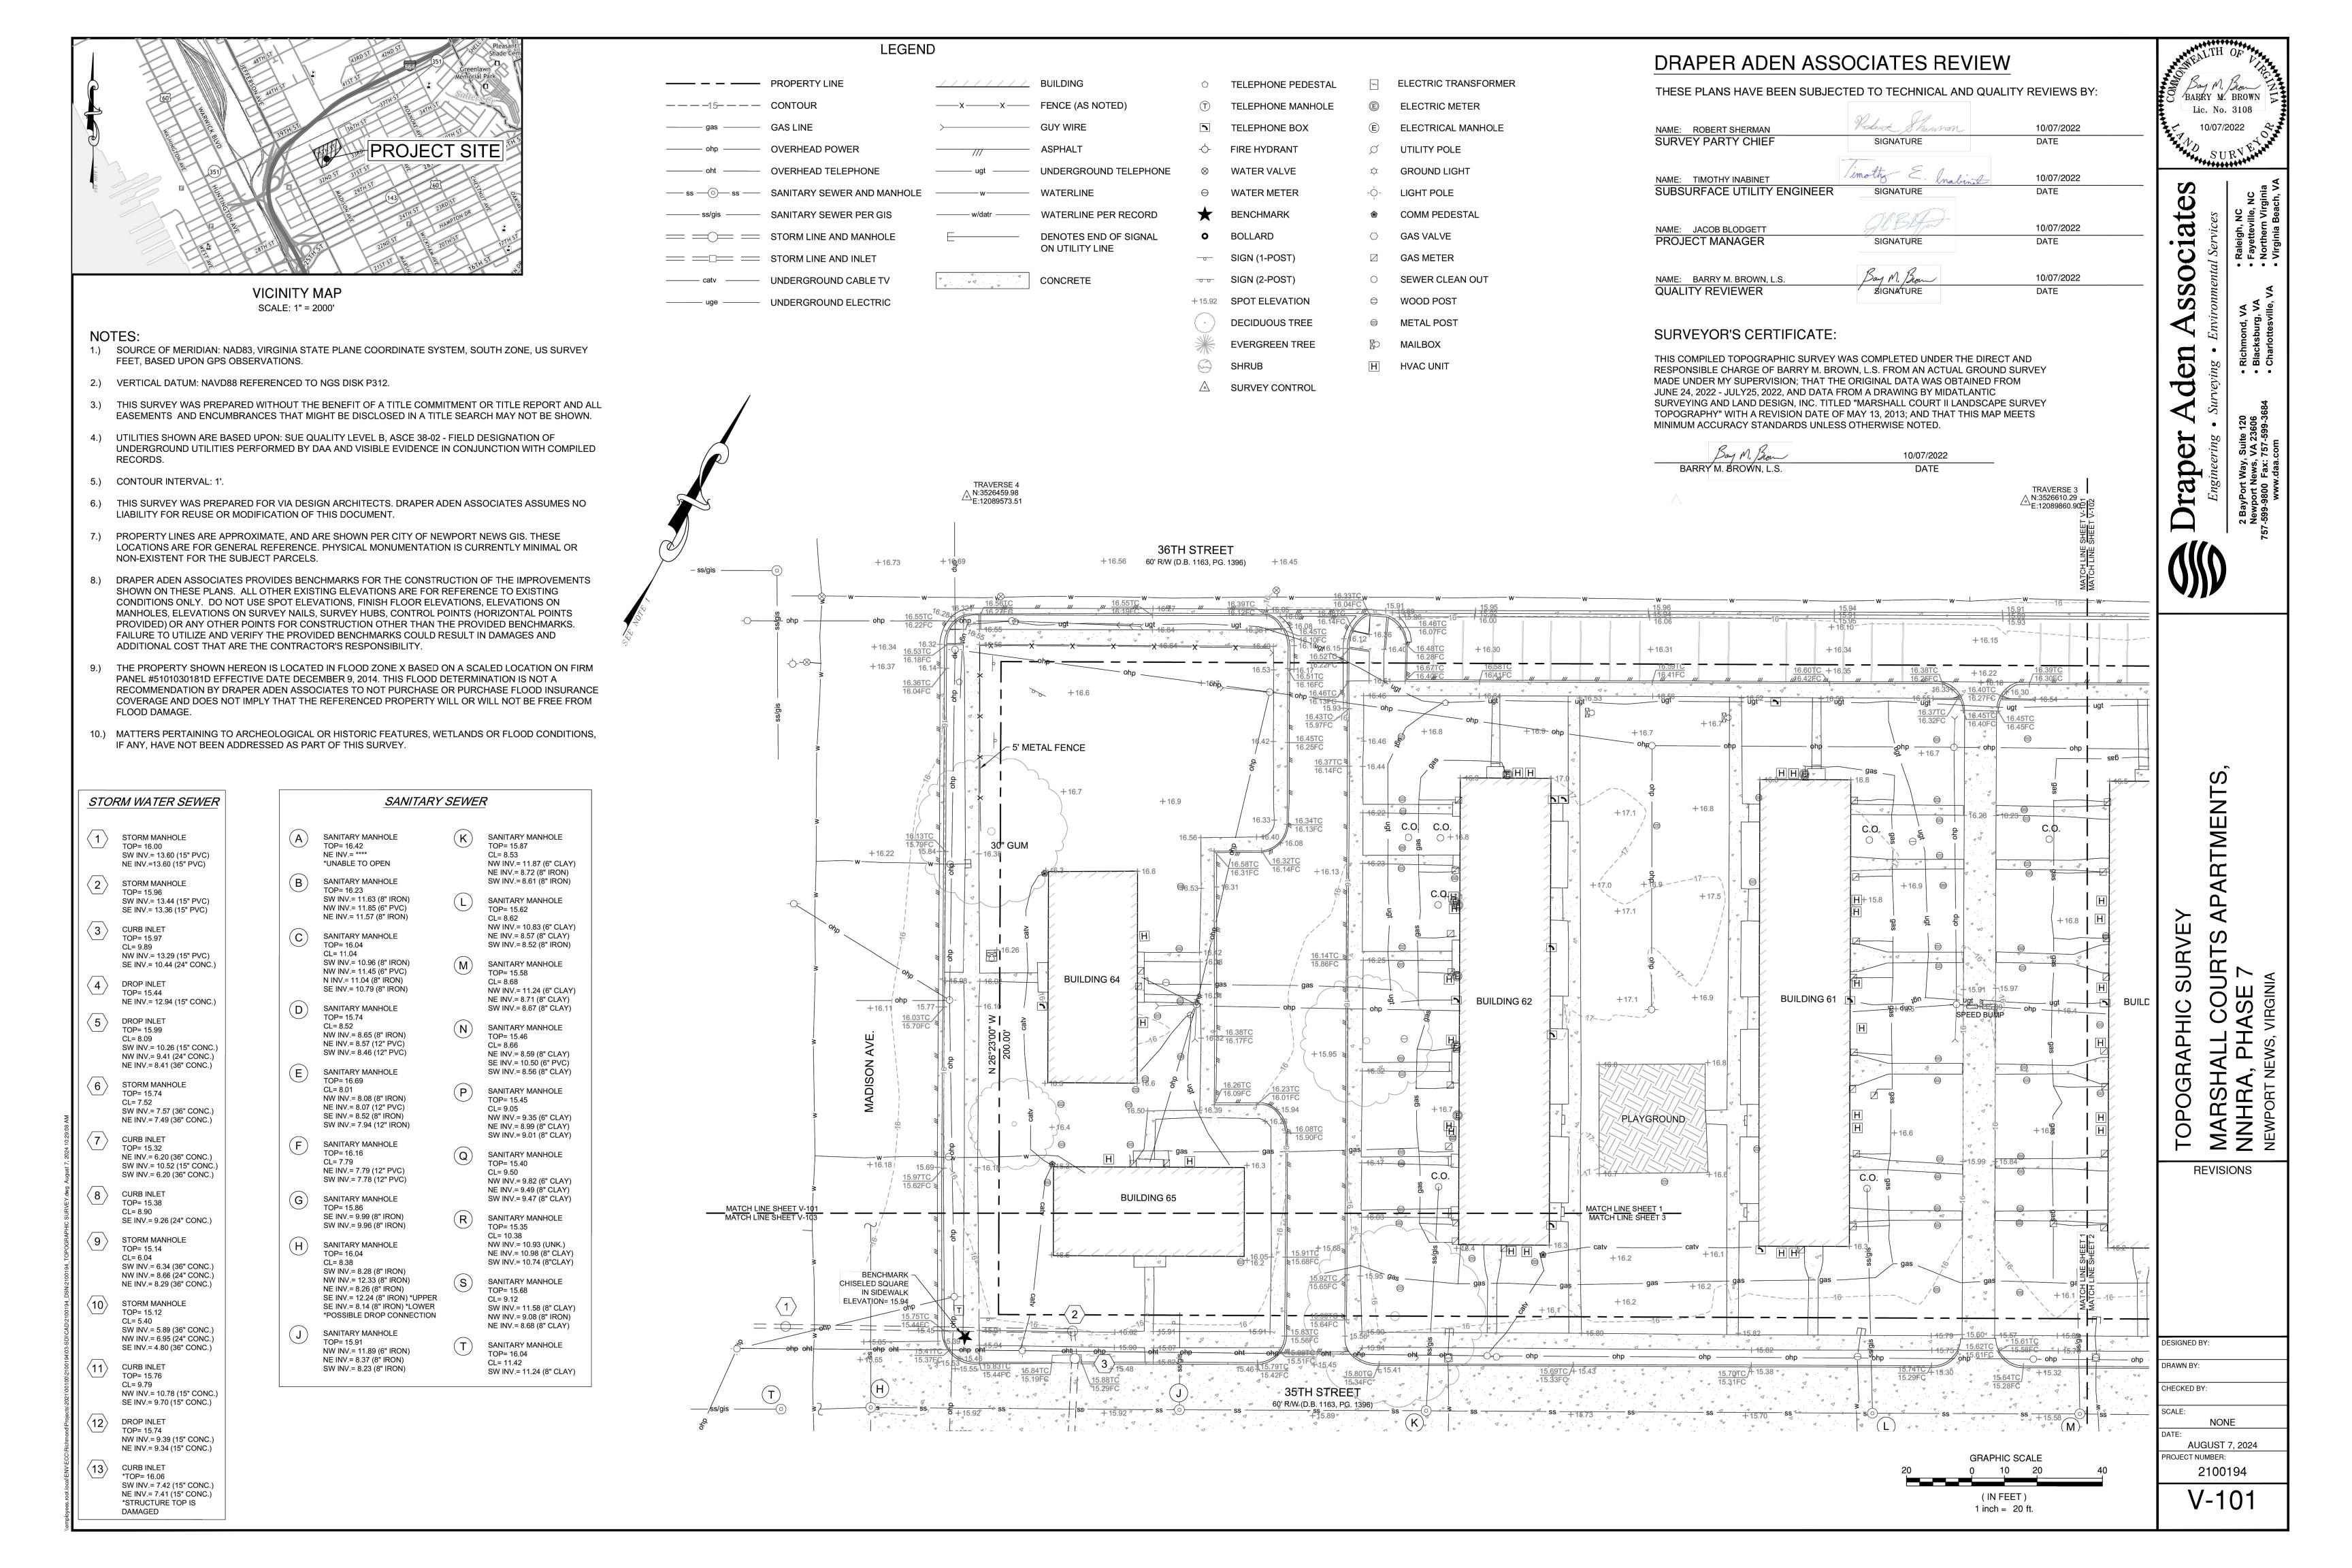
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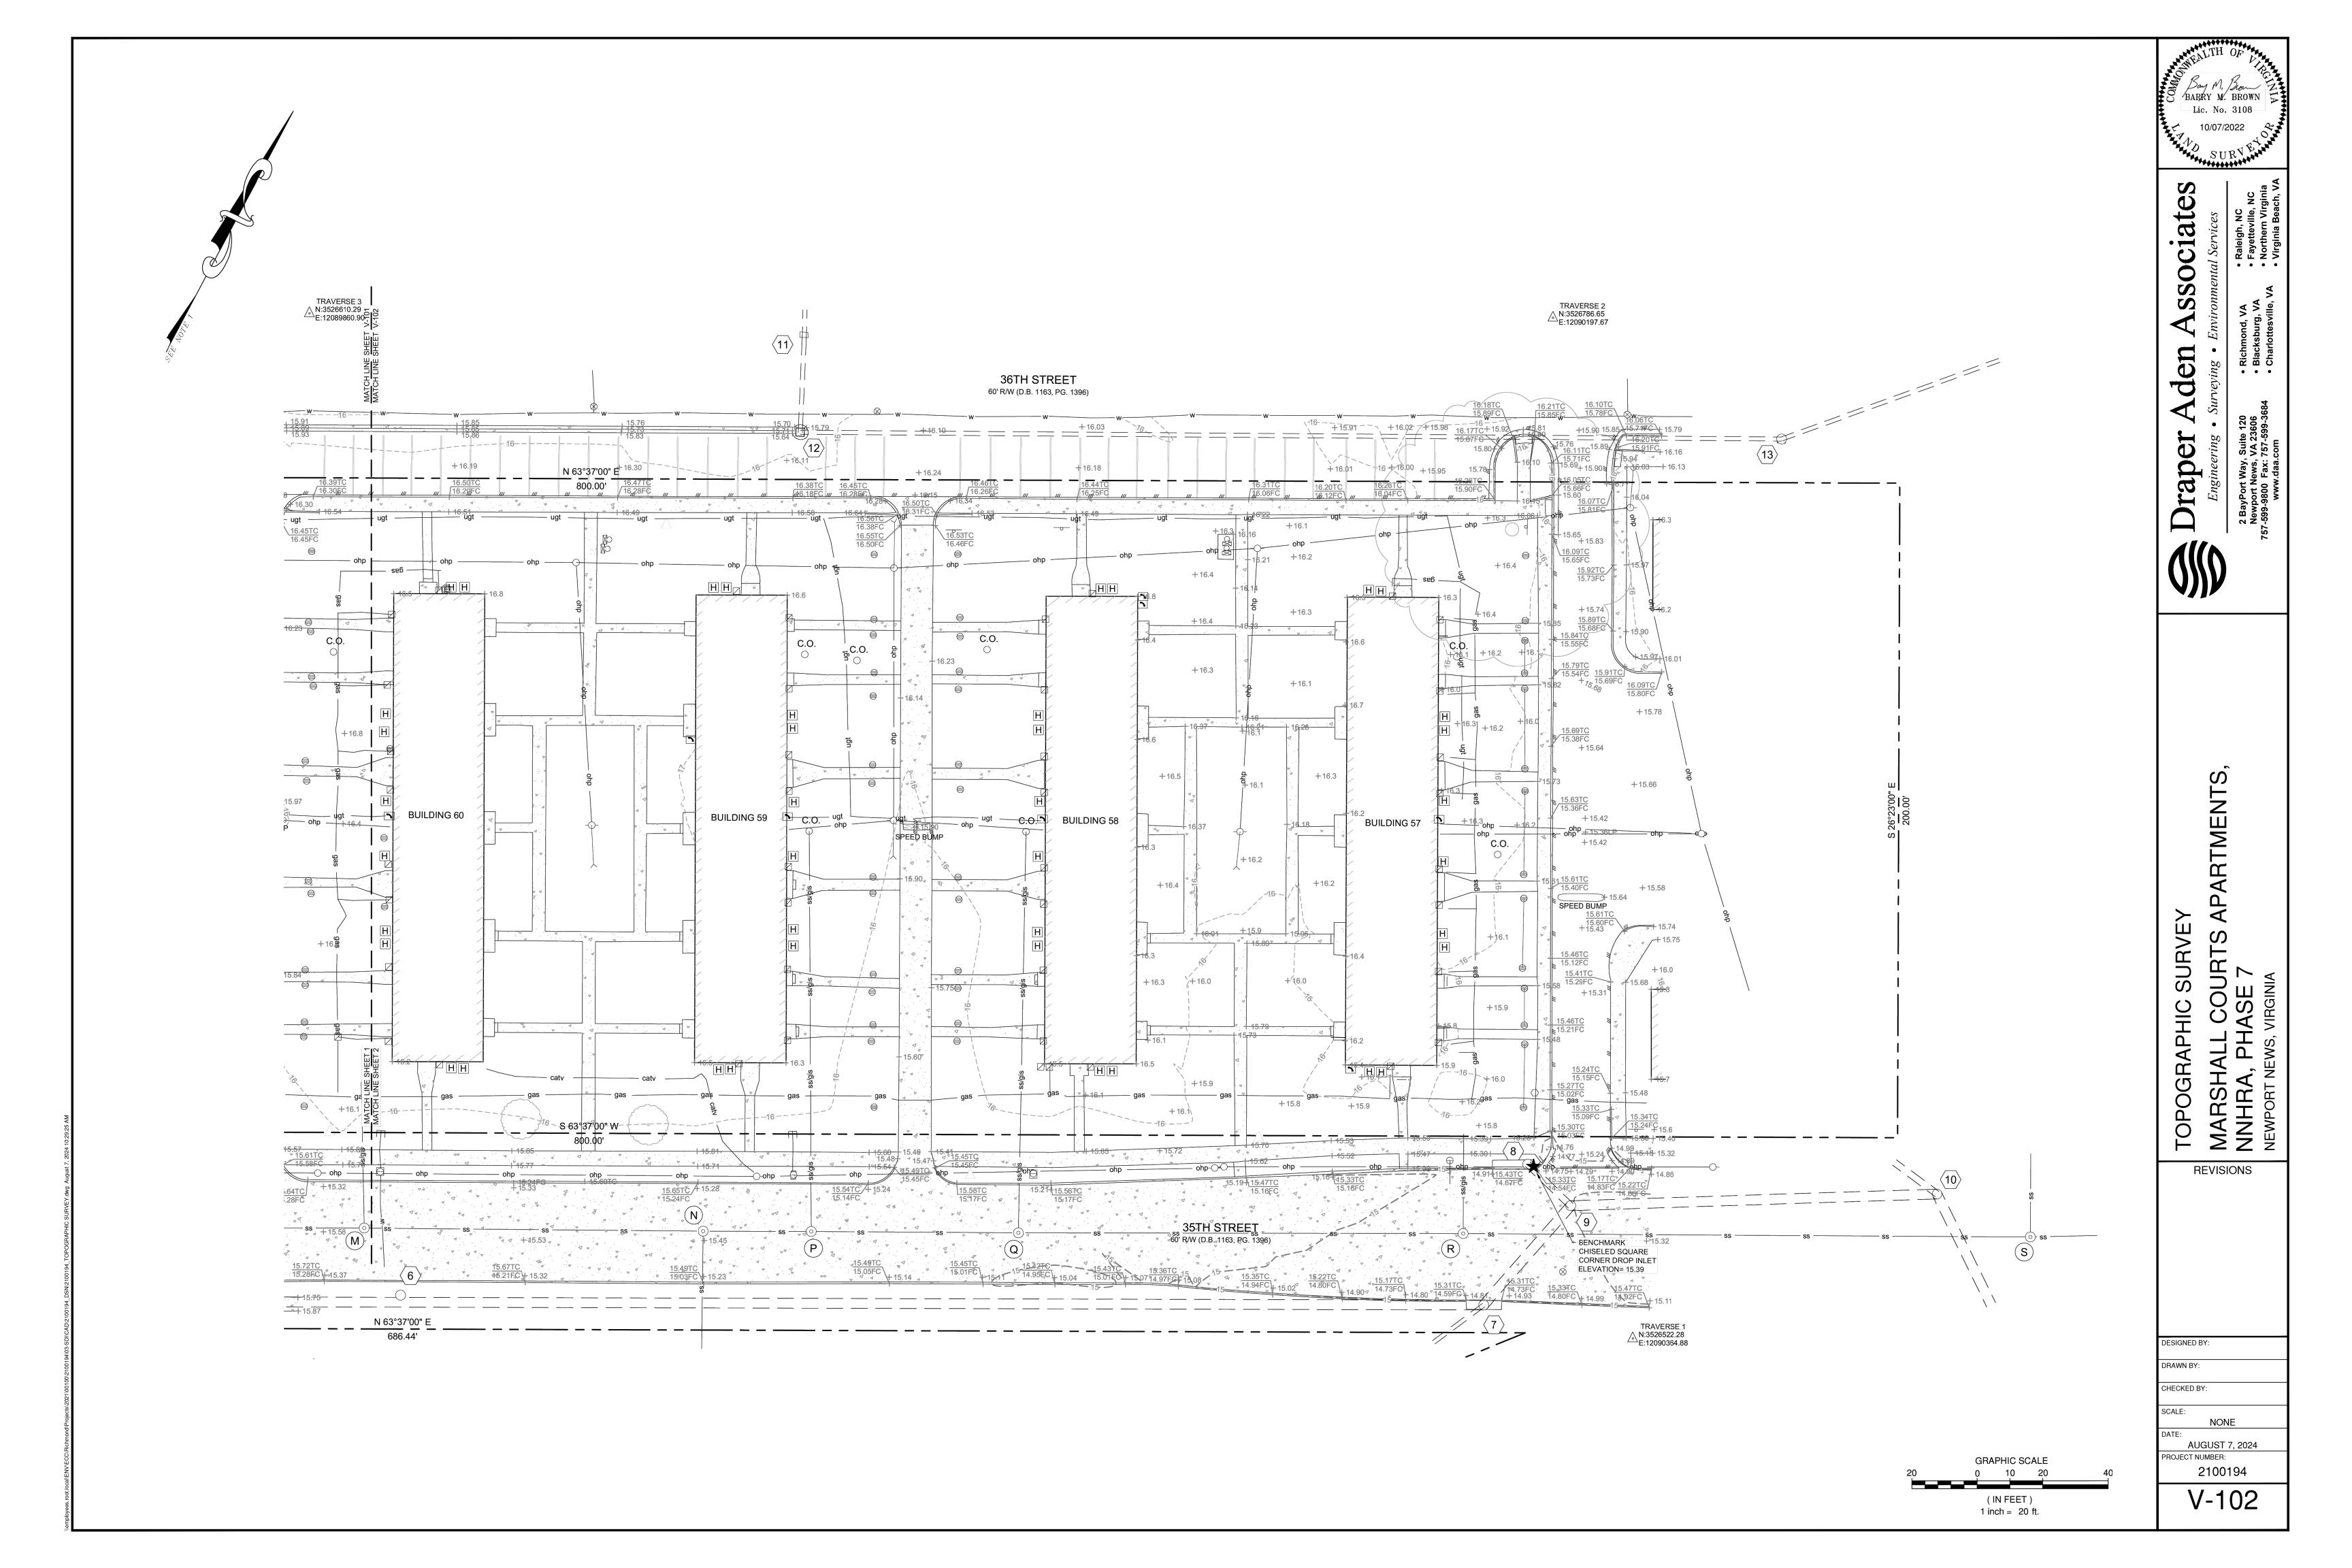
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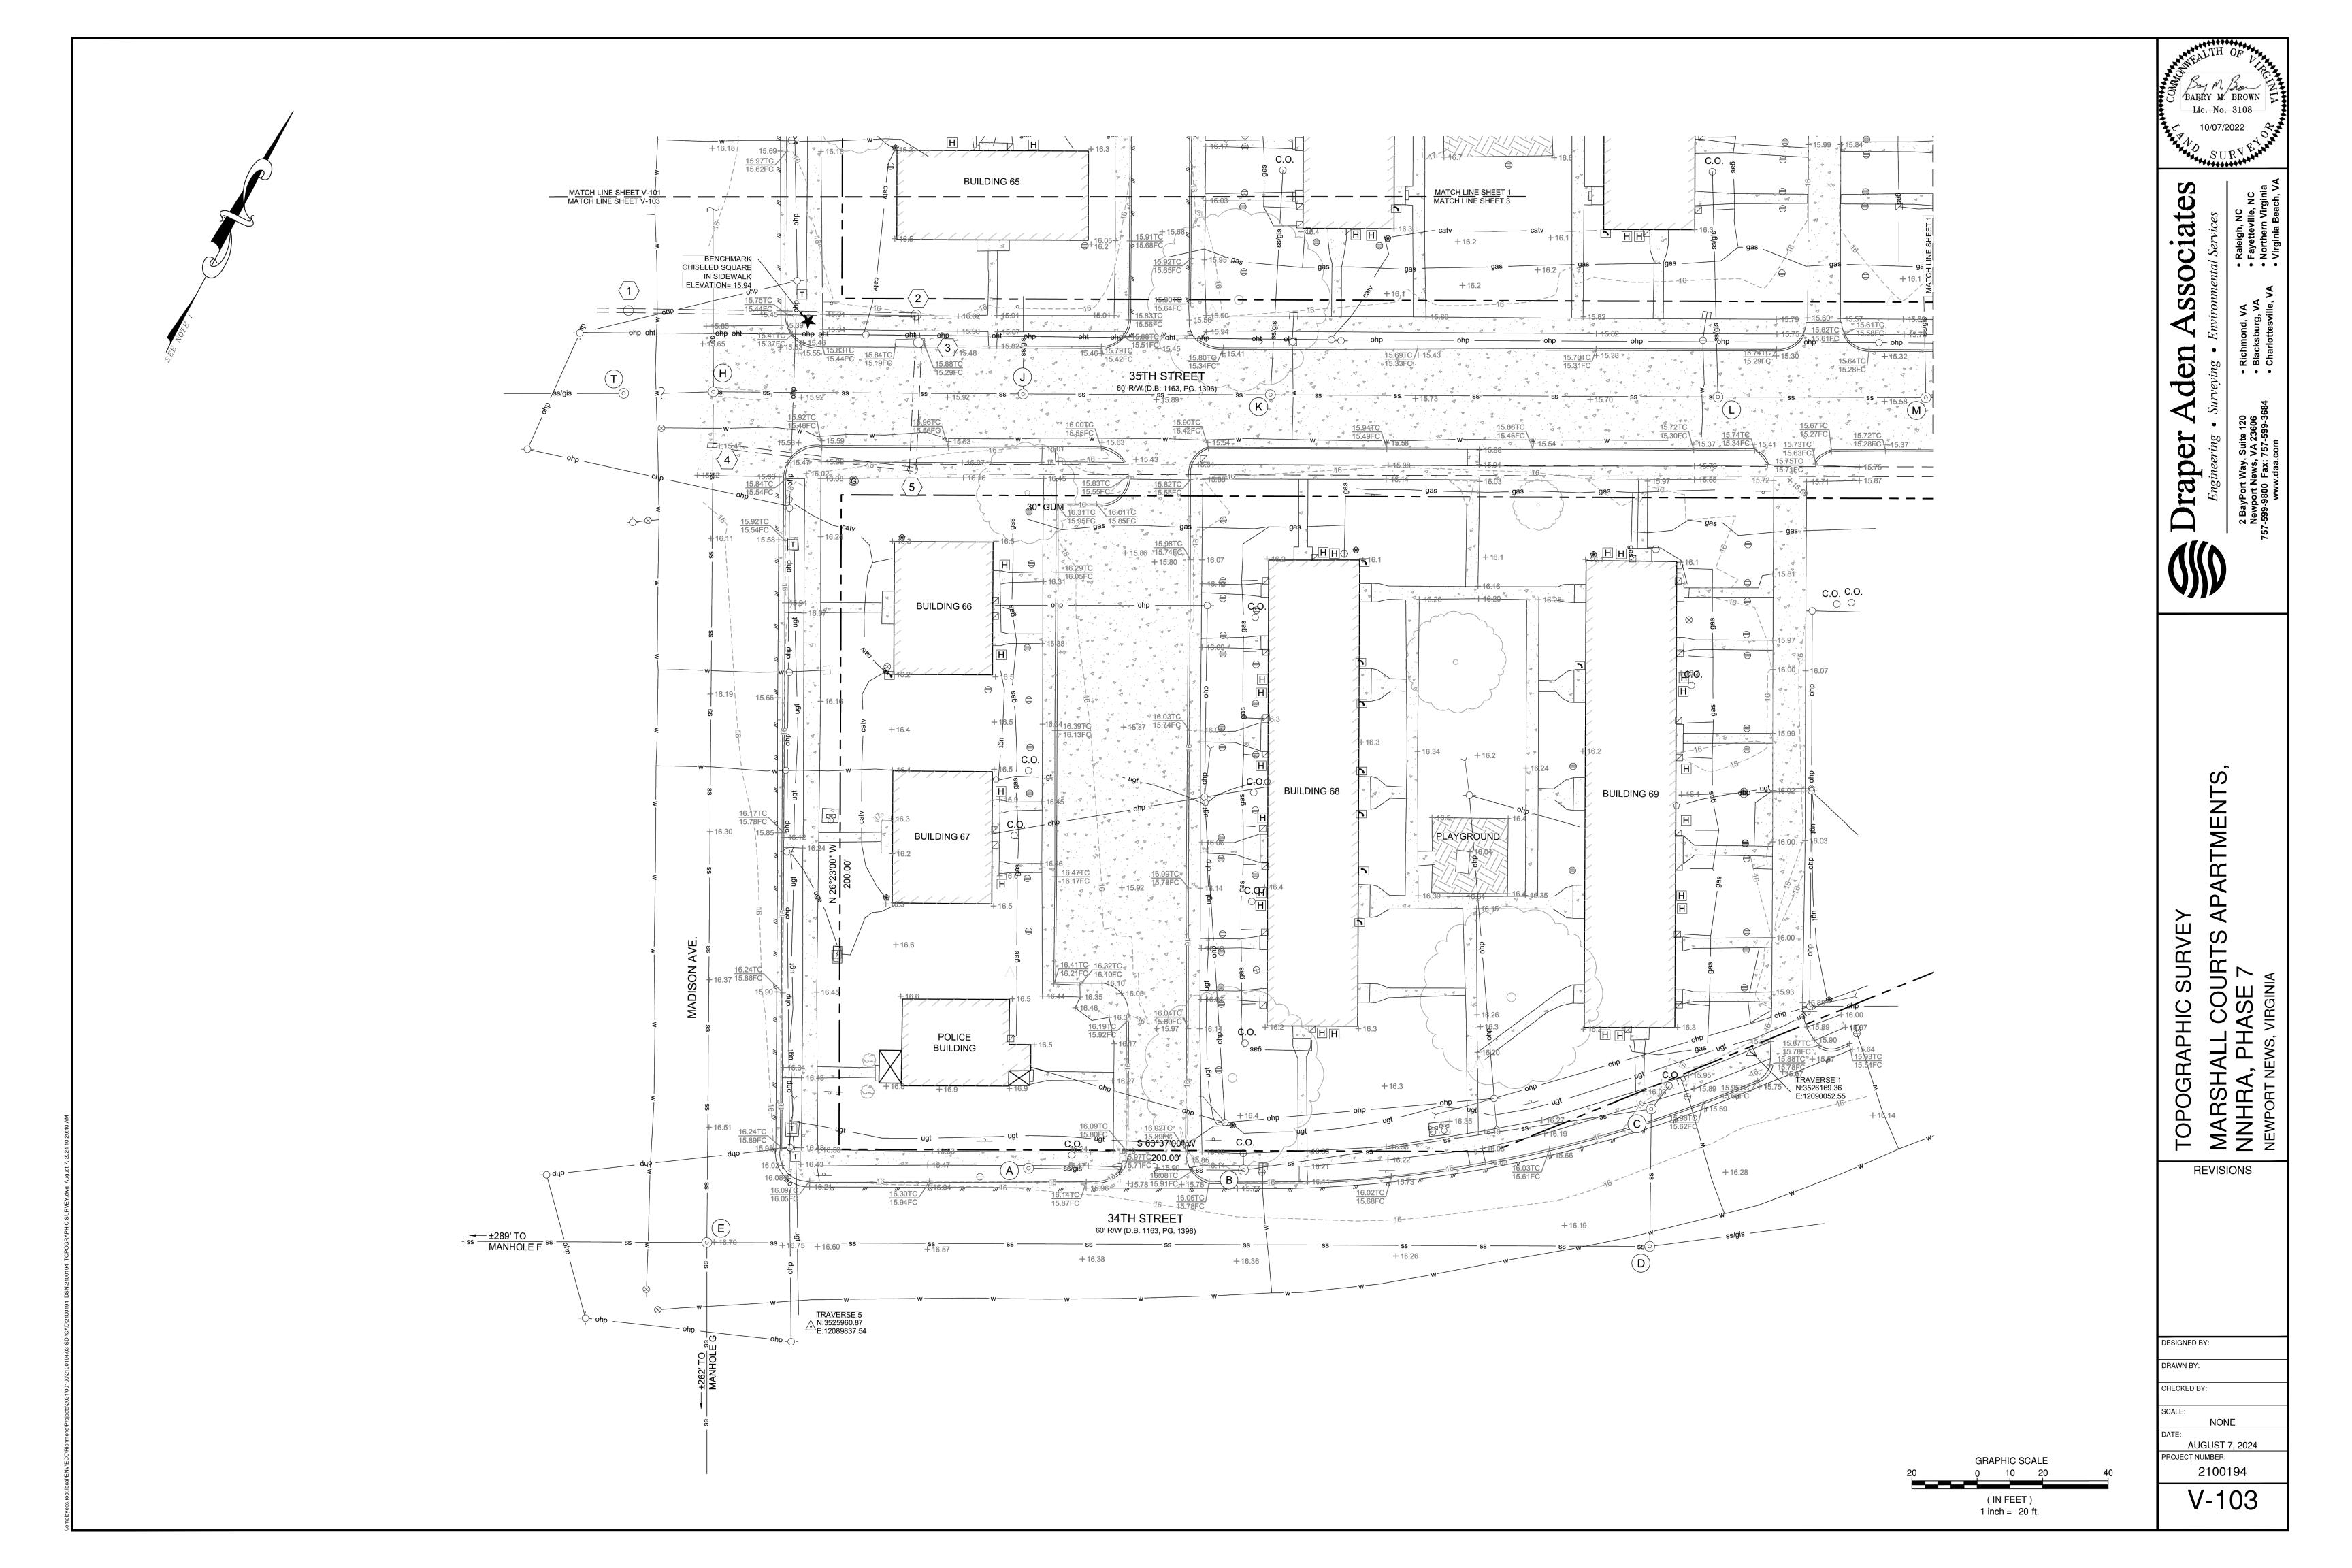
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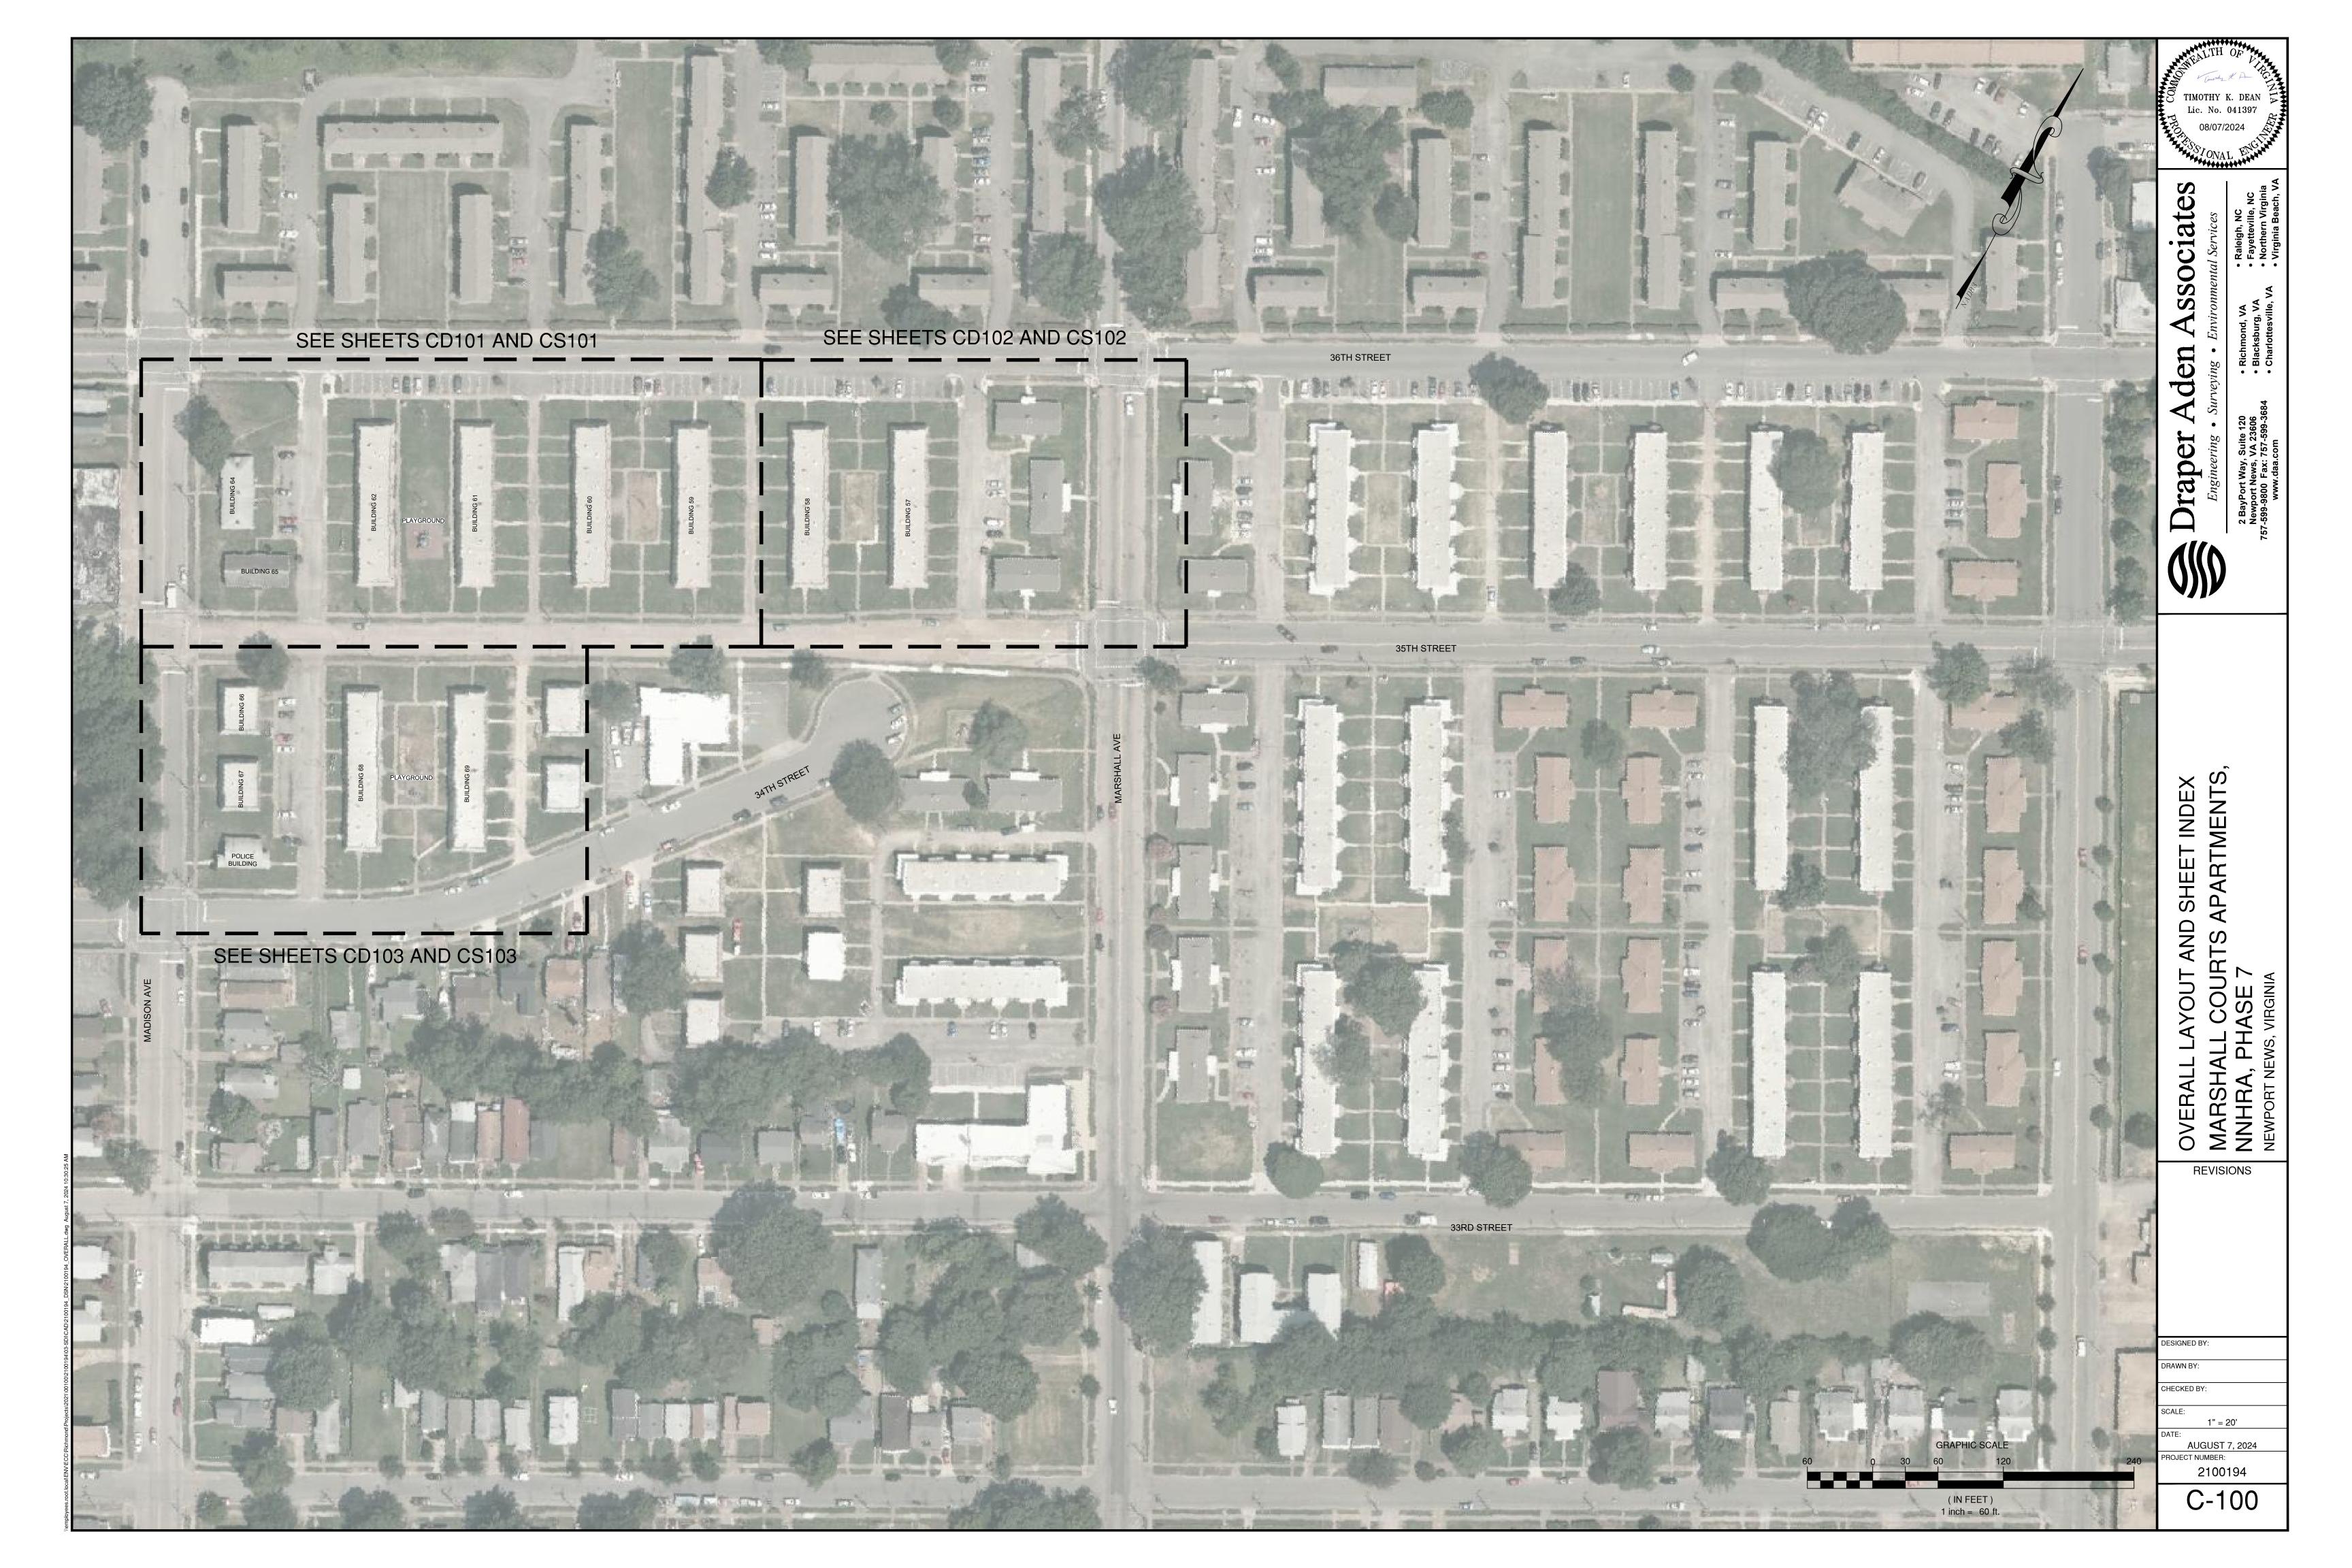
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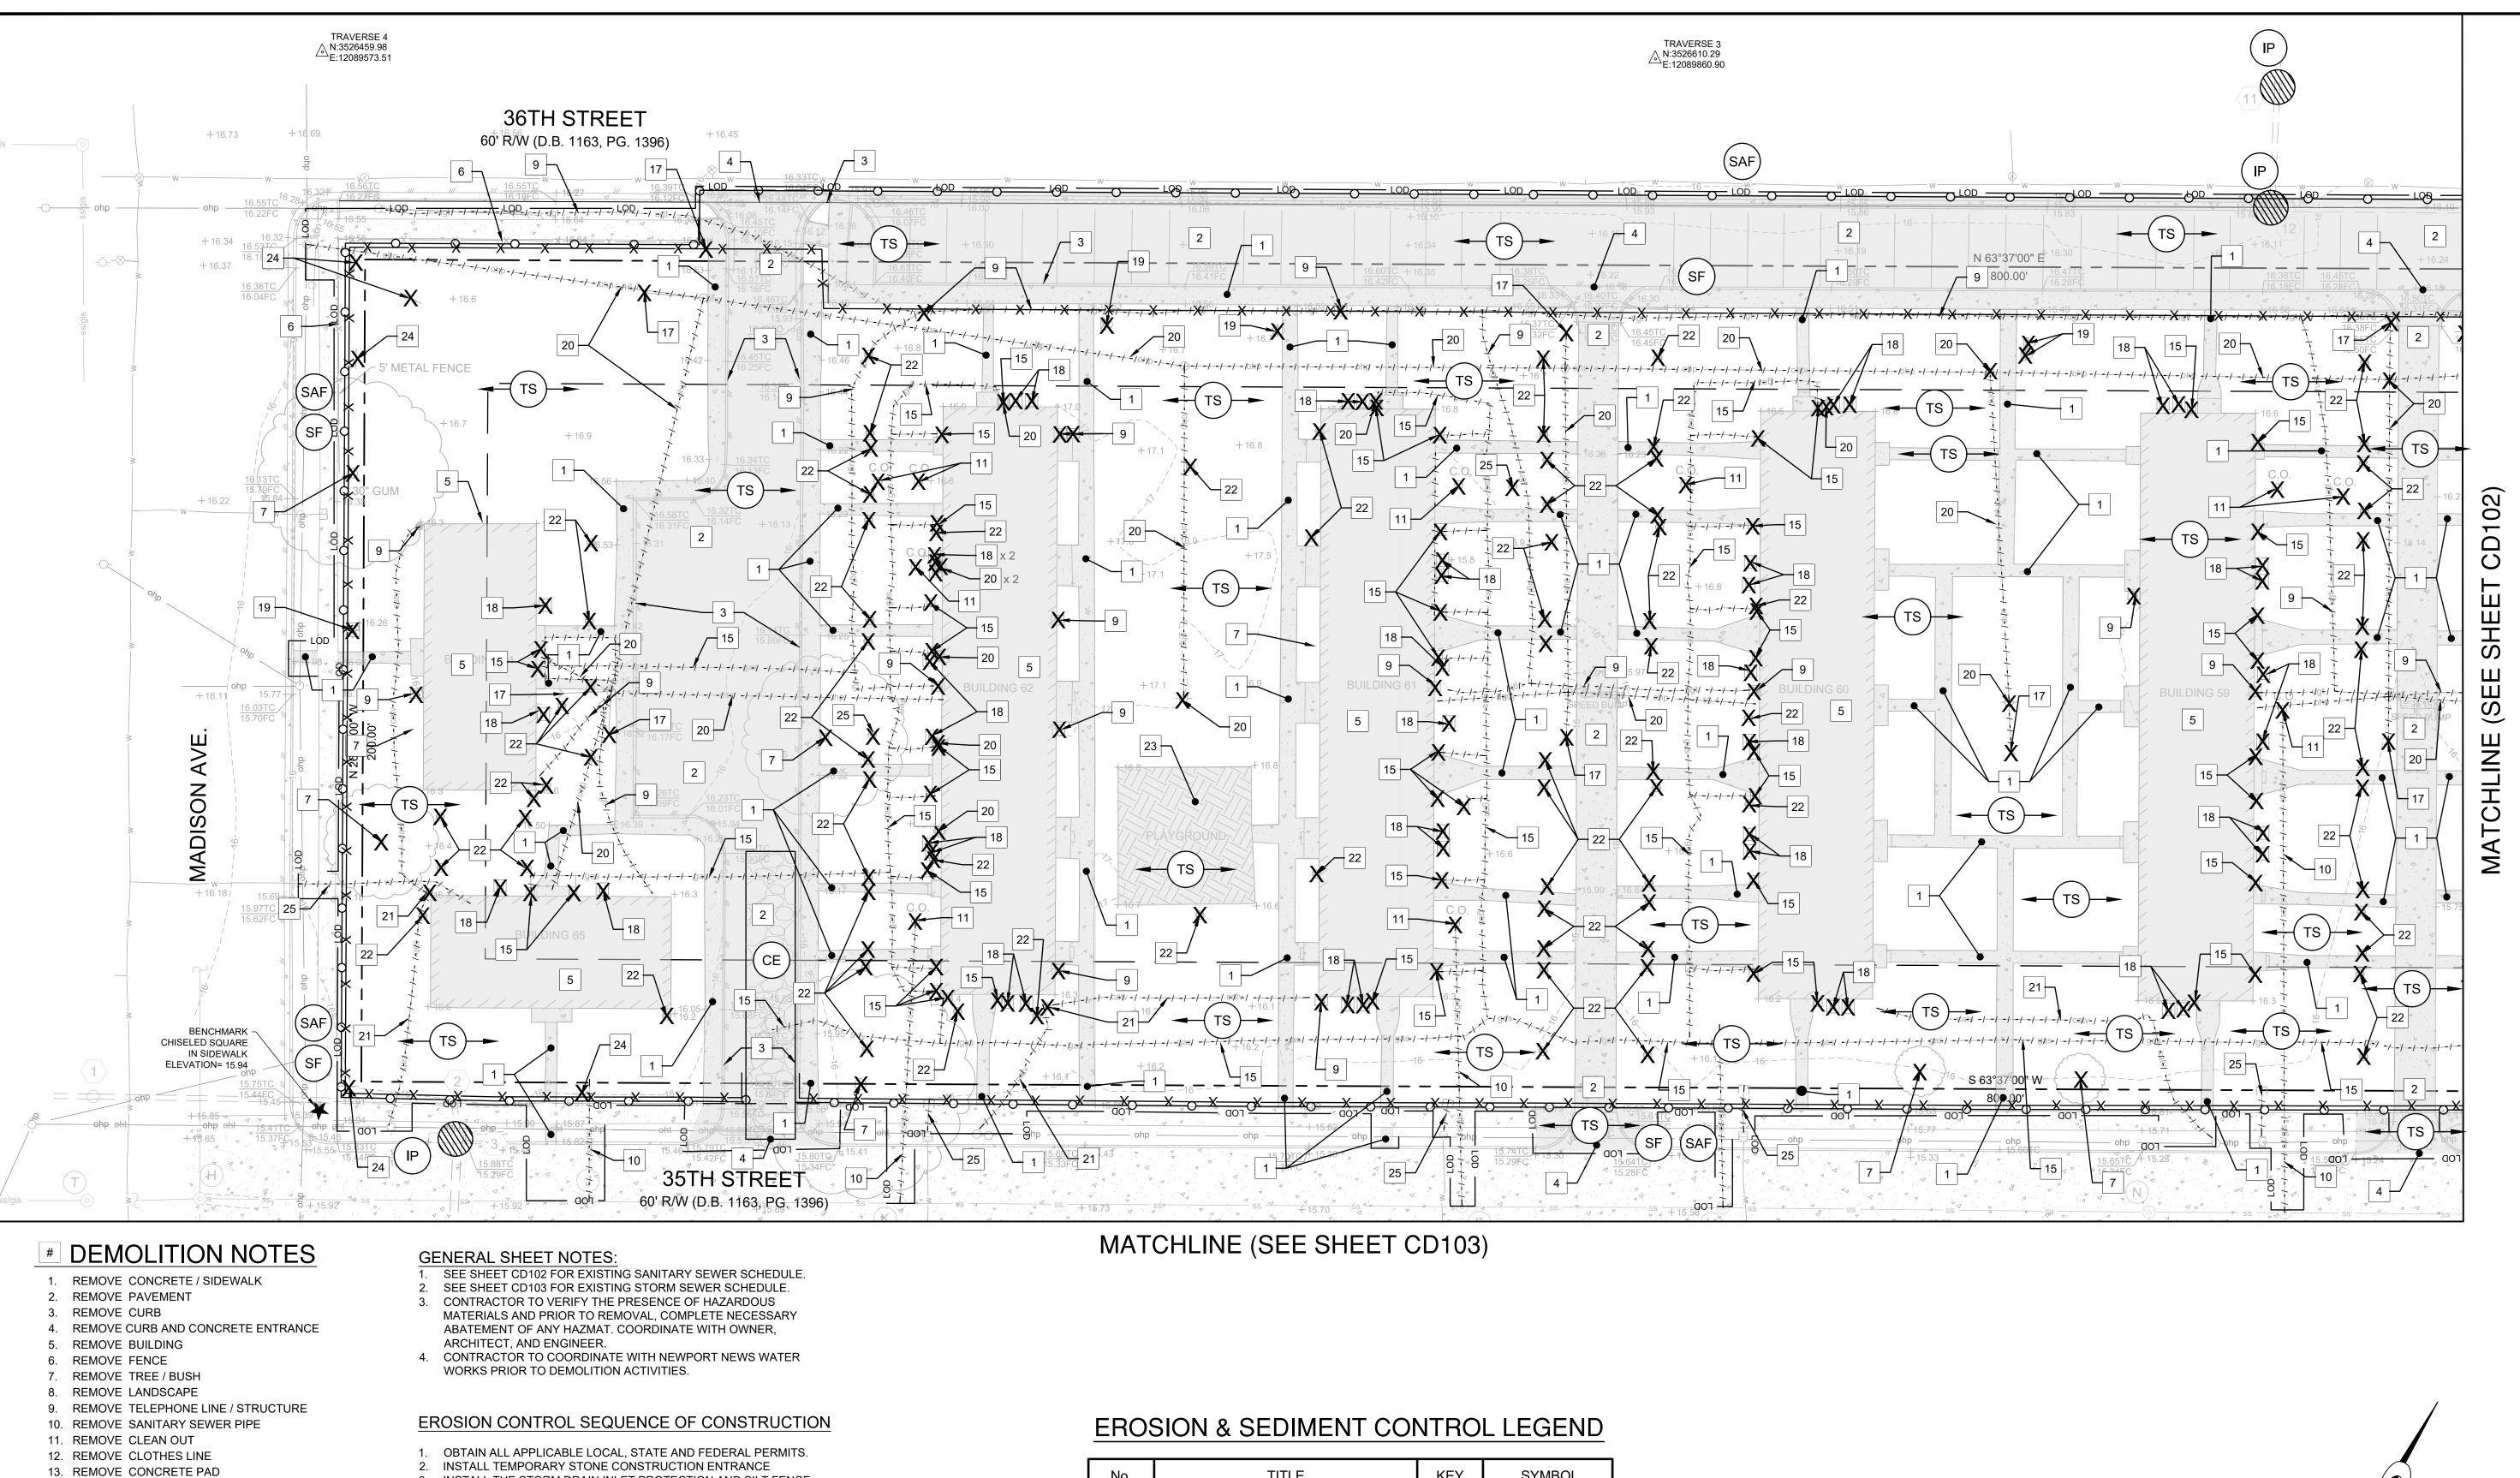
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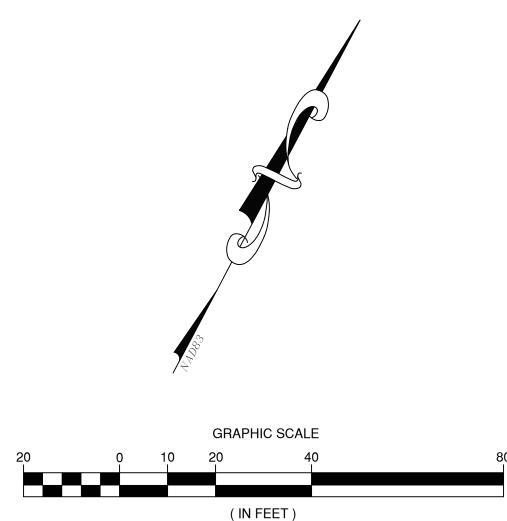






- INSTALL THE STORM DRAIN INLET PROTECTION AND SILT FENCE.
- 4. CALL (757) 933-2311 TO REQUEST A PRE-CONSTRUCTION MEETING WITH CITY OFFICIALS 48 HOURS PRIOR TO DEMOLITION.
- 5. BEGIN SITE DEMOLITION ACTIVITIES INCLUDING SELECTIVE SITE DEMOLITION ACTIVITIES PER COORDINATION WITH APPROPRIATE AUTHORITIES AND UTILITY OWNERS. PROVIDE TEMPORARY
- STABILIZATION WITH TEMPORARY SEEDING. 6. ADJUST ALL EROSION CONTROL DEVICES AS NECESSARY (INCLUDING SILT FENCE, AND INLET PROTECTION) IN ORDER TO MAINTAIN PROPER
- FUNCTION. EACH DEVICE SHALL BE MAINTAINED AS NECESSARY TO PROMOTE CORRECT OPERATION. 7. CONTRACTOR TO HAUL ON TOP SOIL AS NEEDED AND SPREAD DAILY.
- NO STOCK PILING OF SOIL WILL BE REQUIRED BEYOND THAT WHICH ACCUMULATES ON ONE DAY.
- 8. MAINTAIN EROSION CONTROL DEVICES DURING DEMOLITION AND GRADING.
- 9. STABILIZE SITE WITH PERMANENT SEEDING AND MULCHING DURING AND AT THE CONCLUSION OF CONSTRUCTION PER VESCH STDS.
- 10. AFTER ALL UPSLOPE AREAS HAVE BEEN STABILIZED, AND ONLY WITH THE APPROVAL OF THE CITY OF NEWPORT NEWS EROSION CONTROL INSPECTOR, REMOVE ALL REMAINING EROSION CONTROL DEVICES.

No.	TITLE	KEY	SYMBOL
3.01	SAFETY FENCE	SAF	-0
3.02	TEMPORARY STONE CONSTRUCTION ENTRANCE	CE	
3.05	SILT FENCE	SF	xx
3.07	STORM DRAIN INLET PROTECTION	(IP)	
3.31	TEMPORARY SEEDING	TS	ALL APPLICABLE AREAS
3.39	DUST CONTROL	DC	ALL APPLICABLE AREAS



1 inch = 20 ft.

sociates

APARTME PHASE \_\_ ایک E&S | OURTS / SE 7 AND **DEMOLITION** 

**REVISIONS** 

DESIGNED BY: DRAWN BY: 1" = 20'

CHECKED BY: AUGUST 7, 2024 ROJECT NUMBER: 2100194

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14. REMOVE CURB DROP INLET

ASSOCIATED STRUCTURE

FENCING AND CONCRETE PAD

21. REMOVE CABLE LINE / STRUCTURE

25. REMOVE WATER METER / WATER LINE

DEMOLITION LEGEND

17. REMOVE GUY WIRE

22. REMOVE POST

24. REMOVE SIGN

UTILITY STRUCTURE

23. REMOVE PLAYGROUND

15. REMOVE GAS STRUCTURE & ASSOCIATED PIPE

18. REMOVE HVAC AND ASSOCIATED PROTECTIVE

19. REMOVE MAILBOX AND ASSOCIATED CONCRETE

20. REMOVE OVERHEAD WIRE AND ASSOCIATED

16. REMOVE UNDERGROUND POWER LINE &


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ITEM TO BE REMOVED


TO BE REMOVED, AREA

### **EROSION & SEDIMENT CONTROL LEGEND**

No.	TITLE	KEY	SYMBOL
3.01	SAFETY FENCE	SAF	-0
3.02	TEMPORARY STONE CONSTRUCTION ENTRANCE	CE	
3.05	SILT FENCE	SF	××
3.07	STORM DRAIN INLET PROTECTION	( <u>P</u> )	
3.31	TEMPORARY SEEDING	TS	ALL APPLICABLE AREAS
3.39	DUST CONTROL	DC	ALL APPLICABLE AREAS

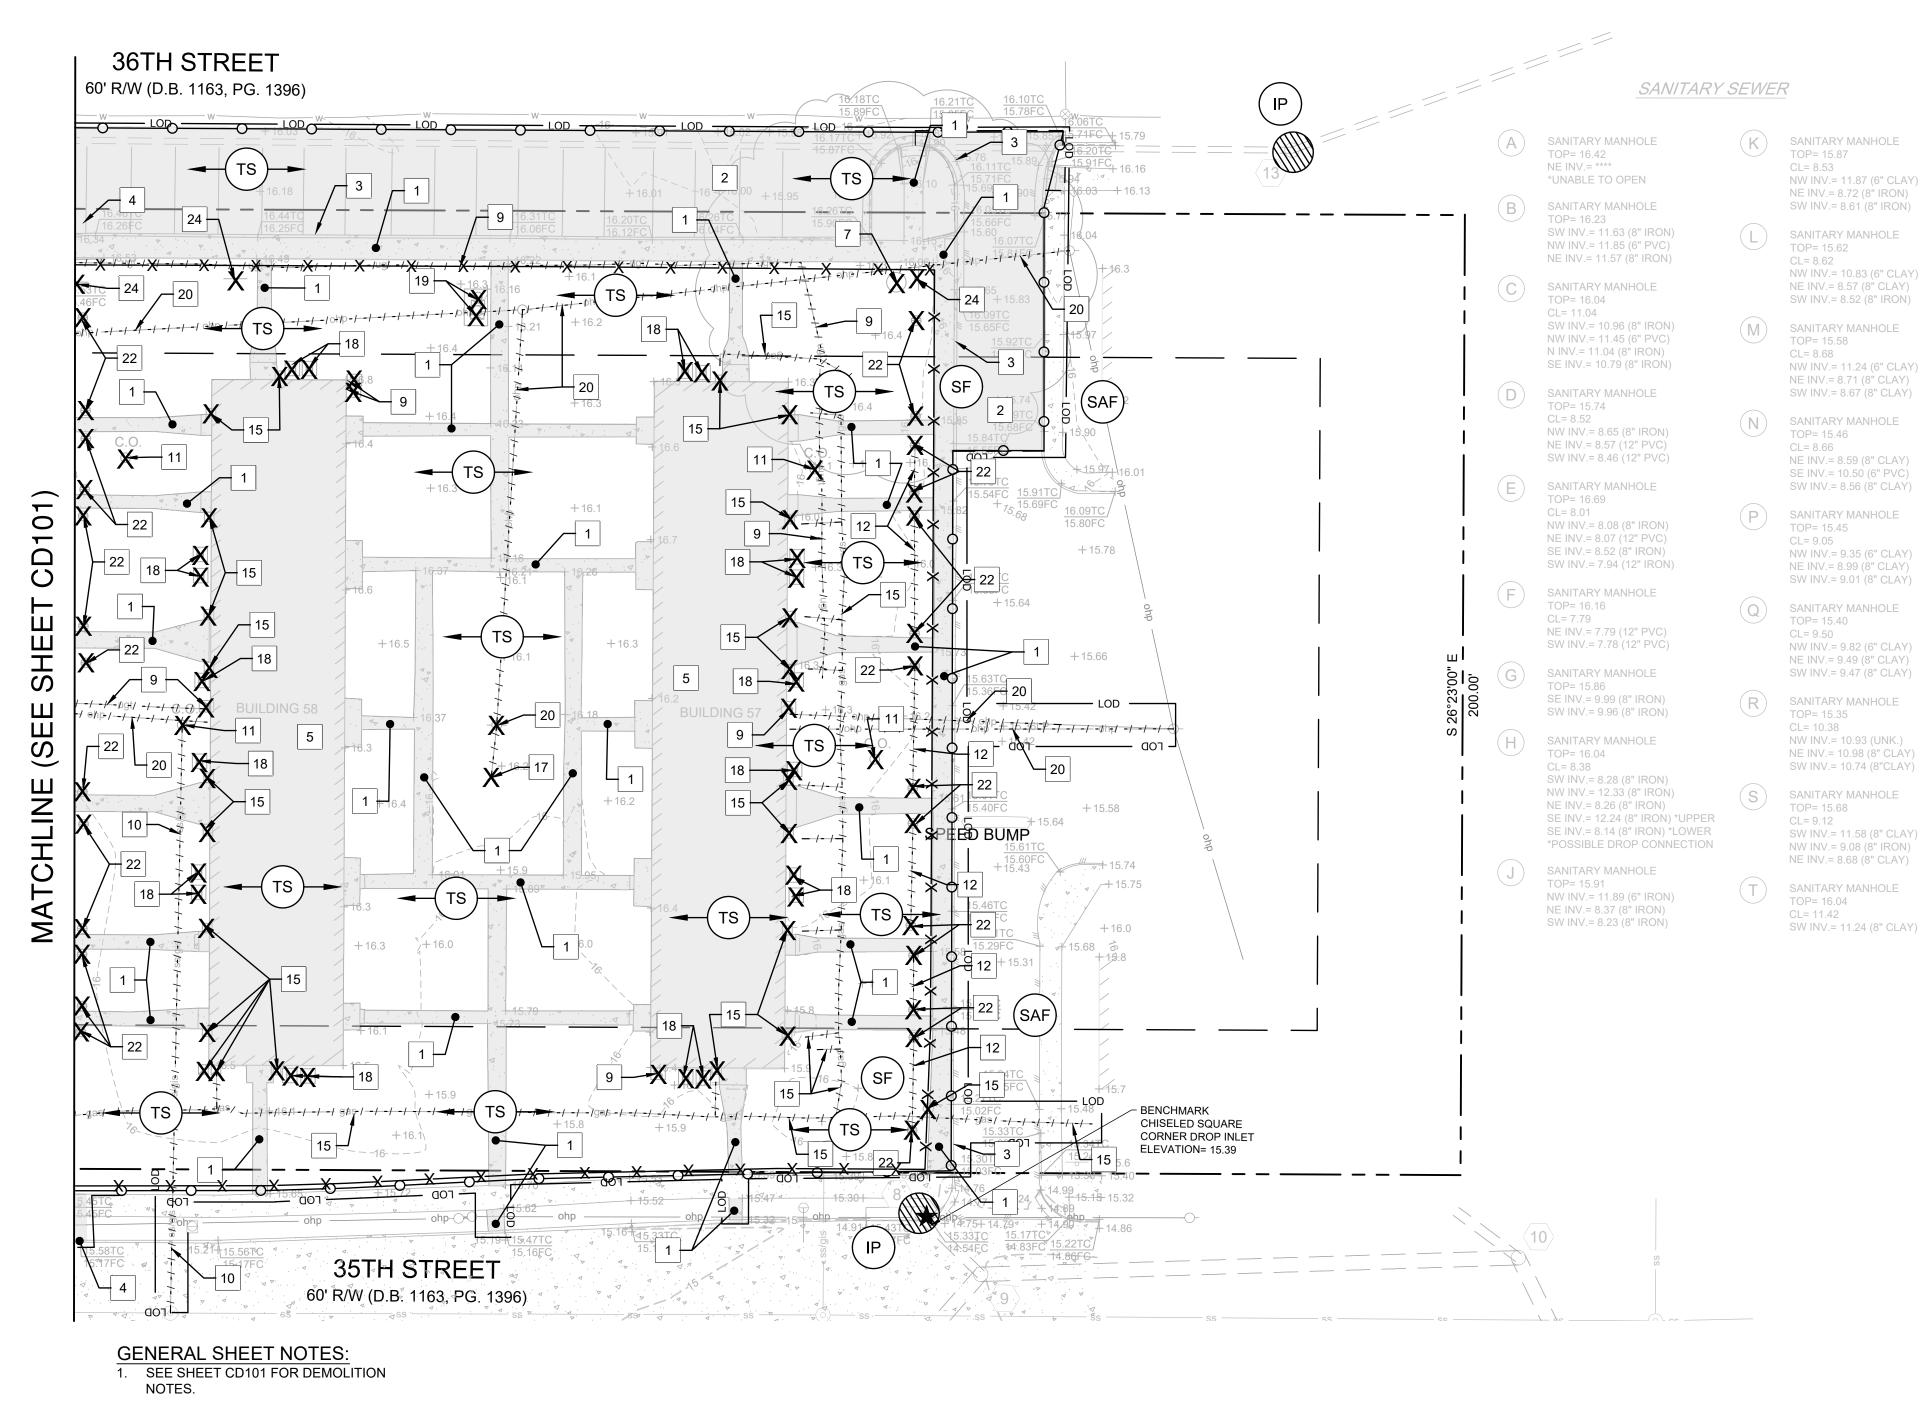

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DEMOLITION AND E&S PHASE I PI MARSHALL COURTS APARTME NNHRA, PHASE 7
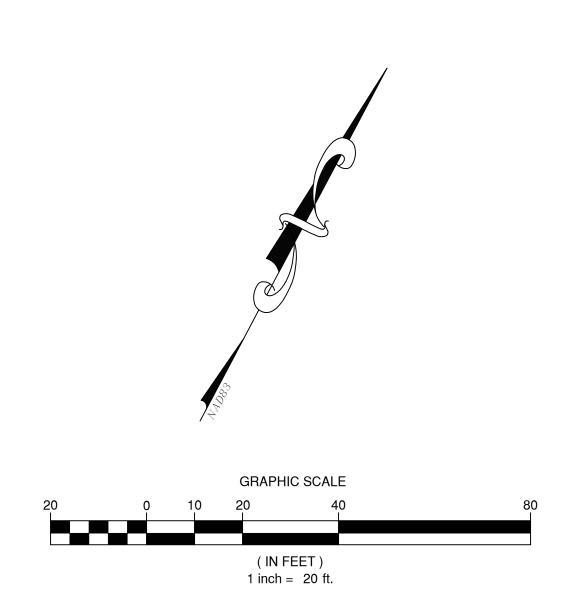
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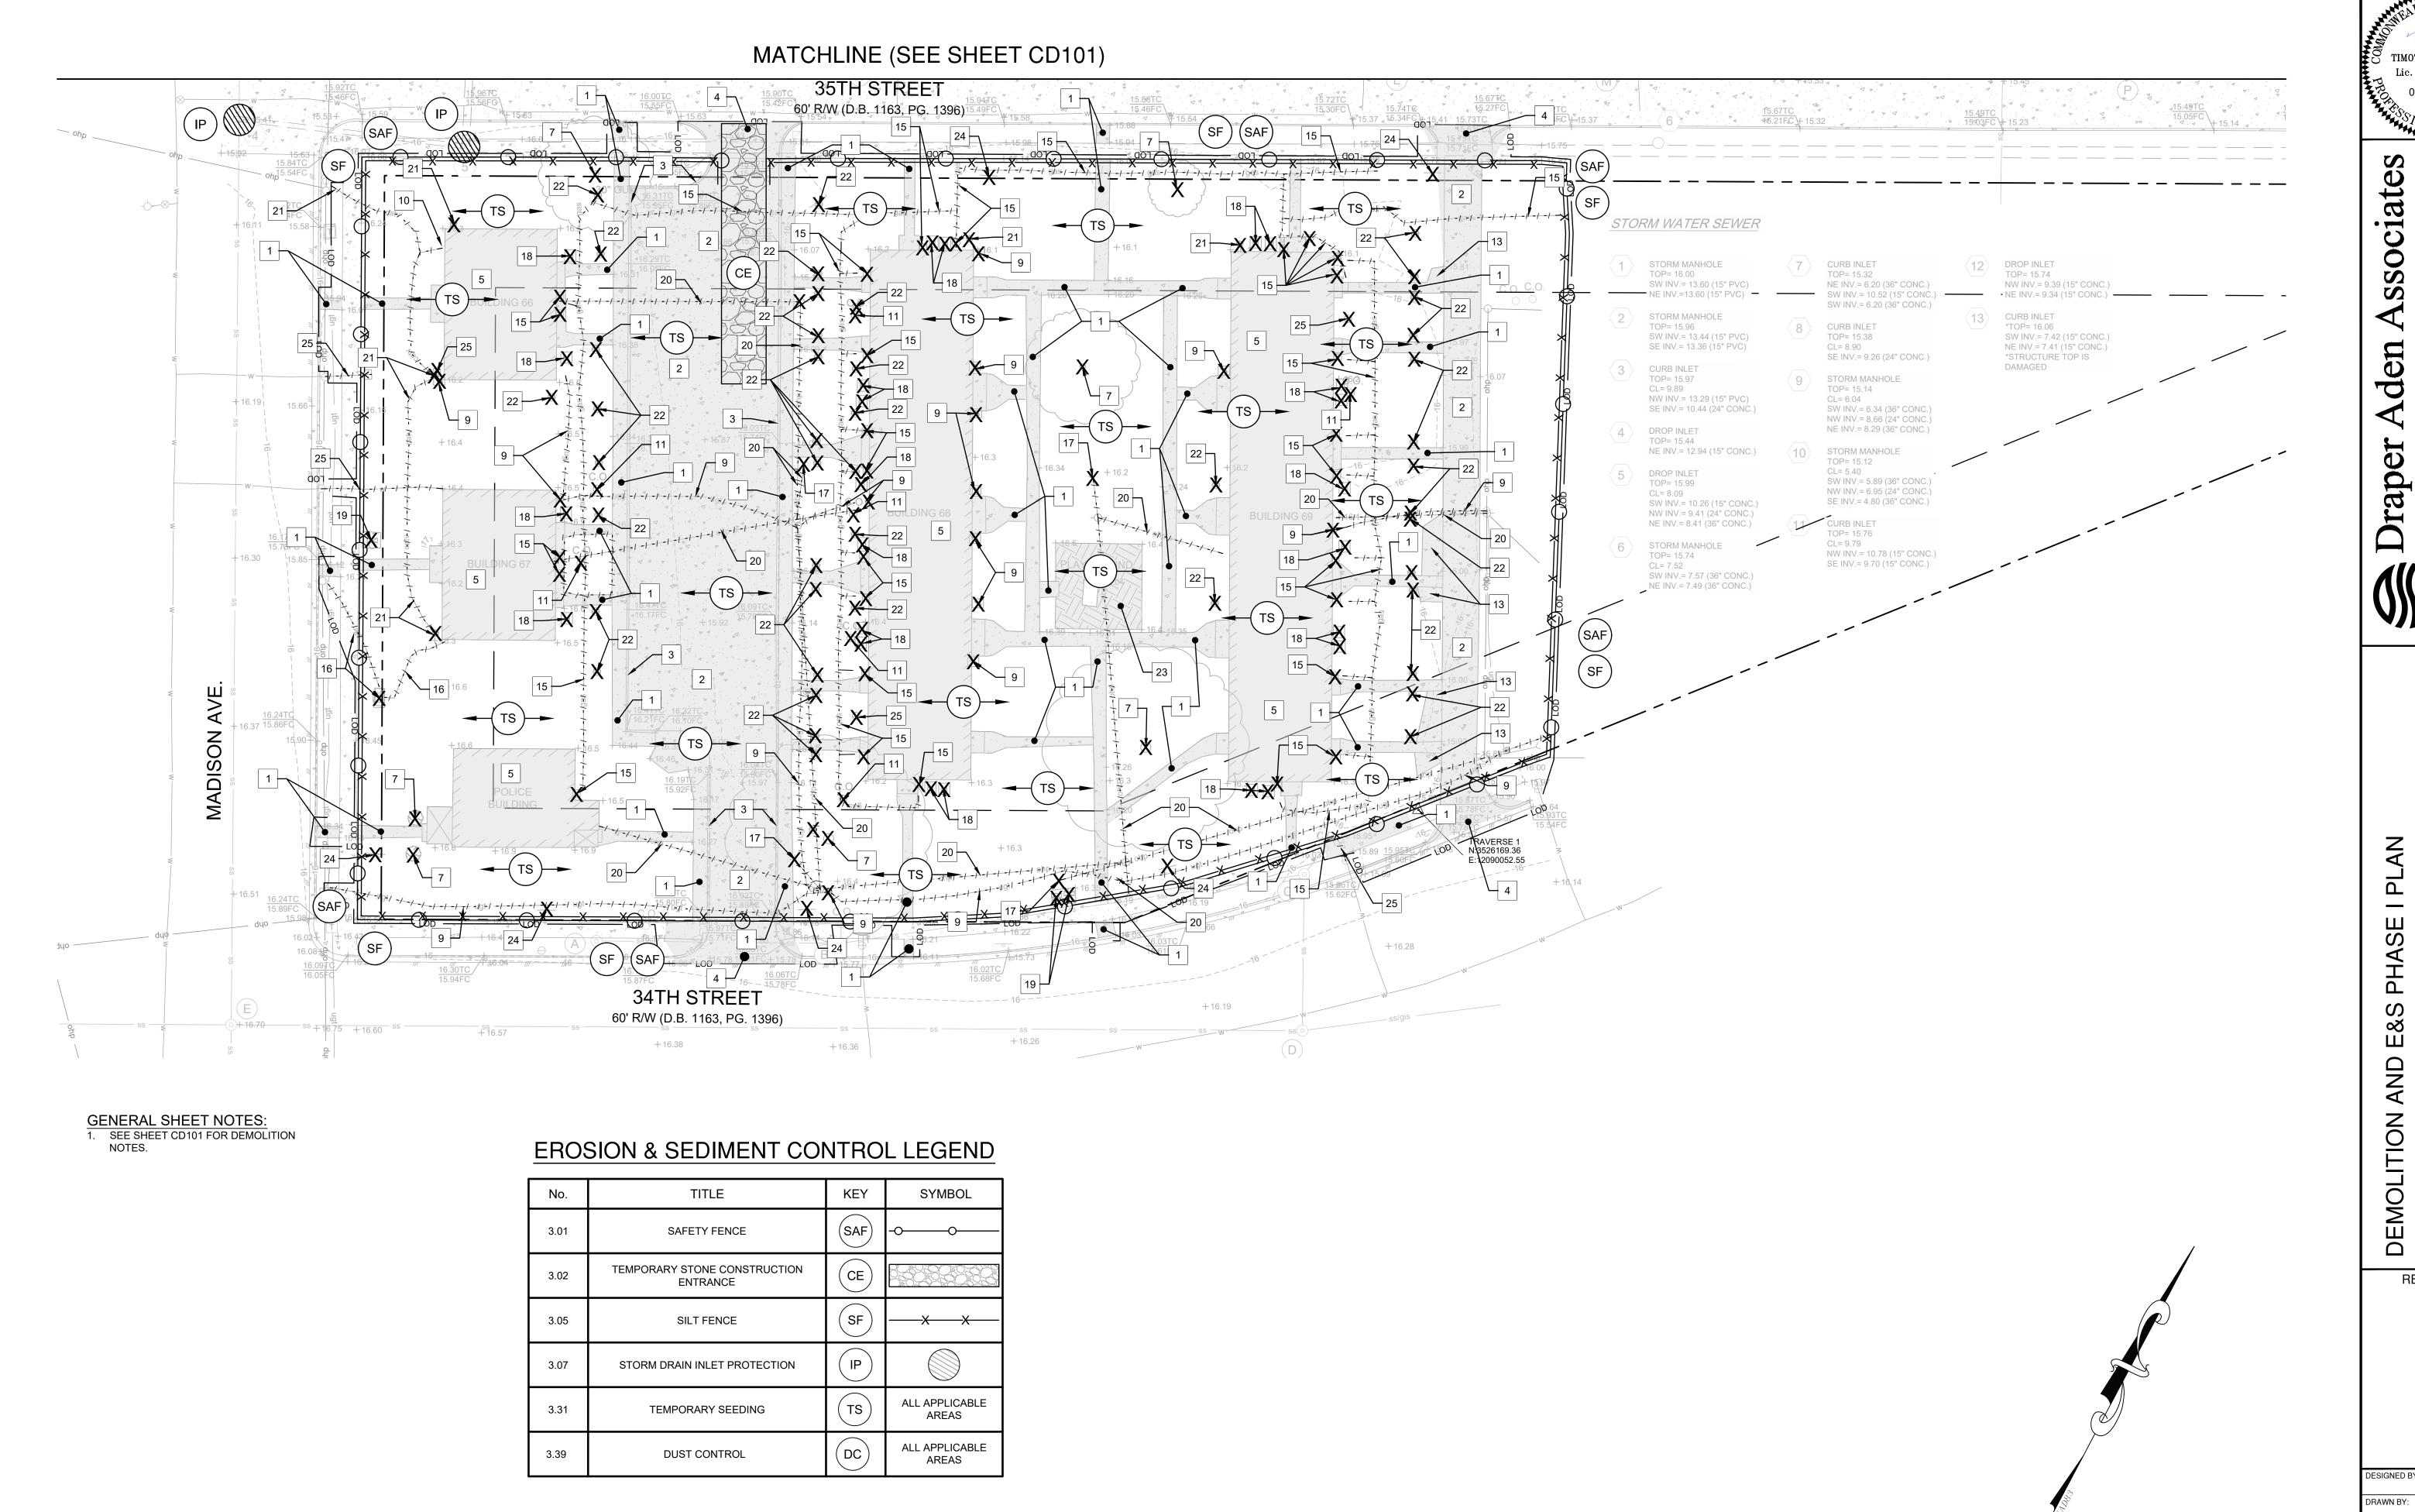
rap

**REVISIONS** 

DESIGNED BY: DRAWN BY: CHECKED BY:

1" = 20' AUGUST 7, 2024 ROJECT NUMBER: 2100194

CD102



AN NTS, DEMOLITION AND E&S PHASE I PI MARSHALL COURTS APARTME NNHRA, PHASE 7

**REVISIONS** 

DESIGNED BY:

CHECKED BY:


**GRAPHIC SCALE** 

( IN FEET ) 1 inch = 20 ft.

1" = 20' AUGUST 7, 2024 ROJECT NUMBER:


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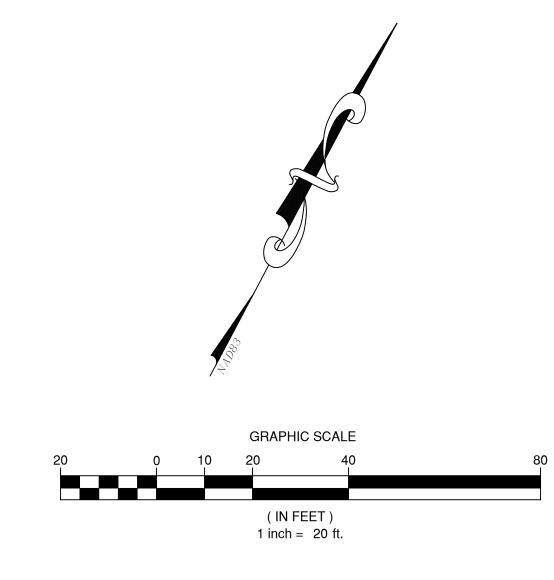
CD103

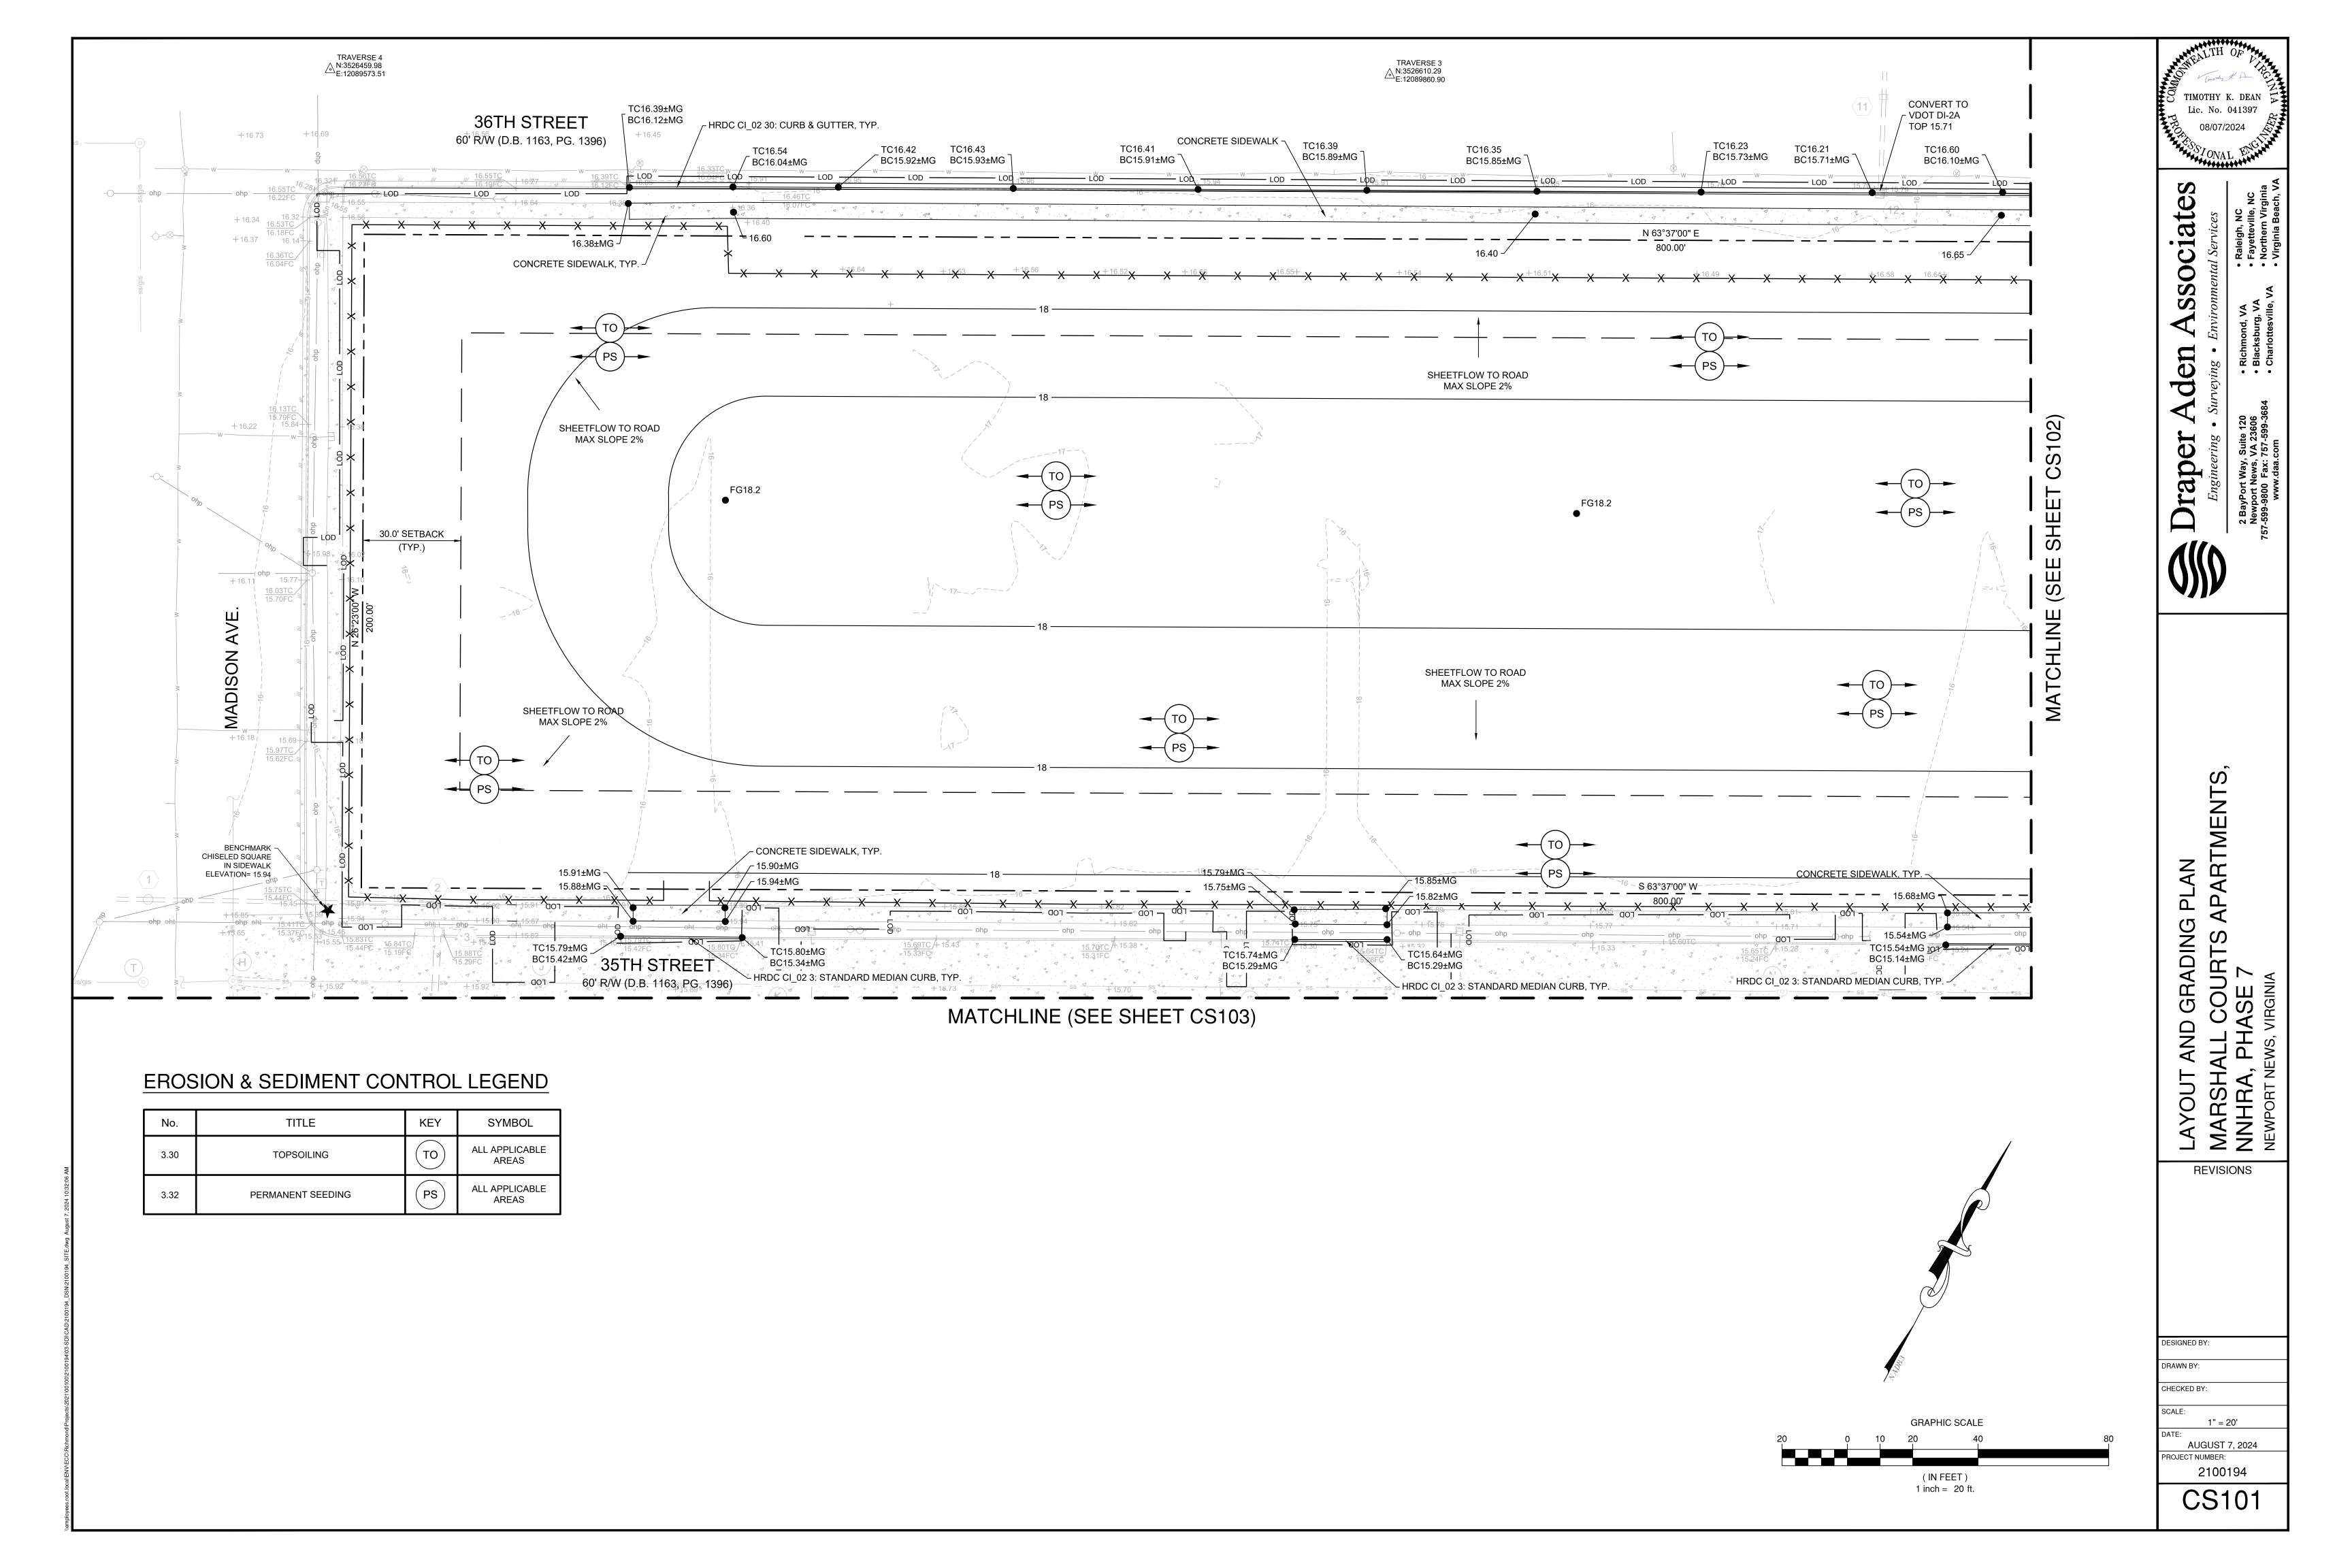

# **EROSION & SEDIMENT CONTROL LEGEND**

No.	TITLE	KEY	SYMBOL
3.30	TOPSOILING	ТО	ALL APPLICABLE AREAS
3.32	PERMANENT SEEDING	PS	ALL APPLICABLE AREAS



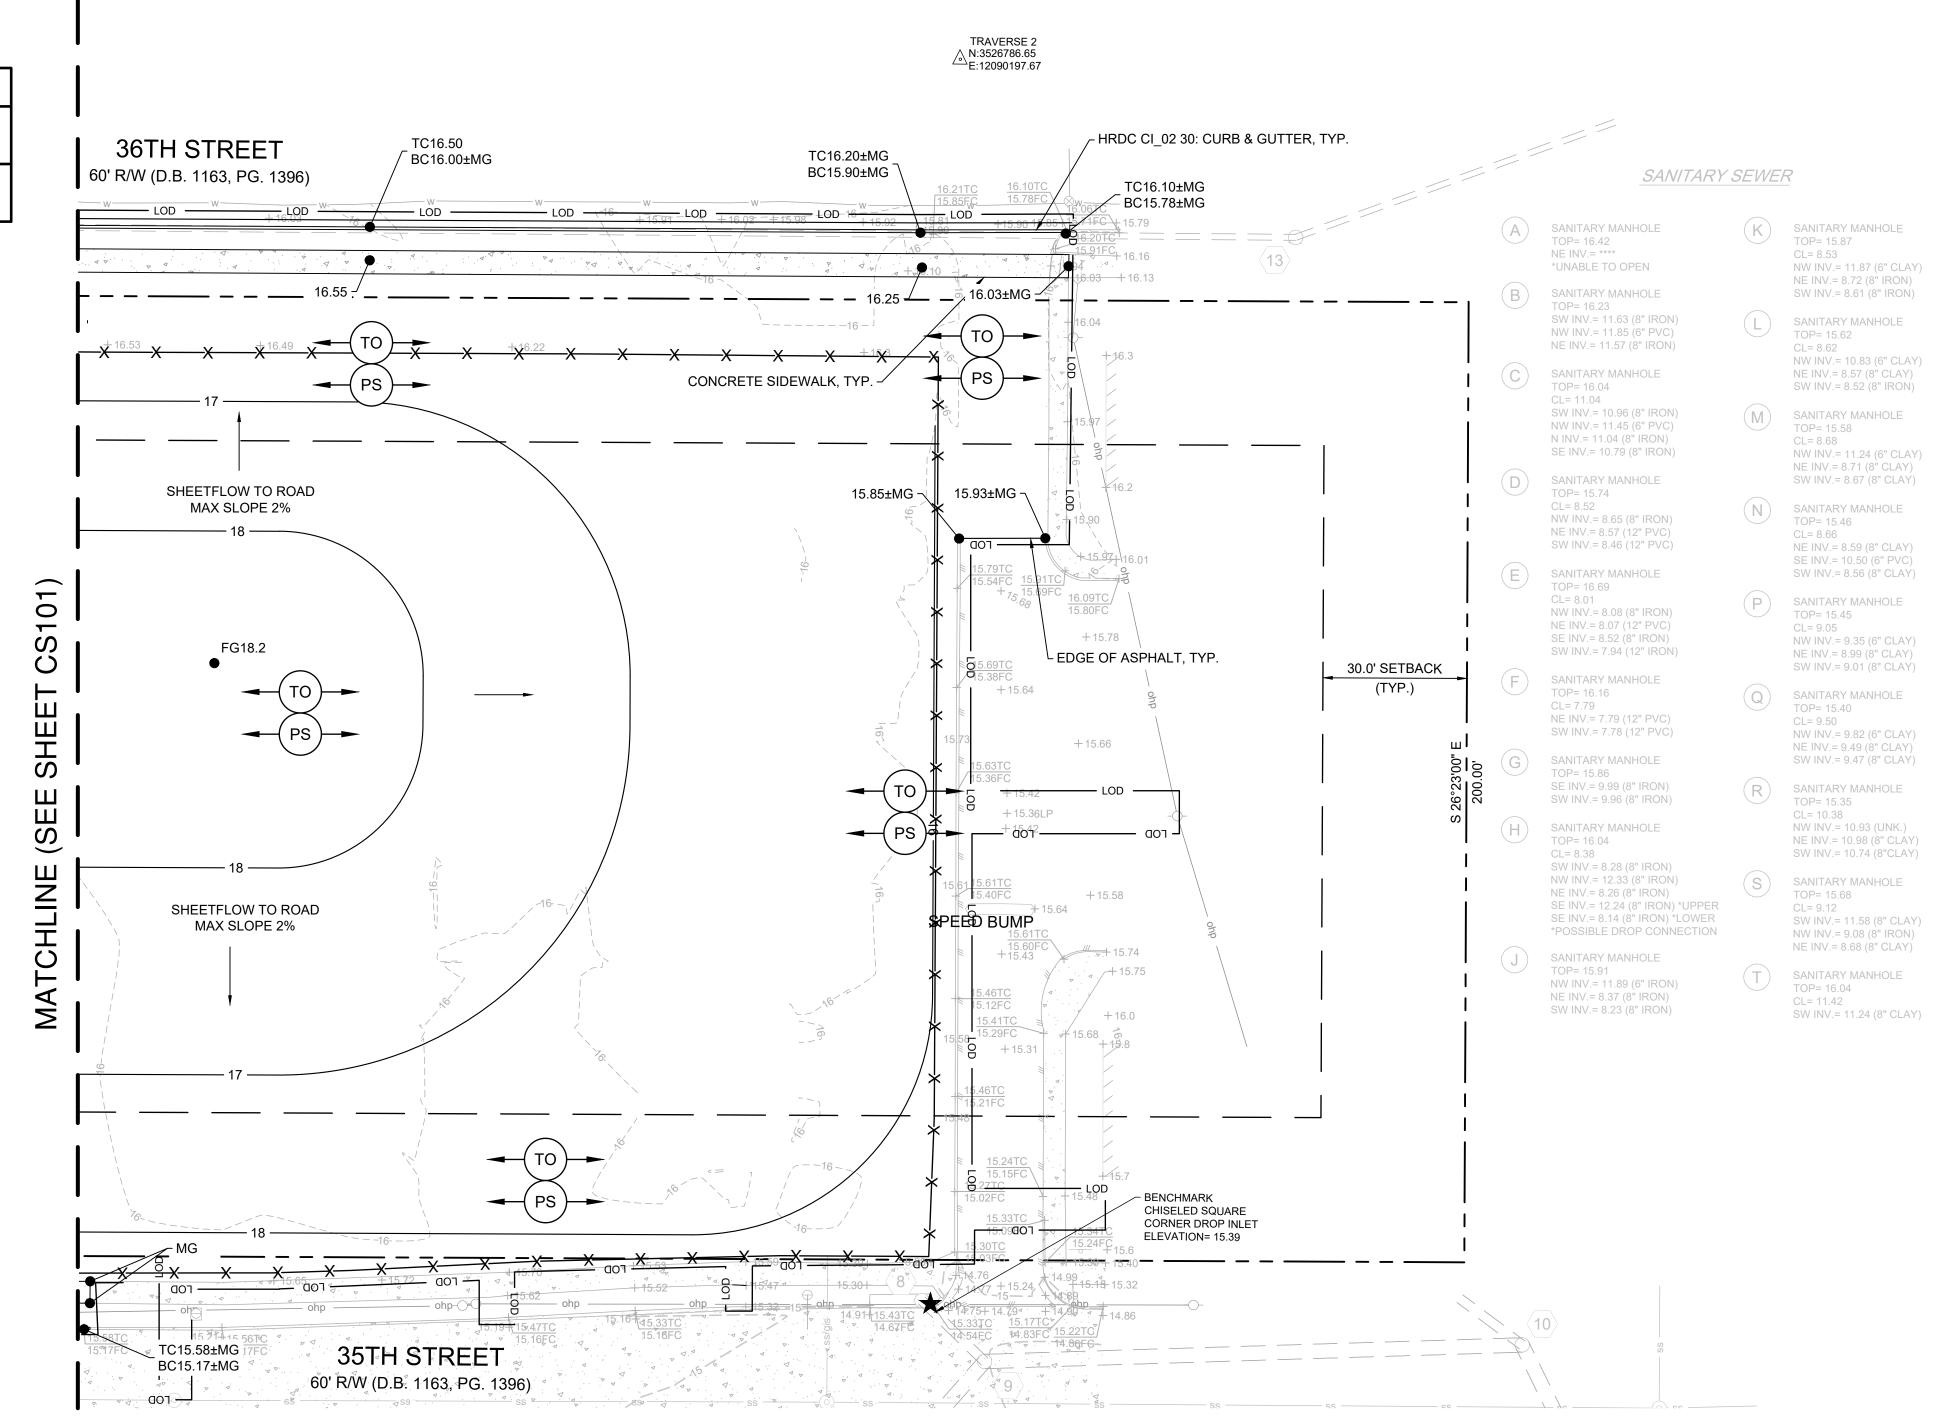

TIMOTHY K. DEAN

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**APARTME** 

**GRADING PLAN** 


REVISIONS

DESIGNED BY: DRAWN BY:

1" = 20' AUGUST 7, 2024 ROJECT NUMBER:

2100194


CS102

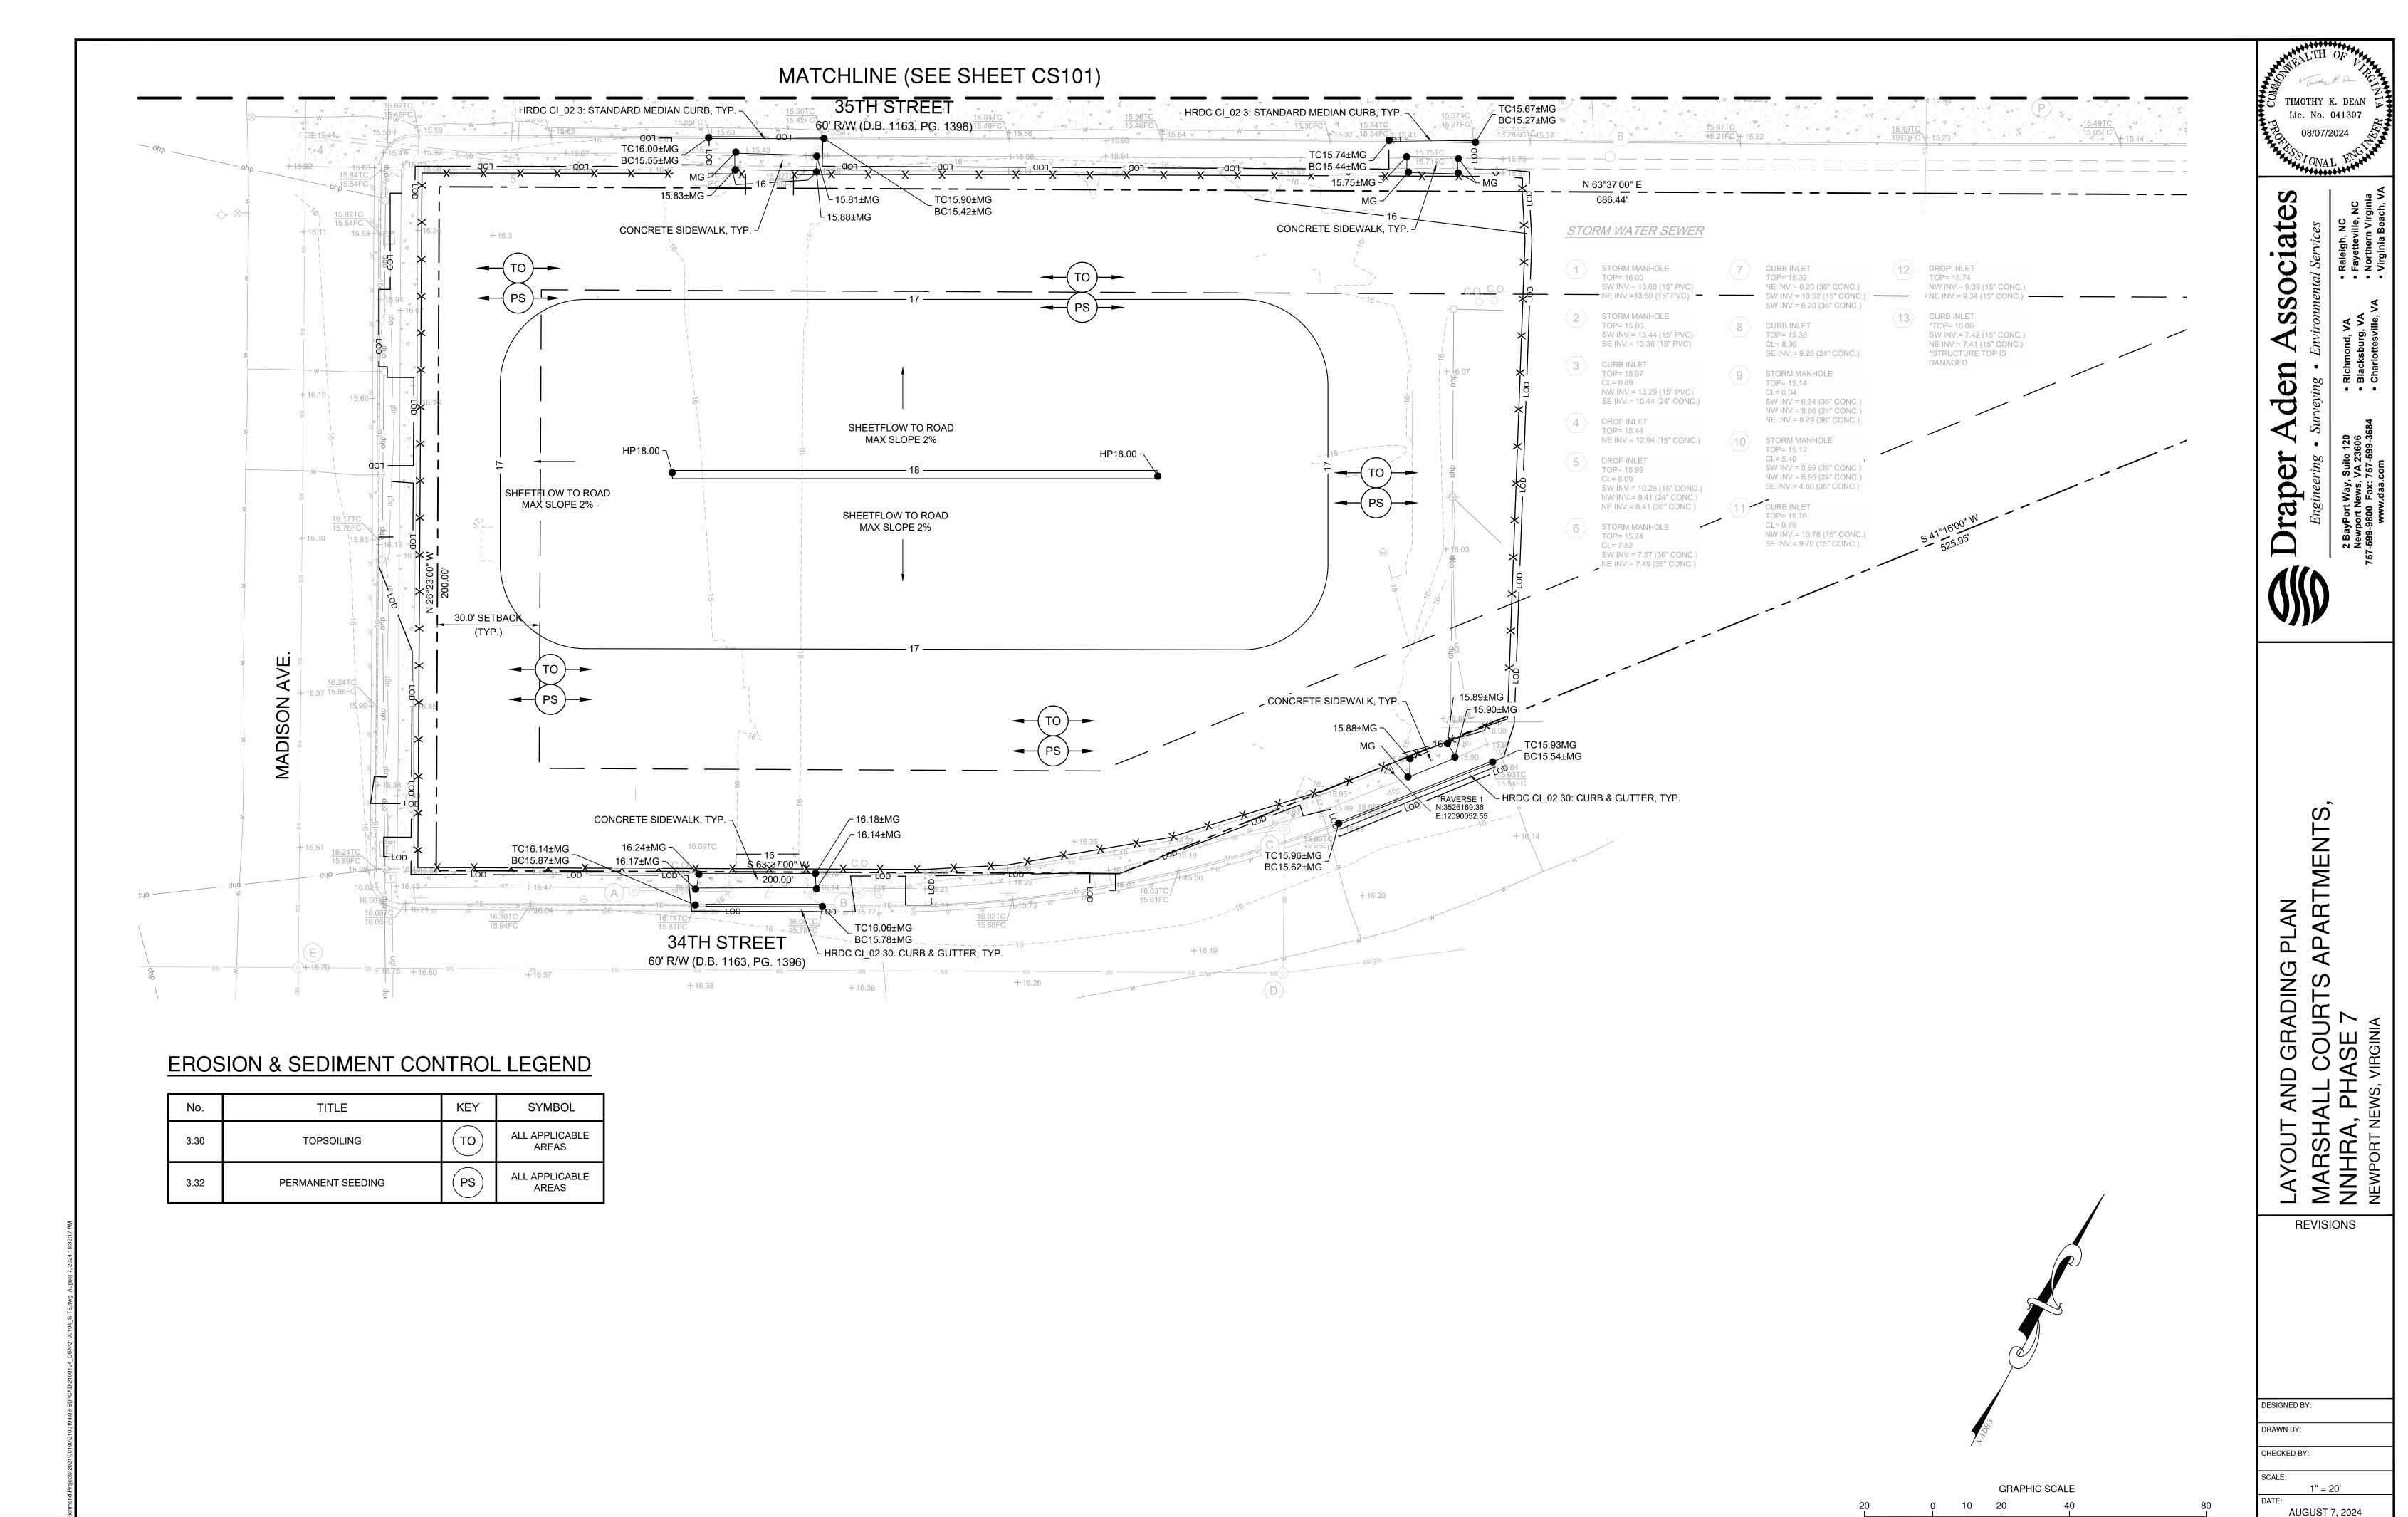


ROJECT NUMBER:

( IN FEET ) 1 inch = 20 ft. 2100194

CS103

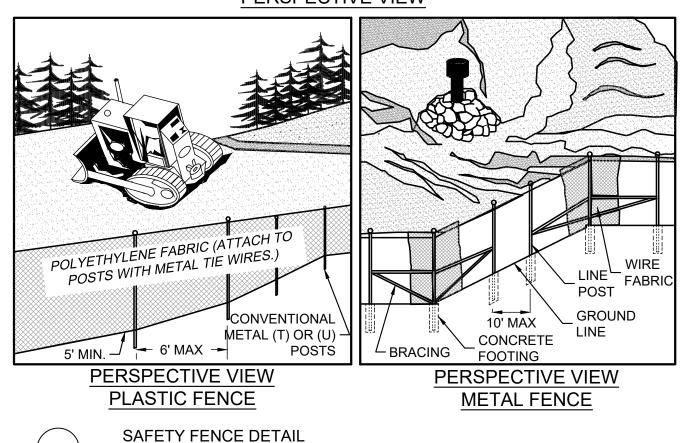


NOT TO SCALE

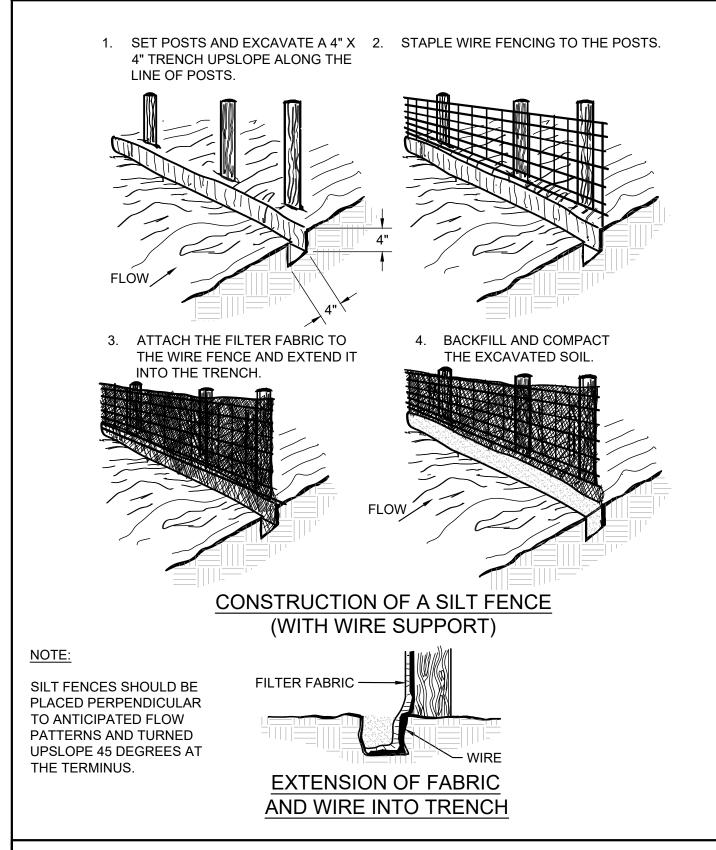

SILT FENCE INSTALLATION DETAILS WITH WIRE BACKING


NOT TO SCALE

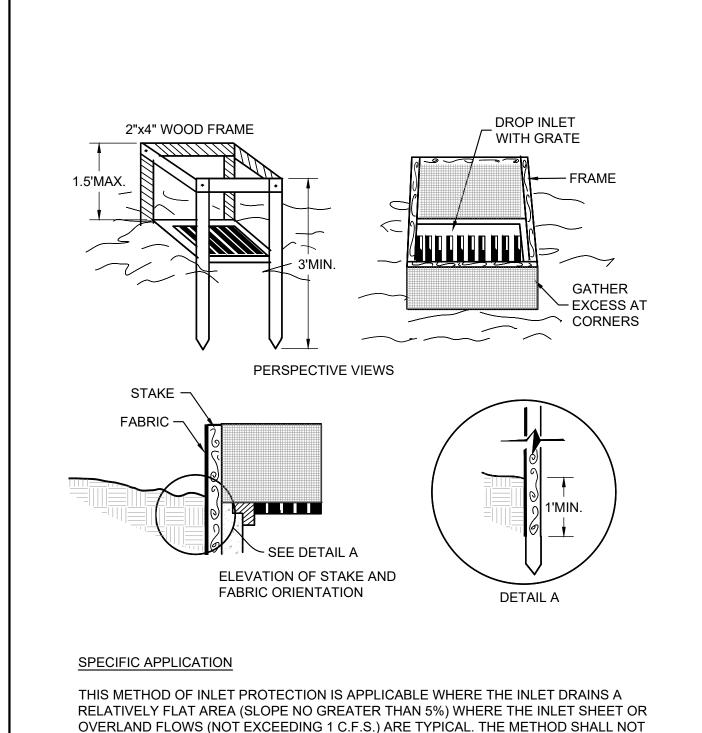



SILT FENCE DROP INLET PROTECTION DETAIL NOT TO SCALE

HIGHWAY MEDIANS.

APPLY TO INLETS RECEIVING CONCENTRATED FLOWS, SUCH AS IN STREET OR

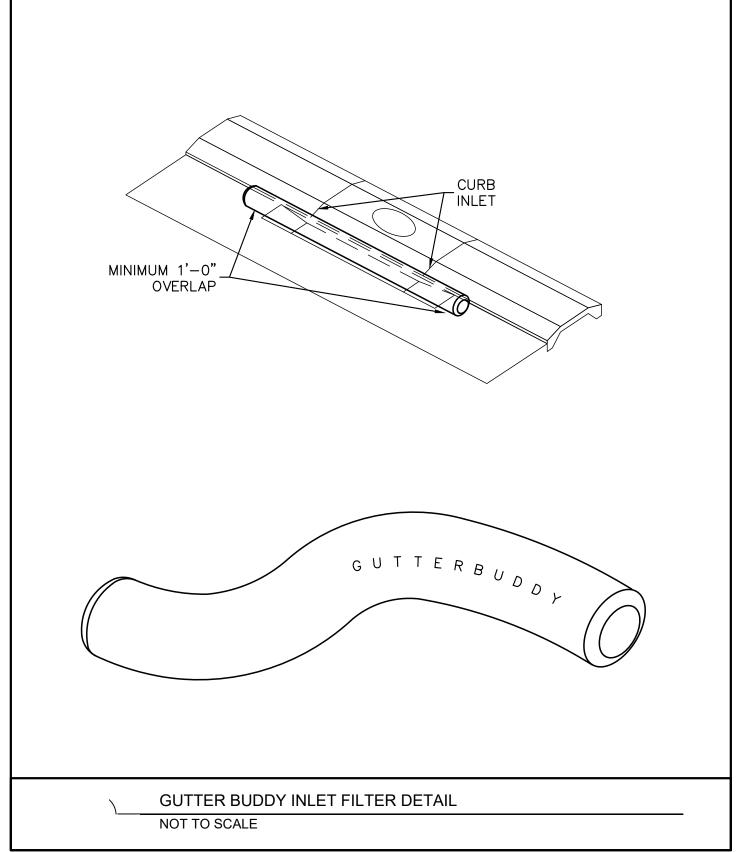

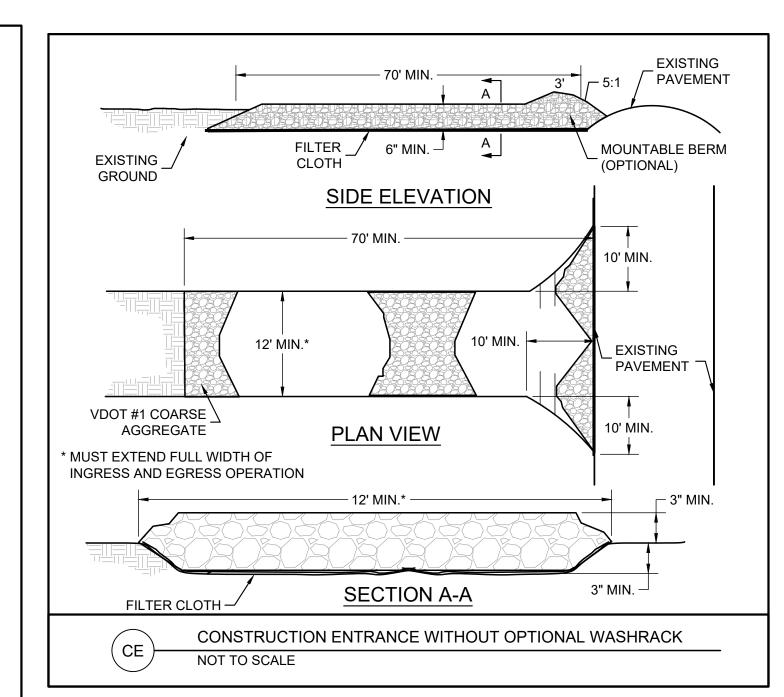

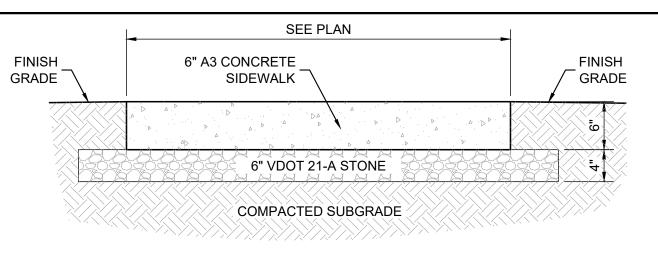

TRANSVERSE EXPANSION JOINTS SHALL BE PLACED AT 30'-0" o.c. (MAX.) TRANSVERSE CONTROL JOINTS SHALL BE PLACED AT 5'-0" o.c. BETWEEN

**EXPANSION JOINTS.** 3. LONGITUDINAL JOINTS ARE REQUIRED FOR SIDEWALKS WITH WIDTHS GREATER THAN 10'-0". LONGITUDINAL JOINTS SHALL BE PLACED AT EQUAL INTERVALS NOT TO EXCEED 10'-0" IN WIDTH.

> TYPICAL SIDEWALK DETAIL NOT TO SCALE

PERMANENT SEEDING (PS)

TABLE 3.32-D SITE SPECIFIC SEEDING MIXTURES FOR COASTAL PLAIN AREA

MINIMUM CARE LAWN TOTAL LBS. PER ACRE -COMMERCIAL OR RESIDENTIAL -KENTUCKY 31 OR TURF-TYPE TALL FESCUE 175-200 LBS. -COMMON BERMUDAGRASS \*\* 75 LBS.

<u> HIGH-MAINTENANCE LAWN</u> -KENTUCKY 31 OR TURF-TYPE TALL FESCUE 200-250 LBS.

-HYBRID BERMUDAGRASS (SEED) \*\* 40 LBS. (UNHULLED) 30 LBS. (HULLED) OR

-HYBRID BERMUDAGRASS (BY OTHER VEGETATIVE ESTABLISHMENT METHOD, SEE STD. & SPEC. 3.34)

GENERAL SLOPE (3:1 OR LESS) -KENTUCKY 31 FESCUE -RED TOP GRASS -SEASONAL NURSE CROP \*

NOVEMBER 16 THROUGH JANUARY

20 LBS. 150 LBS. LOW-MAINTENANCE SLOPE (STEEPER THAN 3:1) 93-108 LBS.

128 LBS.

WINTER RYE

50-100

2 LBS.

-KENTUCKY 31 FESCUÉ -COMMON BERMUDAGRASS \*\* 0-15 LBS. -RED TOP GRASS 2 LBS. -SEASONAL NURSE CROP \* 20 LBS. -SERICEA LESPEDEZA \*\* 20 LBS.

USE SEASONAL NURSE CROP IN ACCORDANCE WITH SEEDING DATES AS STATED BELOW: FEBRUARY, MARCH THROUGH APRIL ANNUAL RYE MAY 1ST THROUGH AUGUST FOXTAIL MILLET SEPTEMBER, OCTOBER THROUGH NOVEMBER 15 ANNUAL RYE

\*\* MAY THROUGH OCTOBER USE HULLED SEED. ALL OTHER SEEDING PERIODS. USE UNHULLED SEED. WEEPING LOVEGRASS MAY BE ADDED TO ANY SLOPE OR LOW-MAINTENANCE MIX DURING WARMER SEEDING PERIODS; ADD 10-20 LBS./ACRE IN

PERMANENT SEEDING (COASTAL VIRGINIA) NOT TO SCALE

**TEMPORARY SEEDING** 


TABLE 3.31-B ACCEPTABLE TEMPORARY SEEDING PLANT MATERIALS "QUICK REFERENCE FOR ALL REGIONS"

RATE (LBS./ACRE) PLANTING DATES SEPT. 1-FEB. 15 50/50 MIX OF ANNUAL RYEGRASS 50-100 (LOLIUM MULTI-FLORUM) & CEREAL (WINTER) RYE (SECALE CEREALE)

FEB. 16-APR. 30 ANNUAL RYEGRASS (LOLIUM MULTI-FLORUM) 60-100

MAY 1—AUG. 31 GERMAN MILLET <u>(SETARIA ITALICA)</u>

**TEMPORARY SEEDING** NOT TO SCALE

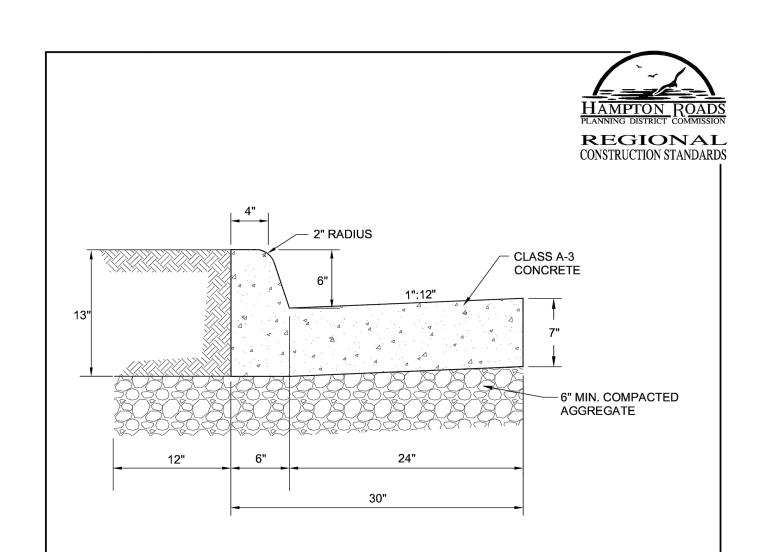


CRACK CONTROL JOINTS TO BE PROVIDED AT 10 FT. INTERVALS BY SAWING, SCORING, "LEAVE-IN" INSERTS, OR CUTTER PLATES TO 1-1/2 INCH DEPTH.

EXPANSION JOINTS TO BE INSTALLED PER SPECIFICATIONS SECTION 502.

AS SOON AS CONCRETE WILL NOT SLUMP, FACE FORMS ARE TO BE REMOVED, IRREGULARITIES REMOVED, A LIGHT BROOM FINISH GIVEN, AND LIQUID MEMBRANE SEAL OR OTHER APPROVED CURING MEDIUM APPLIED.

THE CONTRACTOR SHALL PREVENT THE TEMPERATURE AT THE SURFACE OF THE CONCRETE FROM FALLING BELOW 40°F DURING THE FIRST 72 HOURS IMMEDIATELY FOLLOWING CONCRETE PLACEMENT. PROTECTIVE MATERIAL SHALL BE LEFT IN PLACE FOR AN ADDITIONAL 48 HOURS IF FREEZING AIR TEMPERATURES ARE EXPECTED TO CONTINUE.

SHEET No. DETAIL NO. 1 OF 1 CI\_02 200,502 CONCRETE ITEMS 12/10 1 OF 1

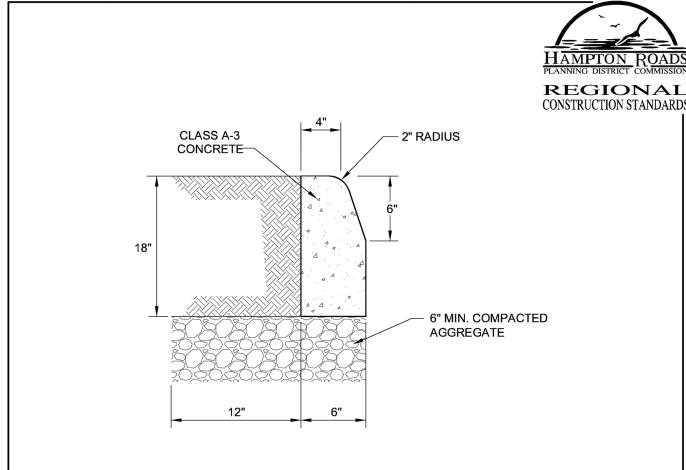

NOTES:

CRACK CONTROL JOINTS TO BE PROVIDED AT 10 FT. INTERVALS BY SAWING, SCORING, "LEAVE-IN" INSERTS, OR CUTTER PLATES TO 1-1/2 INCH DEPTH.

2. EXPANSION JOINTS TO BE INSTALLED PER SPECIFICATIONS SECTION 502.

AS SOON AS CONCRETE WILL NOT SLUMP, FACE FORMS ARE TO BE REMOVED, IRREGULARITIES REMOVED, A LIGHT BROOM FINISH GIVEN, AND LIQUID MEMBRANE SEAL OR OTHER APPROVED CURING MEDIUM APPLIED.

THE CONTRACTOR SHALL PREVENT THE TEMPERATURE AT THE SURFACE OF THE CONCRETE FROM FALLING BELOW 40°F DURING THE FIRST 72 HOURS IMMEDIATELY FOLLOWING CONCRETE PLACEMENT. PROTECTIVE MATERIAL SHALL BE LEFT IN PLACE FOR AN ADDITIONAL 48 HOURS IF FREEZING AIR TEMPERATURES ARE EXPECTED TO CONTINUE.

## STANDARD MEDIAN CURB

NOT TO SCALE 200,502 CONCRETE ITEMS 12/10 1 OF 1 CI\_03

TIMOTHY K. DEAN 08/07/2024

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 $\triangleleft$ OURT SE 7 **REVISIONS** 

DESIGNED BY:

DRAWN BY: CHECKED BY:

NONE

AUGUST 7, 2024 PROJECT NUMBER: 2100194

C-500

THE USE OF ANY PROPRIETARY EROSION AND SEDIMENT CONTROL MEASURES TO BE APPROVED BY THE ENVIRONMENTAL INSPECTOR. 30" CURB & GUTTER NOT TO SCALE



### City of Newport News Stormwater Site Plan Worksheet

Please note this worksheet is provided for informational purposes and is not intended to exempt the developer from reviewing and complying with the latest federal, state, and local regulations.

ialest lederal, state, and i	ocal regulations.	
OVERALL INFORMATION		
Site Plan Title: MARSHALL COUF	RTS APARTMENTS, NNHRA, 2013 AND PHASE 7	
Plan Address: 741 34th Street NE		
	nent □ Redevelopment ☑ Right of Way □	
HUC: <u>020802080303, JL58</u>	Latitude/ Longitude in Decimal Degrees: 36.99434,-76.41941	
	MS4 □ Wetlands □ River/Ditch/Stream □	
Name of Receiving Waters: Frontal	Hampton Roads - Hampton River	
Parcel Tax ID: <u>300030205</u>	GPIN No (If Available):	
	WS HOUSING AND REDEVELOPMENT	

	T	otal Area of Disturb	ance: 7.	31	acres	318,315 sq	. ft.
		List the	e land uses with	in the	limits of disturba	nce only	
		Pre Development				Post Development	
	Area (sq.ft.)	Area (acres)	Area (%)		Area (sq.ft.)	Area (acres)	Area (%)
Pervious - Forest/Open Space:							
Pervious - Managed Turf:	136,924	3.14	43		213820	4.91	67
Pervious Surface Subtotal:							
Impervious Surface Total:	181,391	4.16	57		104,495	2.40	33
TOTAL AREA:	318,315	7.31	100		318,315	7.31	100

Review and Check each to indicate acknowledgement:

Owner's Address: PO BOX 0797 NEWPORT NEWS, VA 23607

- For developments using technical criteria IIC under the "grandfathering" clause, supporting documentation and calculations must be submitted with the initial site plan submission. A description of why the site qualifies should be included in the site's stormwater narrative on the plans.
- Development cannot cause flooding to adjacent or downstream properties. Site development must take into account current drainage patterns and the capacity of each individual site outfall discharge point, including those that are City or VDOT maintained. When evaluating discharge at an outfall point, all flow to that point must be included, such as flow from outside the disturbed area and off-site.
- The City of Newport News' General Notes, Erosion & Sediment Control General Notes, and the MS-19 Minimum Standards must be provided on all site plans. Latest editions are available on the Newport News Site & Subdivision website.
- Necessary construction permits must be obtained prior to any land disturbing activity. Failure to obtain these permits may result in a "STOP WORK" order being issued. As part of the Construction Permit process, a Stormwater Pollution Prevention Plan (if required) must be completed and submitted to the City's Engineering Department at the preconstruction meeting. This document must remain on site and be updated routinely to accurately reflect the up to date work on the site.
- Construction Record Drawings will be required as per the City's Construction Record Drawing administrative policy prior to project final acceptance and

Project Land Disturbance Area ( <b>LDA</b> )	In a CBPA?	Part of a Common Plan of Development	E&SC Plan 9VAC25-840 Erosion & Sediment Control Plan	Water Quantity 9VAC25-870-66		Nater 9VAC28 et from (	5-870-6	3	Full <b>SWMP</b> 9VAC25-870-55 Stormwater Management Pla
	□ No	□ No							
2,500sf ≤	LI NO	☐ Yes			<b>□</b> 1	<b>□</b> 3	<b>4</b>	<b>□</b> 5	
LDA ≤ 10,000sf	□ Yes	□ No			<b>□</b> 1	<b>3</b>	<b>4</b>	<b>□</b> 5	
≥ 10,000S1	165	☐ Yes			<b>□</b> 1	<b>□</b> 3	<b>□</b> 4	<b>□</b> 5	<b>-</b>
	□ No	□ No							
10,000sf≤	LI NO	☐ Yes			<b>□</b> 1	<b>□</b> 3	<b>4</b>	<b>□</b> 5	
LDA ≤ 1 acre	□ Yes	□ No			<b>□</b> 1	<b>3</b>	<b>□</b> 4	<b>□</b> 5	
2 1 acie	163	☐ Yes			<b>□</b> 1	<b>3</b>	<b>4</b>	<b>□</b> 5	□
	☑ No	<b>团</b> No		☑	<b>□</b> 1	<b>☑</b> 2	<b>4</b>	<b>□</b> 5	✓
<b>V</b>	E INO	□ Yes			<b>□</b> 1	<b>2</b> 2	<b>□</b> 4	<b>□</b> 5	
LDA > 1 acre	□ Yes	□ No	6		<b>□</b> 1	<b>□</b> 2	<b>4</b>	<b>□</b> 5	
	163	☐ Yes			<b>□</b> 1	<b>□</b> 2	<b>4</b>	<b>□</b> 5	
2 – Redevelopm 3 – Redevelopm	pment • • • nent – NO nent – NO	net increase in imp net increase in imp increase in imper	rus (TP) load cannot exceed ervious cover, LDA ≥ 1 acre • ervious cover, LDA < 1 acre • rious cover • • • • New Incre	•••••Total Phosphorus mu •••••Total Phosphorus mu ased Imp. area–Criteria 1 plus	ist be red Remain	duced <u>ing</u> are	10% be a-Crite	elow pre ria 2 or 3	e-dev phosphorus load
					dua a d 0	00/ hal	OW DEC	· davala	nad nhaanbarra laadi

1 – Linear UTILITY projects can be considered maintenance when the site is returned to predeveloped conditions after completion and no change occurs in impervious area and runoff characteristics. See DEQ Guidance Memo No. 15-2003 for requirements and qualifications.

JUIIIWAICI D	esign Cr	iteria:		IIB (	Clearingh	nouse 🗷	IIB	Previously	Permitted	□ -Proje	ct & Date:						
				IIC (	Grandfat	hered 🗖	IIC	Previously	Permitted	□ -Proie	ct & Date:						
s Low Impact	Develop	ment	Imple	mente	ed? Y	es 🗖	No <b></b>	•		,	-						
•	·																
<b>SWMF INFOF</b> Include ALL fa								TON AND			A ONLY						
SWMF	ionitios id	71 417			Pretreat		/ / / / LIS		QUALITY		UANTITY		Pre Deve	elopment	Post Deve	elopment	
No. Type of	f SWMF	DEQ	(%	ff. %)	Req? (Y/N)	TP	TN Removal		it Volume <sup>1</sup> oic ft)		ume <sup>2</sup> pic ft)	Area	Pervious	Imp.	Pervious	lmp.	Total CDA
on and	Level	Spec. No.	RR	TP	Include table	(lbs/yr)	(lbs/yr)		Provided	<u> </u>	Provided	Alea	Area	Area	Area	Area	(sq ft
plans)			KK	IP	below			Required	Provided	Required	Provided	0.1	(sq.ft.)	(sq.ft.)	(sq.ft.)	(sq.ft.)	
N/A	_											Site					
												Site					
												All					
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						<del></del>						All					
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A SWMF Maintenance Agreement must be completed and recorded prior to site plan approval. For each facility provide a maintenance plan, disposal information, owner contact information, and maintenance funding source information on construction record plans.

☐ Access is provided for SWMF maintenance.

Soil borings must be provided for all facilities which will require separation from the ground water table and all infiltration facilities prior to site plan approval. Provide protection for SWMF to ensure proposed location remains undisturbed during construction and sediment from unstabilized site cannot reach

☐ Minimum slope required on all underdrains is 0.5%.

All stormwater systems must be analyzed for the 100-year storm to verify no adverse rise in the HGL upstream, downstream, and on the project site.

-		- 4 I E-								<u> </u>				
	retreatmer													
Pr	ovide inforn	nation i	for applicable facilities above. S	how and	label pret	reatmer	nt on plans	s. Requiren	nents t	from BMP Clearinghouse Spec	tications.			
	5WMF	# of		Trootm	ent Vol	Label		SWMF	# of		Trootm	ent Vol	Label	
	No.	Pre-	Type of Pretreatment	Healii	CIIL VOI	on	CDA	No.	Pre-		Healii	ient voi	on	CDA
		treat	Type of Frededition	Rea	Act	plans (Y/N)	(sq. ft.)		treat		Reg	Act	plans (Y/N)	(sq. ft.)
	(above)	Req		TVCY	Aut	(Y/N)		(above)	Req		ixeq	Aut	(Y/N)	` '
			1							11				
			2					+ NI/A		2				
			2				$\vdash$	⊤N/A		2				
			3							[3]				
	CVA/NAE	# of		T .	()//	Label		CVA/BAE	# of		Τ+ .	()//	Label	
	SWMF	Pre-	T f D t t t	reatm	ent Vol	on	CDA	SWMF	Pre-		reatm	ent Vol	on	CDA
	No.	treat	Type of Pretreatment		Α.,		(sq. ft.)	No.	treat		_	Α.		(sq. ft.
	(above)	Reg		Req	Act	plans (Y/N)	(04. 1)	(above)	Req		Req	Act	plans (Y/N)	(04. 11.
		<u> </u>	1			<u> </u>				1				
			<u> </u>				$\vdash$			<u>-</u>				
			2							2				
			3							3				
							$\overline{}$						$\overline{}$	

WA7	ER QUANTITY - Design must satisfy one of the following:
	☑ Channel Protection (9VAC25-870-66.B) AND Flood Protection (9VAC25-870-66.C)
	☐ Sheet Flow (9VAC25-870-66.D)
WAT	ER QUANTITY - CHANNEL PROTECTION Refer to 9VAC25-870-66.B for instructions
WAI	R QUANTITY - CHANNEL PROTECTION Refer to 9VAC25-670-00.B for instructions

Discharge Point from Site (Show on Plans)	Discharge Channel	Channel Receiving channel must be analyzed to the Limits of Analysis (below).									our storm. T	his option does		OPTION C RESTORED Developmer functioning consistent with restored system
,		V <sub>2</sub>	V <sub>ALLOW</sub> *	DPTH <sub>10YR</sub>	DPTHchnL	Q <sub>POST</sub>	RVPOST	IF	Q <sub>PRE</sub>	RV <sub>PRE</sub>	Q <sub>POST</sub> X RV <sub>POST</sub>		IF x Q <sub>PRE</sub> x RV <sub>PRE</sub>	
МН9	☑ Manmade ☐ Natural					3.05	0.314	.8	8.47	0.584	0.958	≤	3.957	□Yes
	☐ Manmade ☐ Natural											≤		□Yes
	☐ Manmade ☐ Natural											≤		□Yes
	☐ Manmade ☐ Natural											≤		☐ Yes

	IIIRS UI A	<i>iiaiysis.</i> Requ	nea <u>roi Or i i</u>	JN A above c	<u>riiiy</u>							
an	alyze the	receiving char	nnel at critical a	nalysis points	TO a point wh	ere: ( <i>Provide ca</i>	alculation	s for each anal	ysis point) <b>Use</b>	A or B		
	A. The s	ite's contributin	ng drainage are	a is less than	or equal to 1%	of the total water	ershed, <u>o</u>	<u>r</u>				
		Discha	rge Point (from a	abeve):				Disc	charge Point (fre	m above):		
	CDA to	Discharge Pt:	acres	1% Total W	latershed Area:	acres	CDA to	Discharge Pt:	acres	1% Total Wat	tershed Area:	ad
	Analysis Point	CDA	V <sub>2</sub>	V <sub>ALLOW</sub>	DEPTH <sub>POST-10</sub>	DEPTHCHNL	Analysis Point	CDA	V <sub>2</sub>	V <sub>ALLOW</sub>	DEPTH <sub>POST-10</sub>	DEPTH

B. The s	ite's peak flow	rate of the 1-ye	ar storm is les	s than or equ	ıal to 1% of the 1	1-yr predev	elopment pea	k flowrate		
		<u>je Point (fro</u> m ab		<u> </u>				Point (from abo		
 s	ite Peak Flow (1-yr storm):	cfs	1% Pre Pe (1-yı	ak Flow storm):	cfs		Site Peak Flow (1-yr storm):	cfs	1% Pre P (1-	eak Flow yr storm):

Discharge Point from Site (Show on Plans)				year	OPTION A  Confine the post developed peak flow rate for the 10- year 24-hour storm within the system. Receiving channel <u>must</u> be analyzed to the <u>Limits of Analysis</u> (below). (QPOST-10 < QSYSTEM CAPACITY)				OPTION B  Release a post developed peak flow rate for the year 24-hour storm that is less than the pre deve peak flow rate for the 10-year 24-hour storm. To option does NOT require further analysis of recein channel. (QPOST-10 < QPRE-10)			
,		Qsy	QSYSTEM CAPACITY		QPOST-10		QPRE-10		QPOST-10			
МН9	<ul><li>☑ No Localized Flooding (Option A)</li><li>☑ Existing Localized Flooding (Option A or B)</li></ul>			3)					16.21		7.10	
	<ul><li>■ No Localized F</li><li>■ Existing Localized</li></ul>			3)								
	<ul><li>■ No Localized F</li><li>■ Existing Localized</li></ul>											
	of Analysis: Requir	red <b>For OPTIC</b>	ON A above on	nly (Q <sub>post</sub> > Q		noloulati-	no for each are	dunia point) I	loo A. P. or C.			
-analy	of Analysis: Require the receiving characteristic contributing Discharacteristics	red For OPTIC nnel at critical g drainage are ge Point (from a	ON A above on analysis points a is less than o above):	nly (Q <sub>post</sub> > Q s TO a point w	of the total water	ershed, <u>or</u>	<u>r</u> Discha	rge Point (fron	1 above):			
-analy	of Analysis: Require ze the receiving character is contributing Discharge Pt.	red For OPTIC nnel at critical g drainage are ge Point (from a acres	ON A above on analysis points as is less than of above):	aly (Q <sub>post</sub> > Q TO a point wor equal to 1% atershed Area:	of the total water	ershed, <u>or</u>	Discha	rge Point (fron	1 above):	atershed Area:		
-analy	of Analysis: Require the receiving characteristic contributing Discharacteristics	red For OPTIC nnel at critical g drainage are ge Point (from a	ON A above on analysis points a is less than o above):	nly (Q <sub>post</sub> > Q s TO a point w	of the total water	ershed, <u>or</u>	<u>r</u> Discha	rge Point (fron	1 above):	atershed Area: DEPTH <sub>10</sub> YR	Į. DEPTH	
-analy	of Analysis: Require ze the receiving characteristics contributing Discharge Pt: DA to Discharge Pt: CDA	red For OPTIC nnel at critical g drainage are ge Point (from a acres	ON A above on analysis points as is less than of above):	aly (Q <sub>post</sub> > Q TO a point wor equal to 1% atershed Area:	of the total water	crshed, or	Discha	rge Point (fron	1 above):			
-analy	of Analysis: Require ze the receiving characteristics contributing Discharge Pt: DA to Discharge Pt: CDA	red For OPTIC nnel at critical g drainage are ge Point (from a acres V <sub>2YR</sub>	ON A above on analysis points a is less than of above):  1% Total Wa Vallow	or equal to 1% atershed Area: DEPTH10YR	of the total water	CDA to Analysis Point	Discha Discharge Pt: CDA	rge Point (fron	1 above): 1% Total Wi	DEPTH <sub>10</sub> YR		

Discharge Point from Site	Sheet flow from the site must not cause erosion, sedimentation, or flooding of down gradient properties. The post development peak flow rate from the two-year hour storm must not cause erosion (V <sub>2</sub> < V <sub>ALLOW</sub> ). Depth of flow must be less than 1 inch. If runoff is sheet flow and meets these conditions, no further water question controls are required.  (Channel protection & flood protection requirements are not necessary)									
(Show on Plans)	CDA	QPRE-10	QPOST-10	Depth <sub>POST-10</sub>	V <sub>2-POST</sub>	V <sub>ALLOW</sub> *				
						_				

SUMMAR ATER

C-501 NEWPORT NEWS STORMWAT
MARSHALL COURTS APARTMEN
NEWPORT NEWS, VIRGINIA

ssociates


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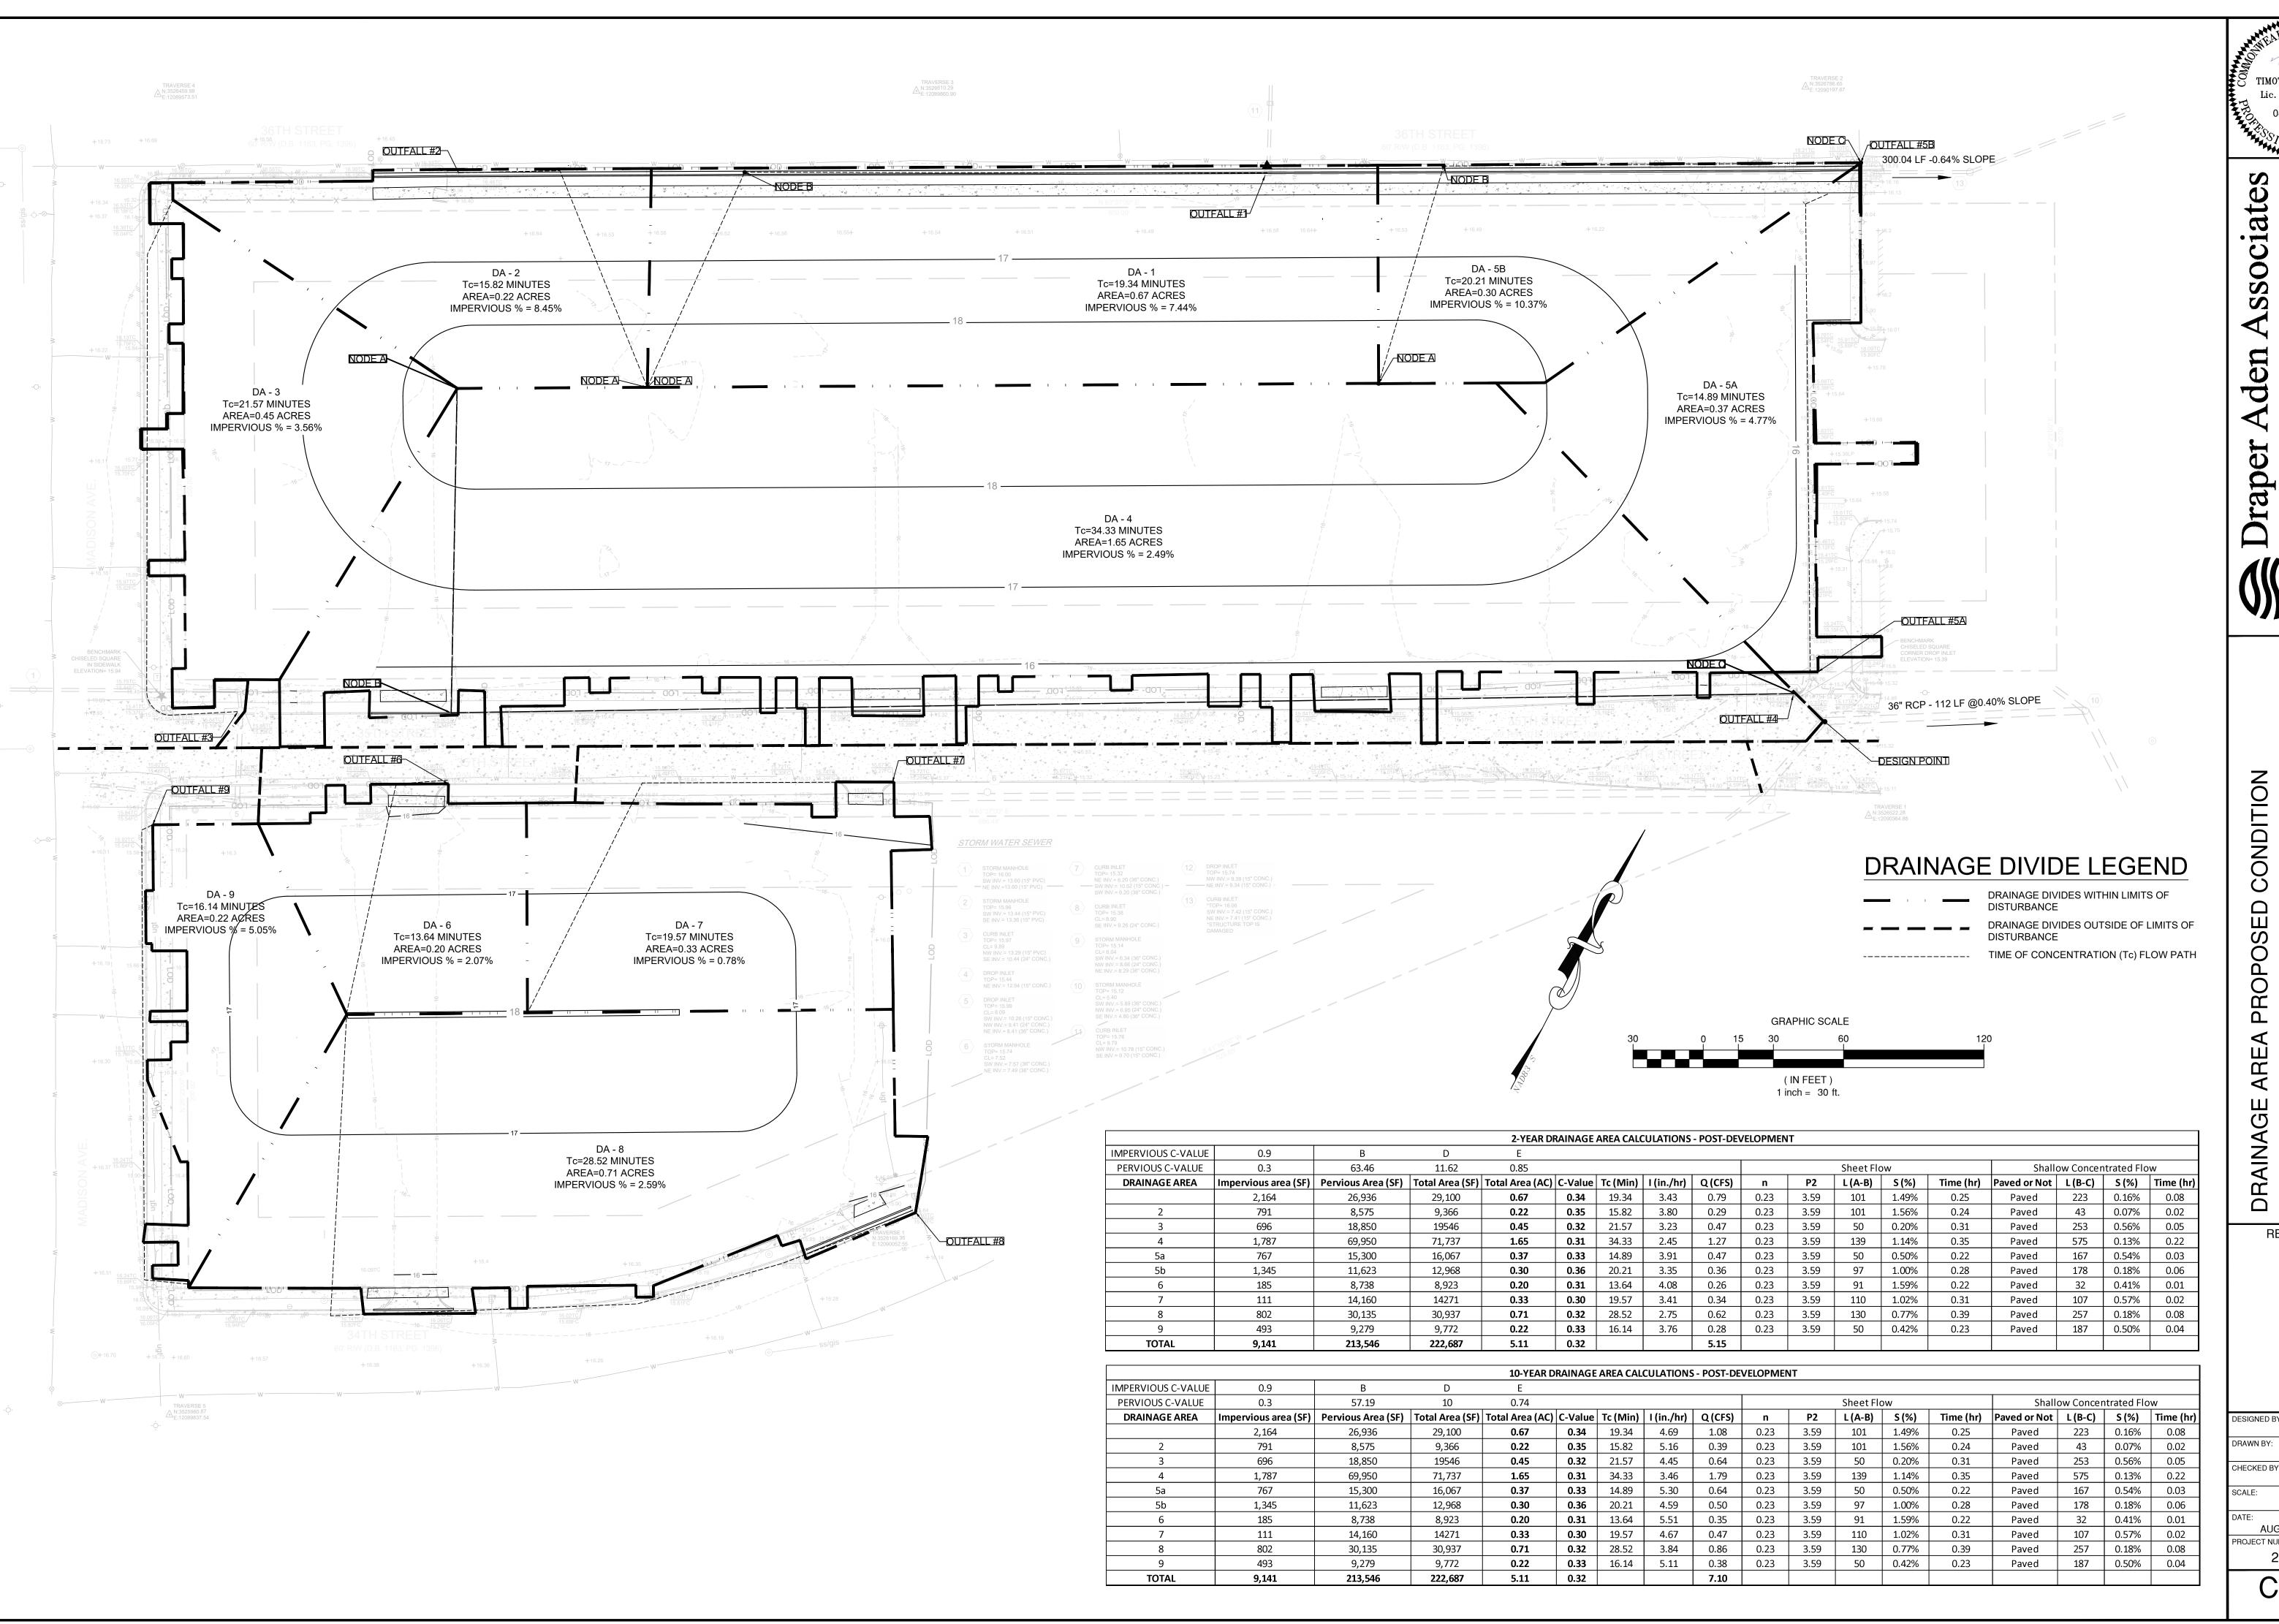
Draper

REVISIONS DESIGNED BY: DRAWN BY:

CHECKED BY: PROJECT NUMBER: 2100194

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**APARTME** COURTS ASE 7 MARSHALL (
NNHRA, PHA
NEWPORT NEWS, V


**REVISIONS** 

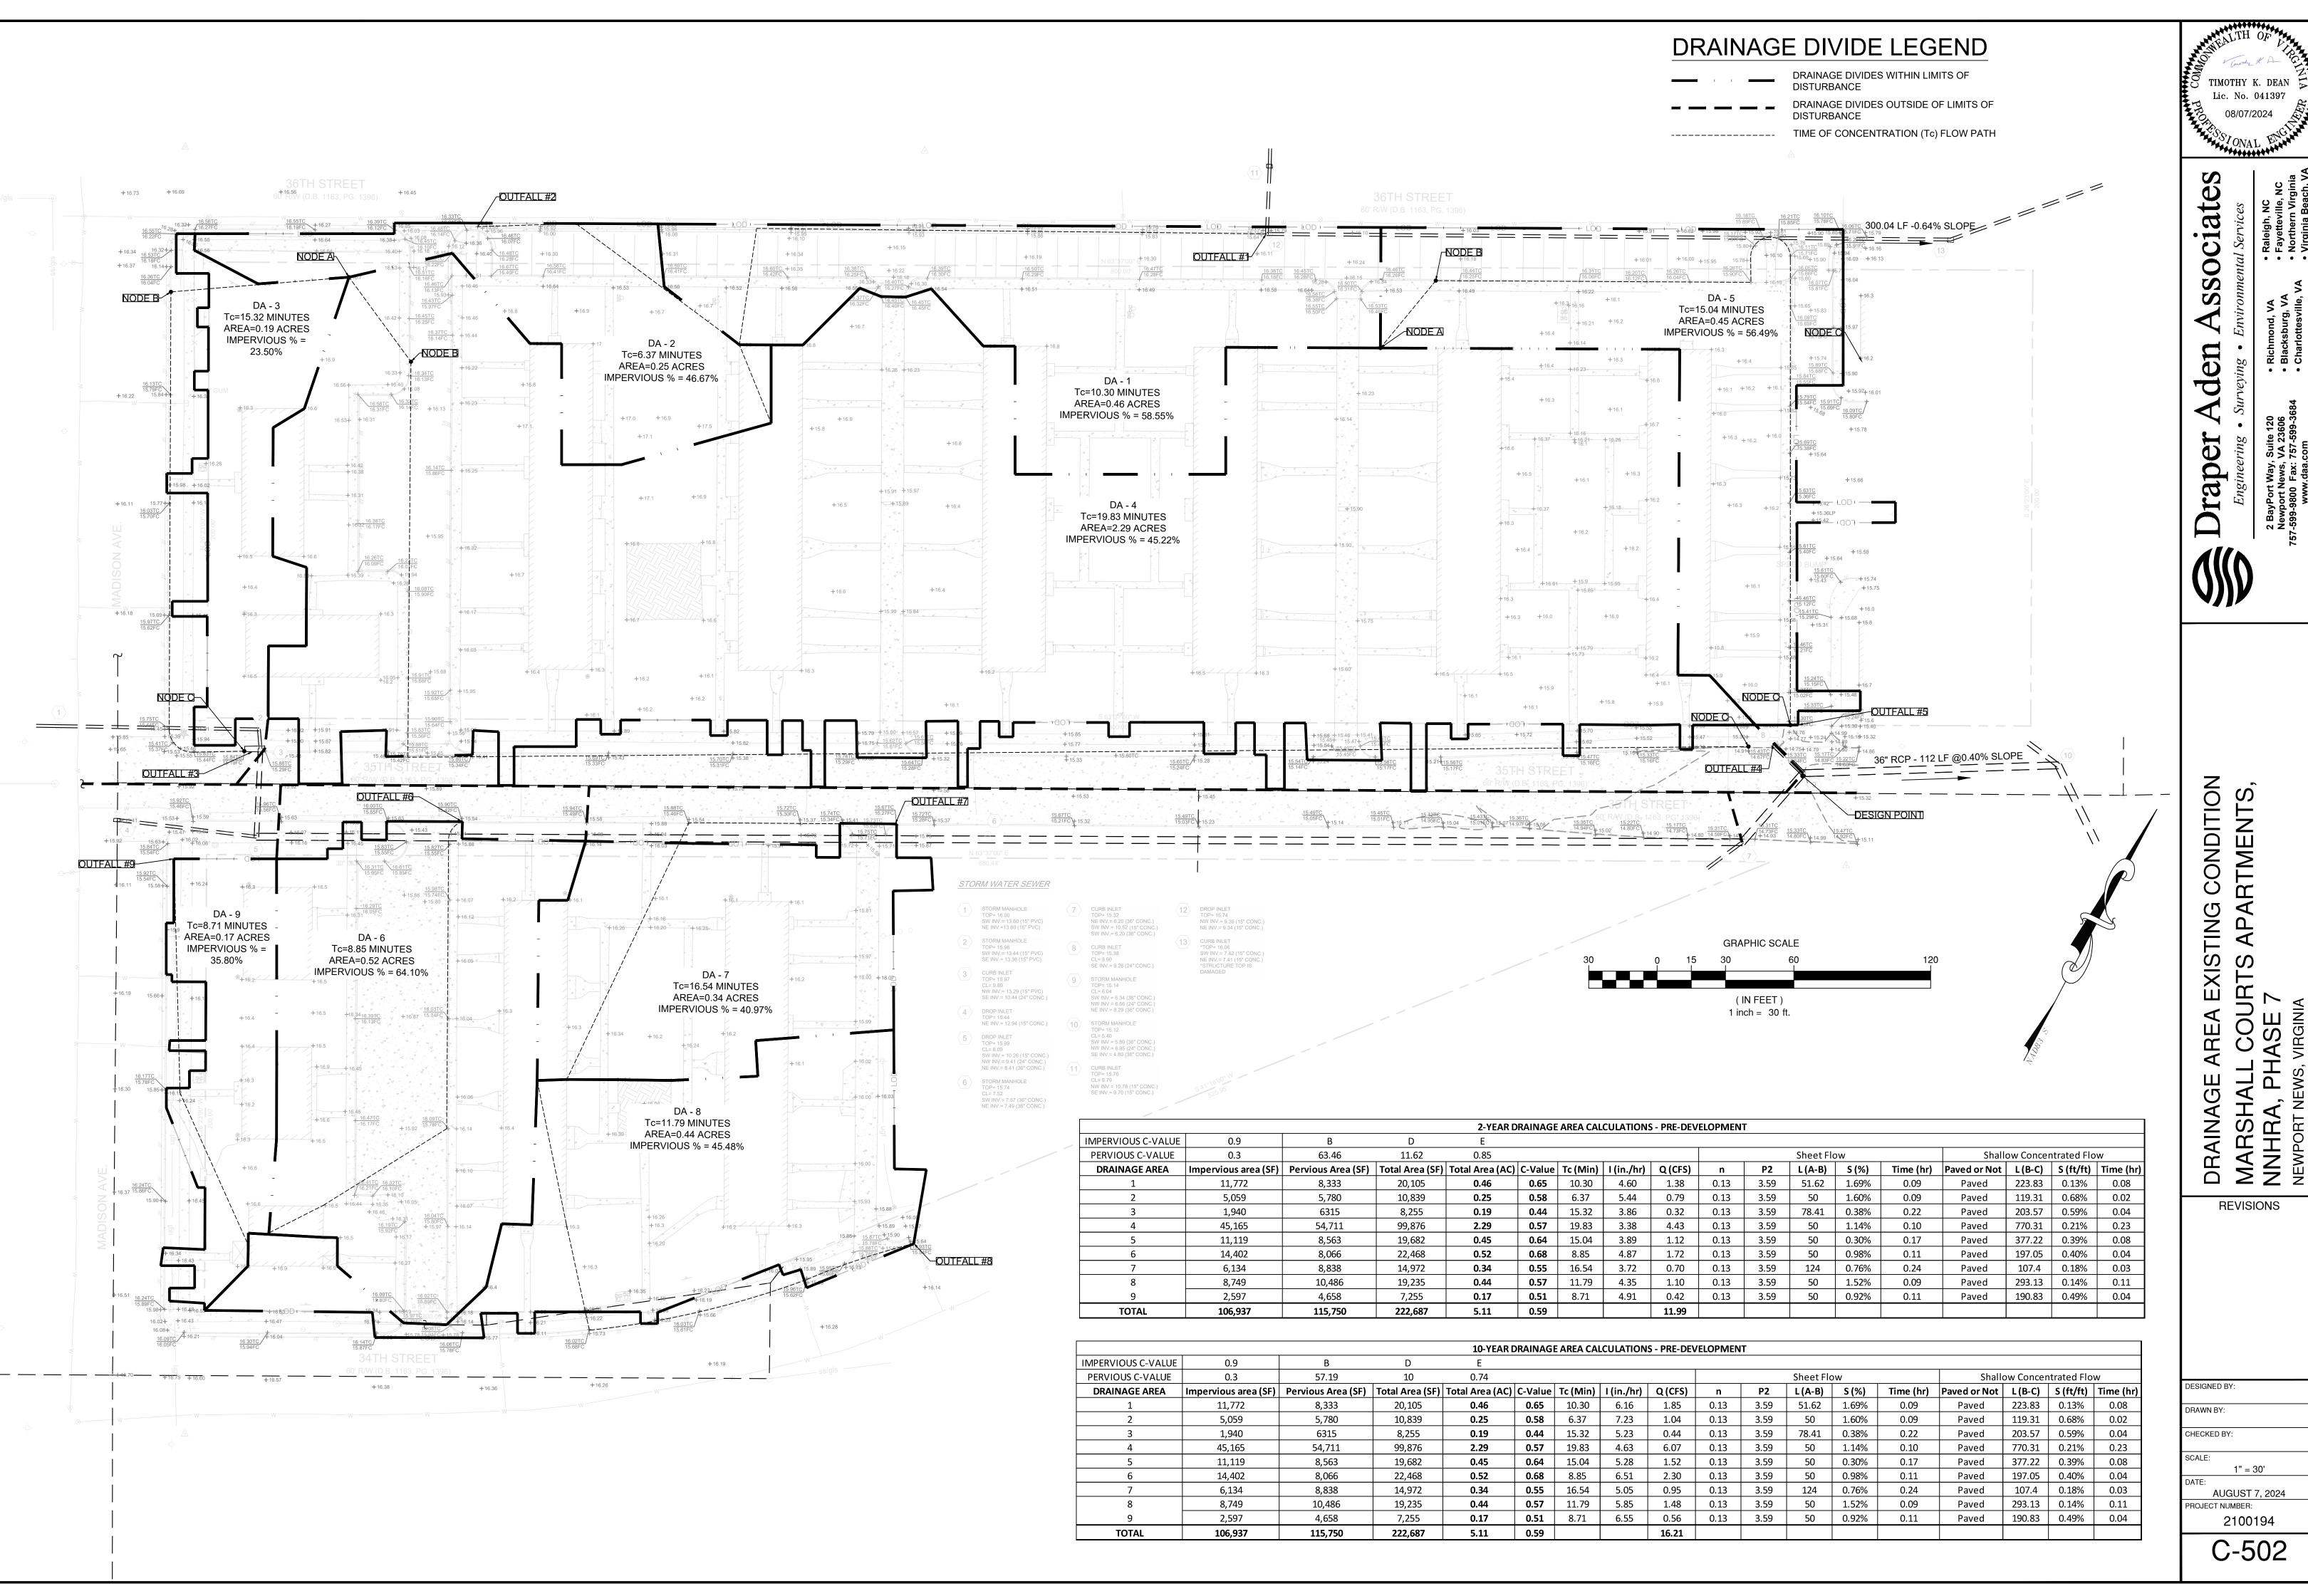
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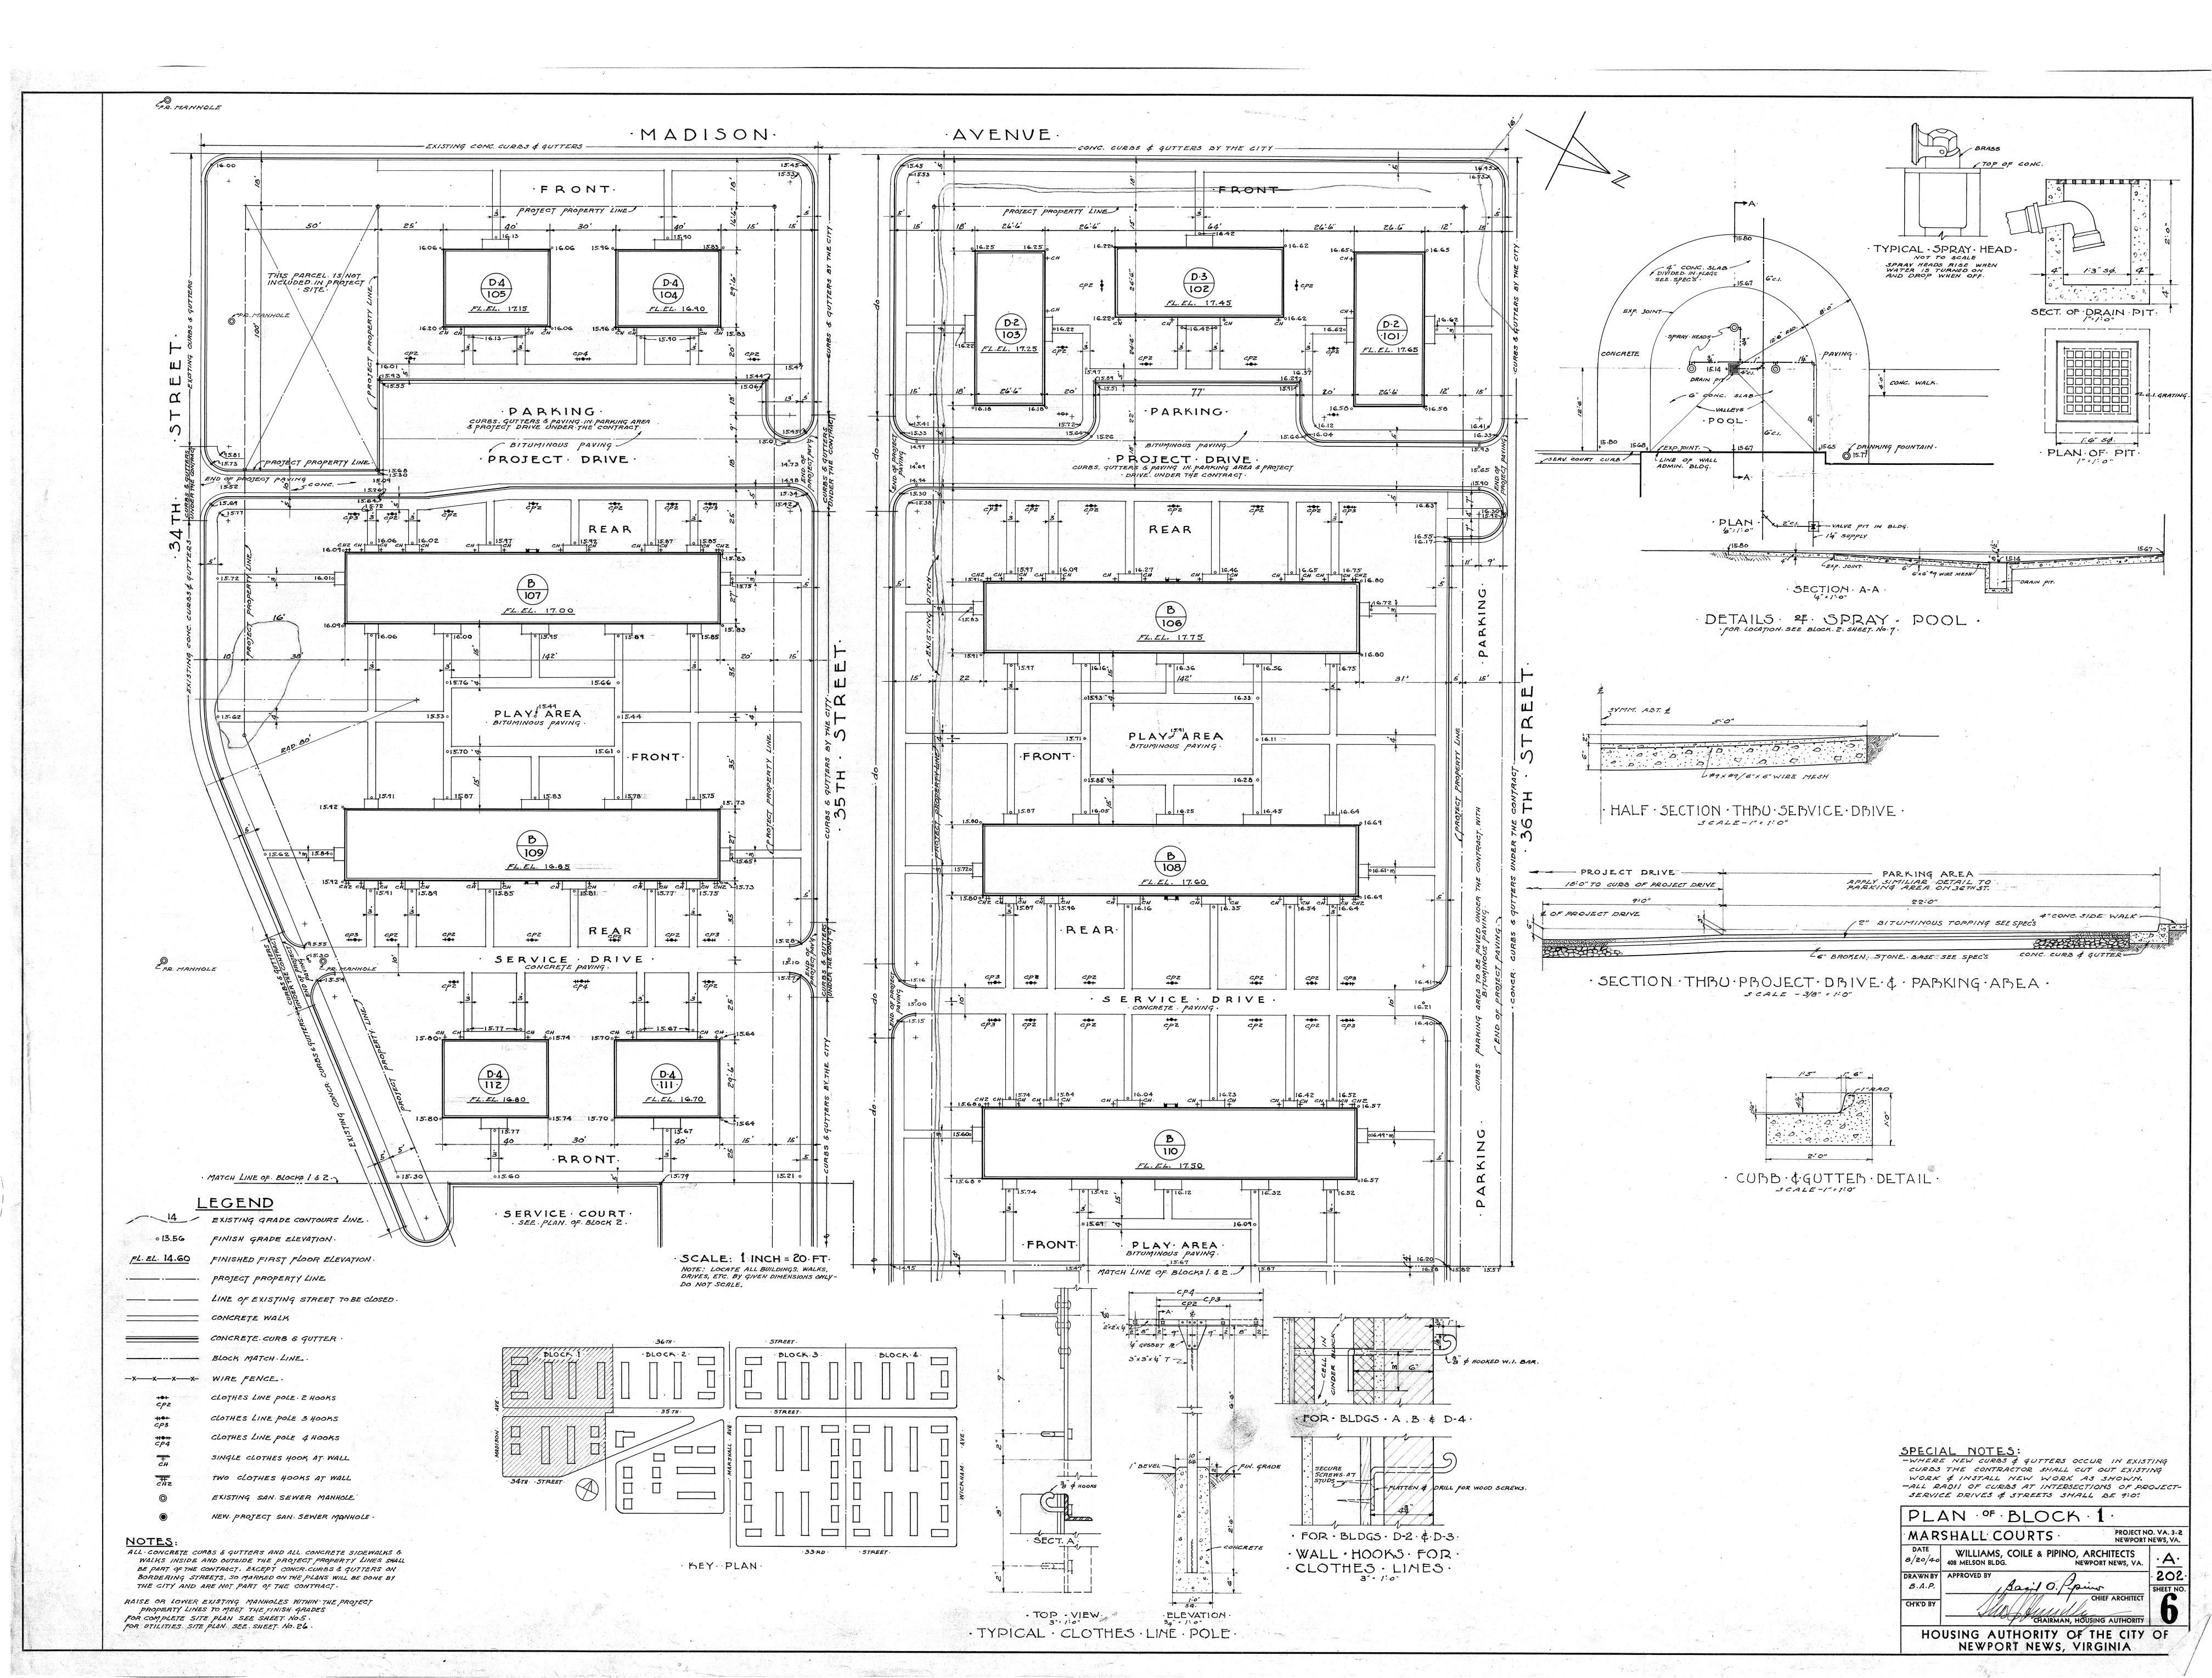
CHECKED BY: 1" = 30'


AUGUST 7, 2024 PROJECT NUMBER: 2100194


C-503




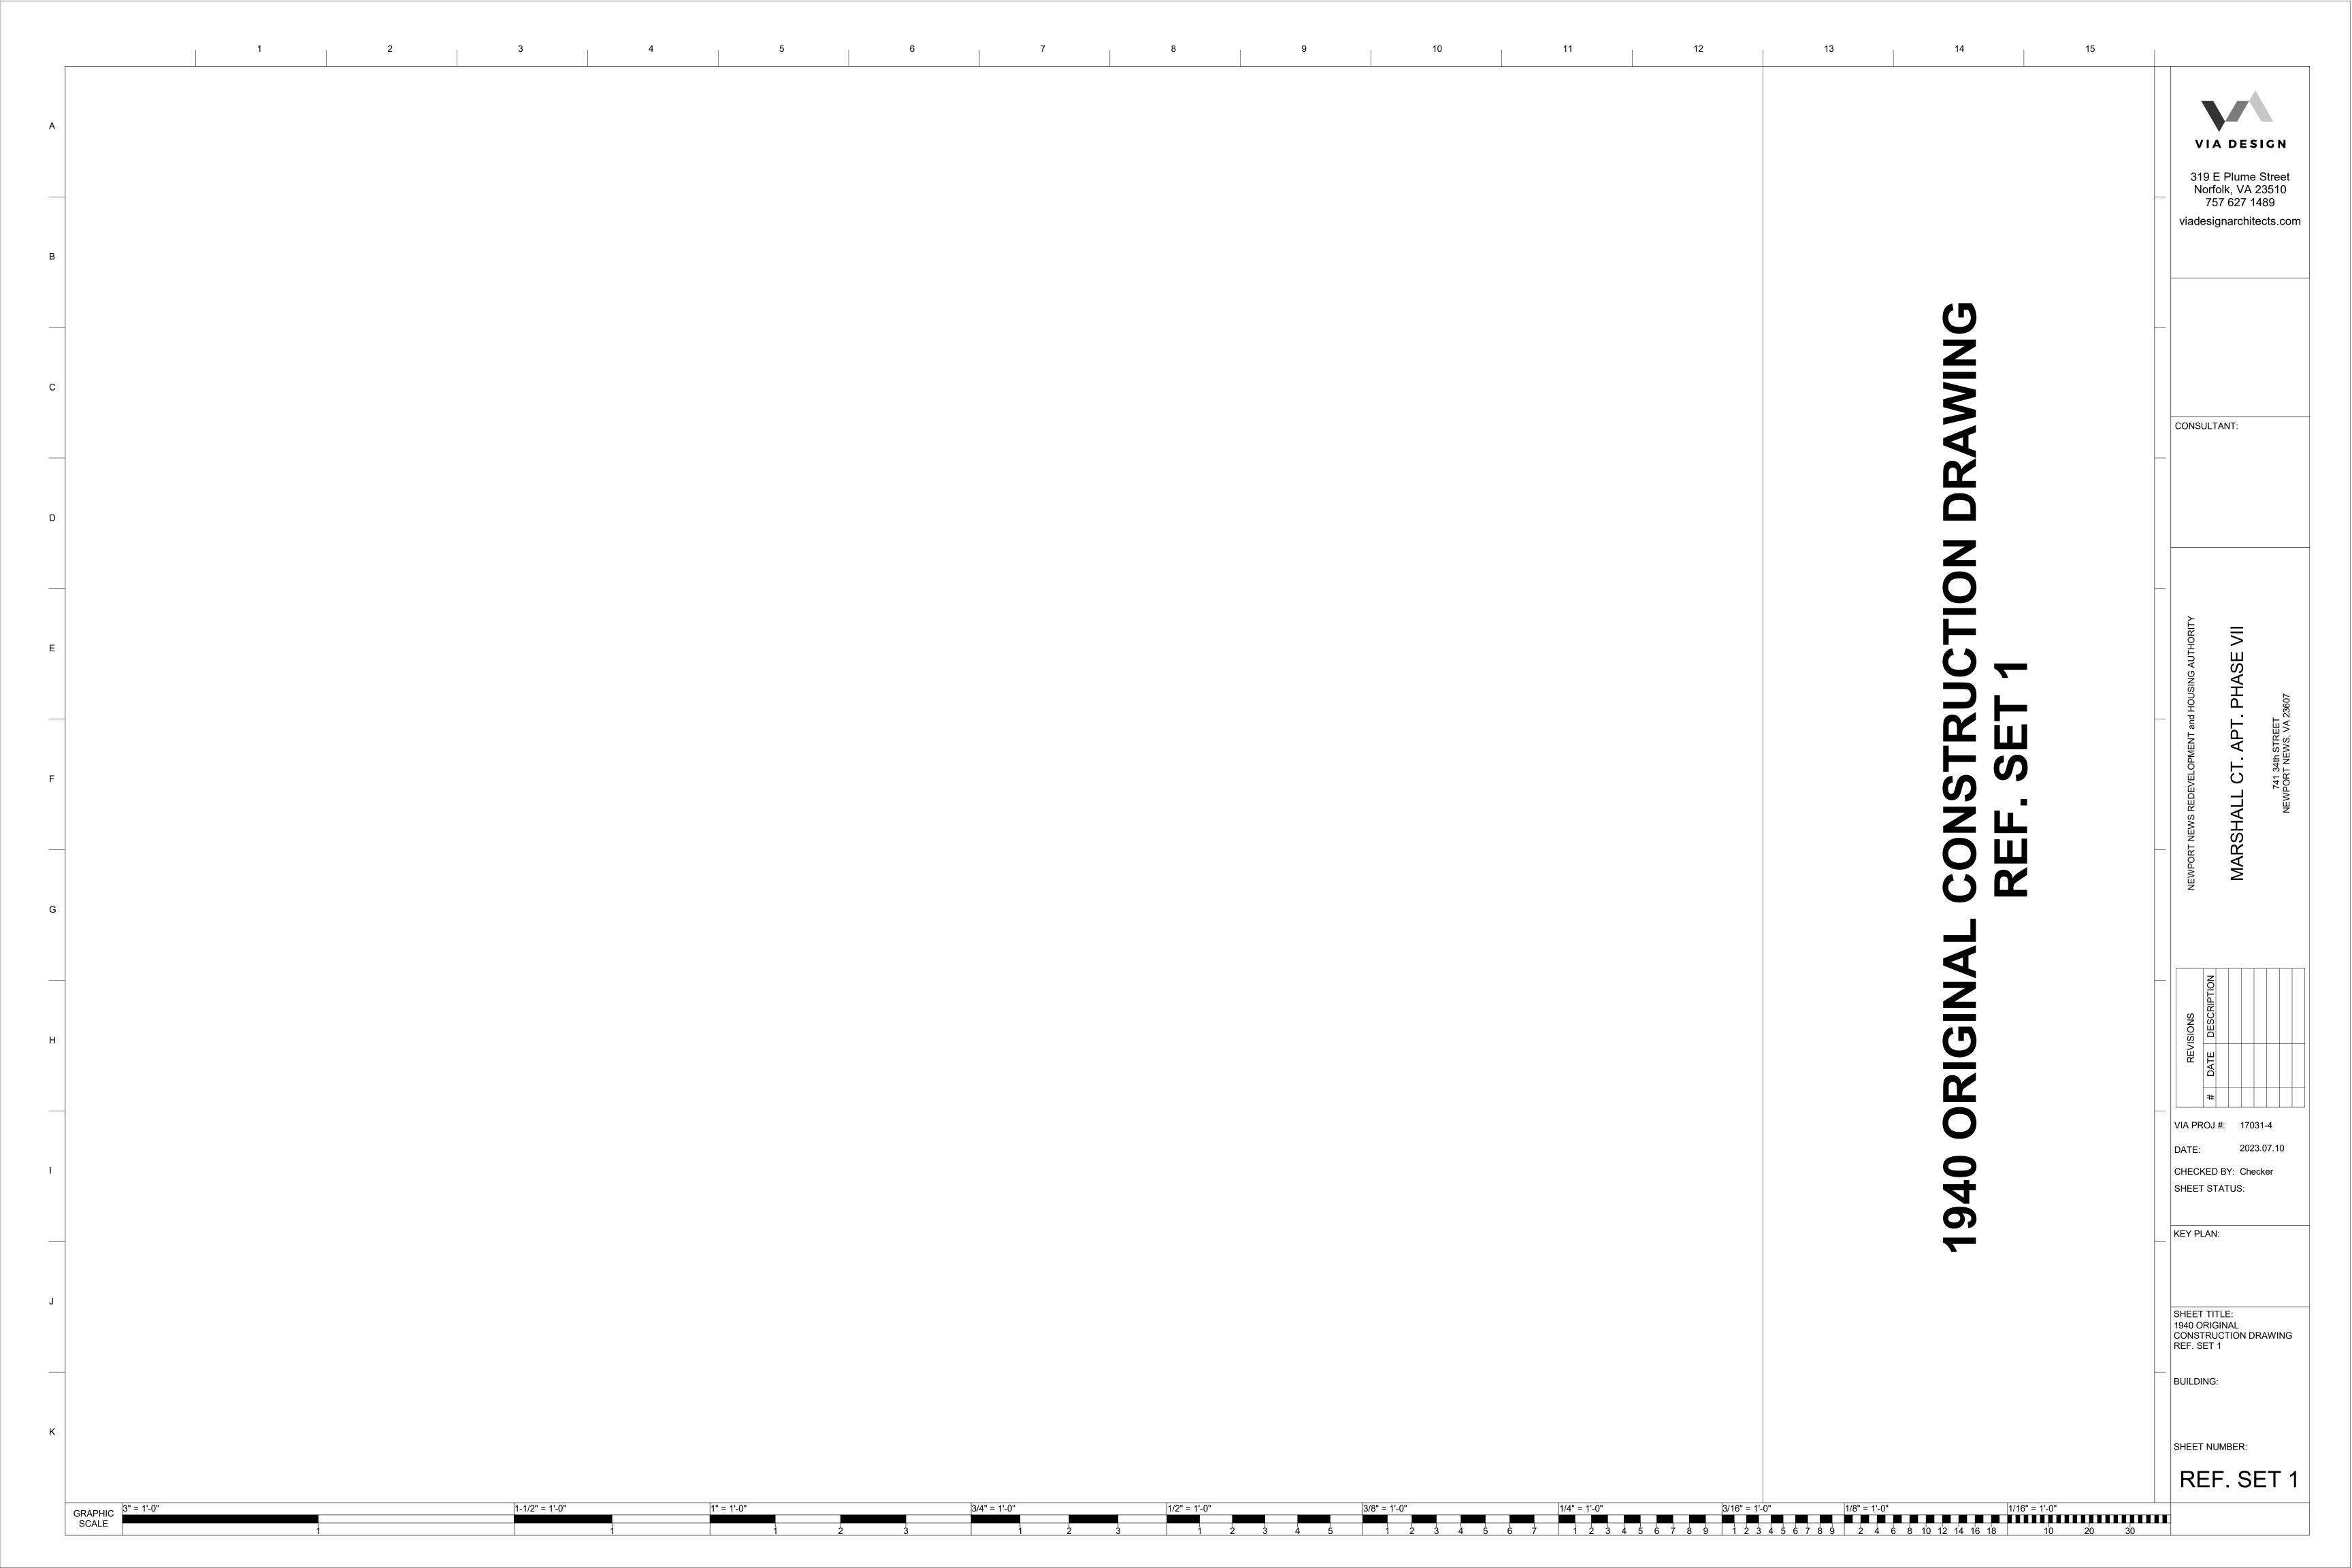


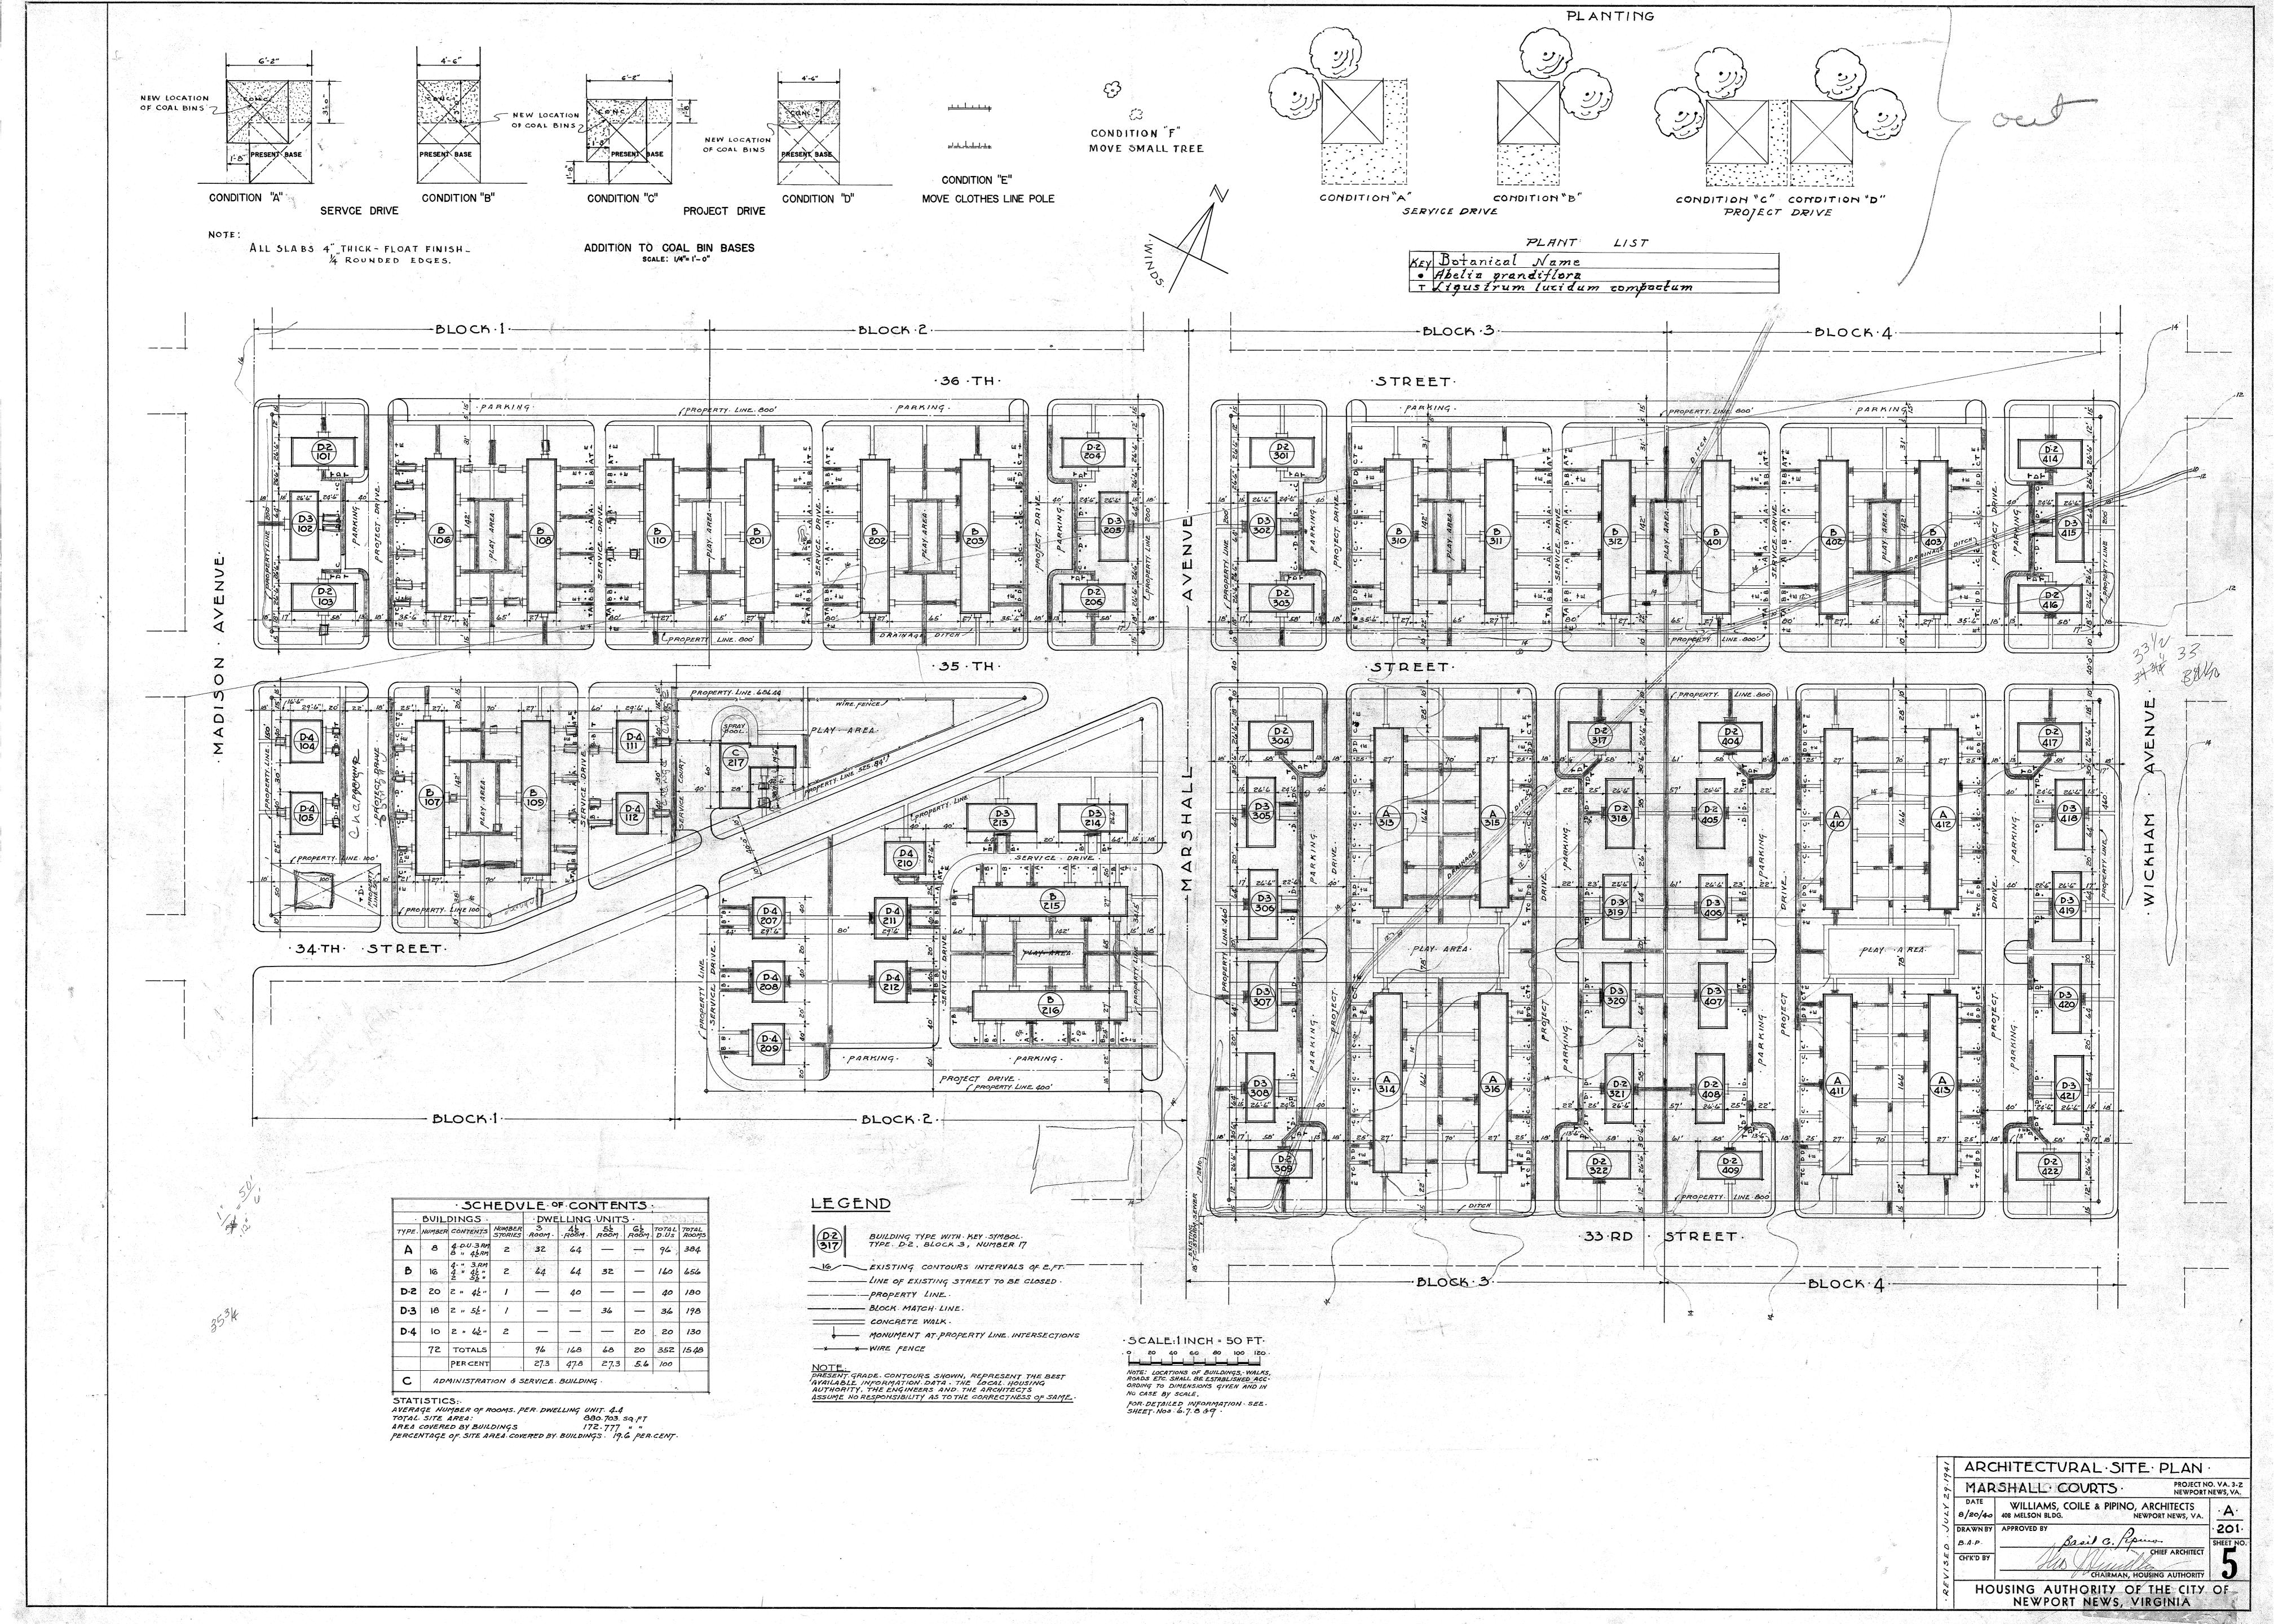

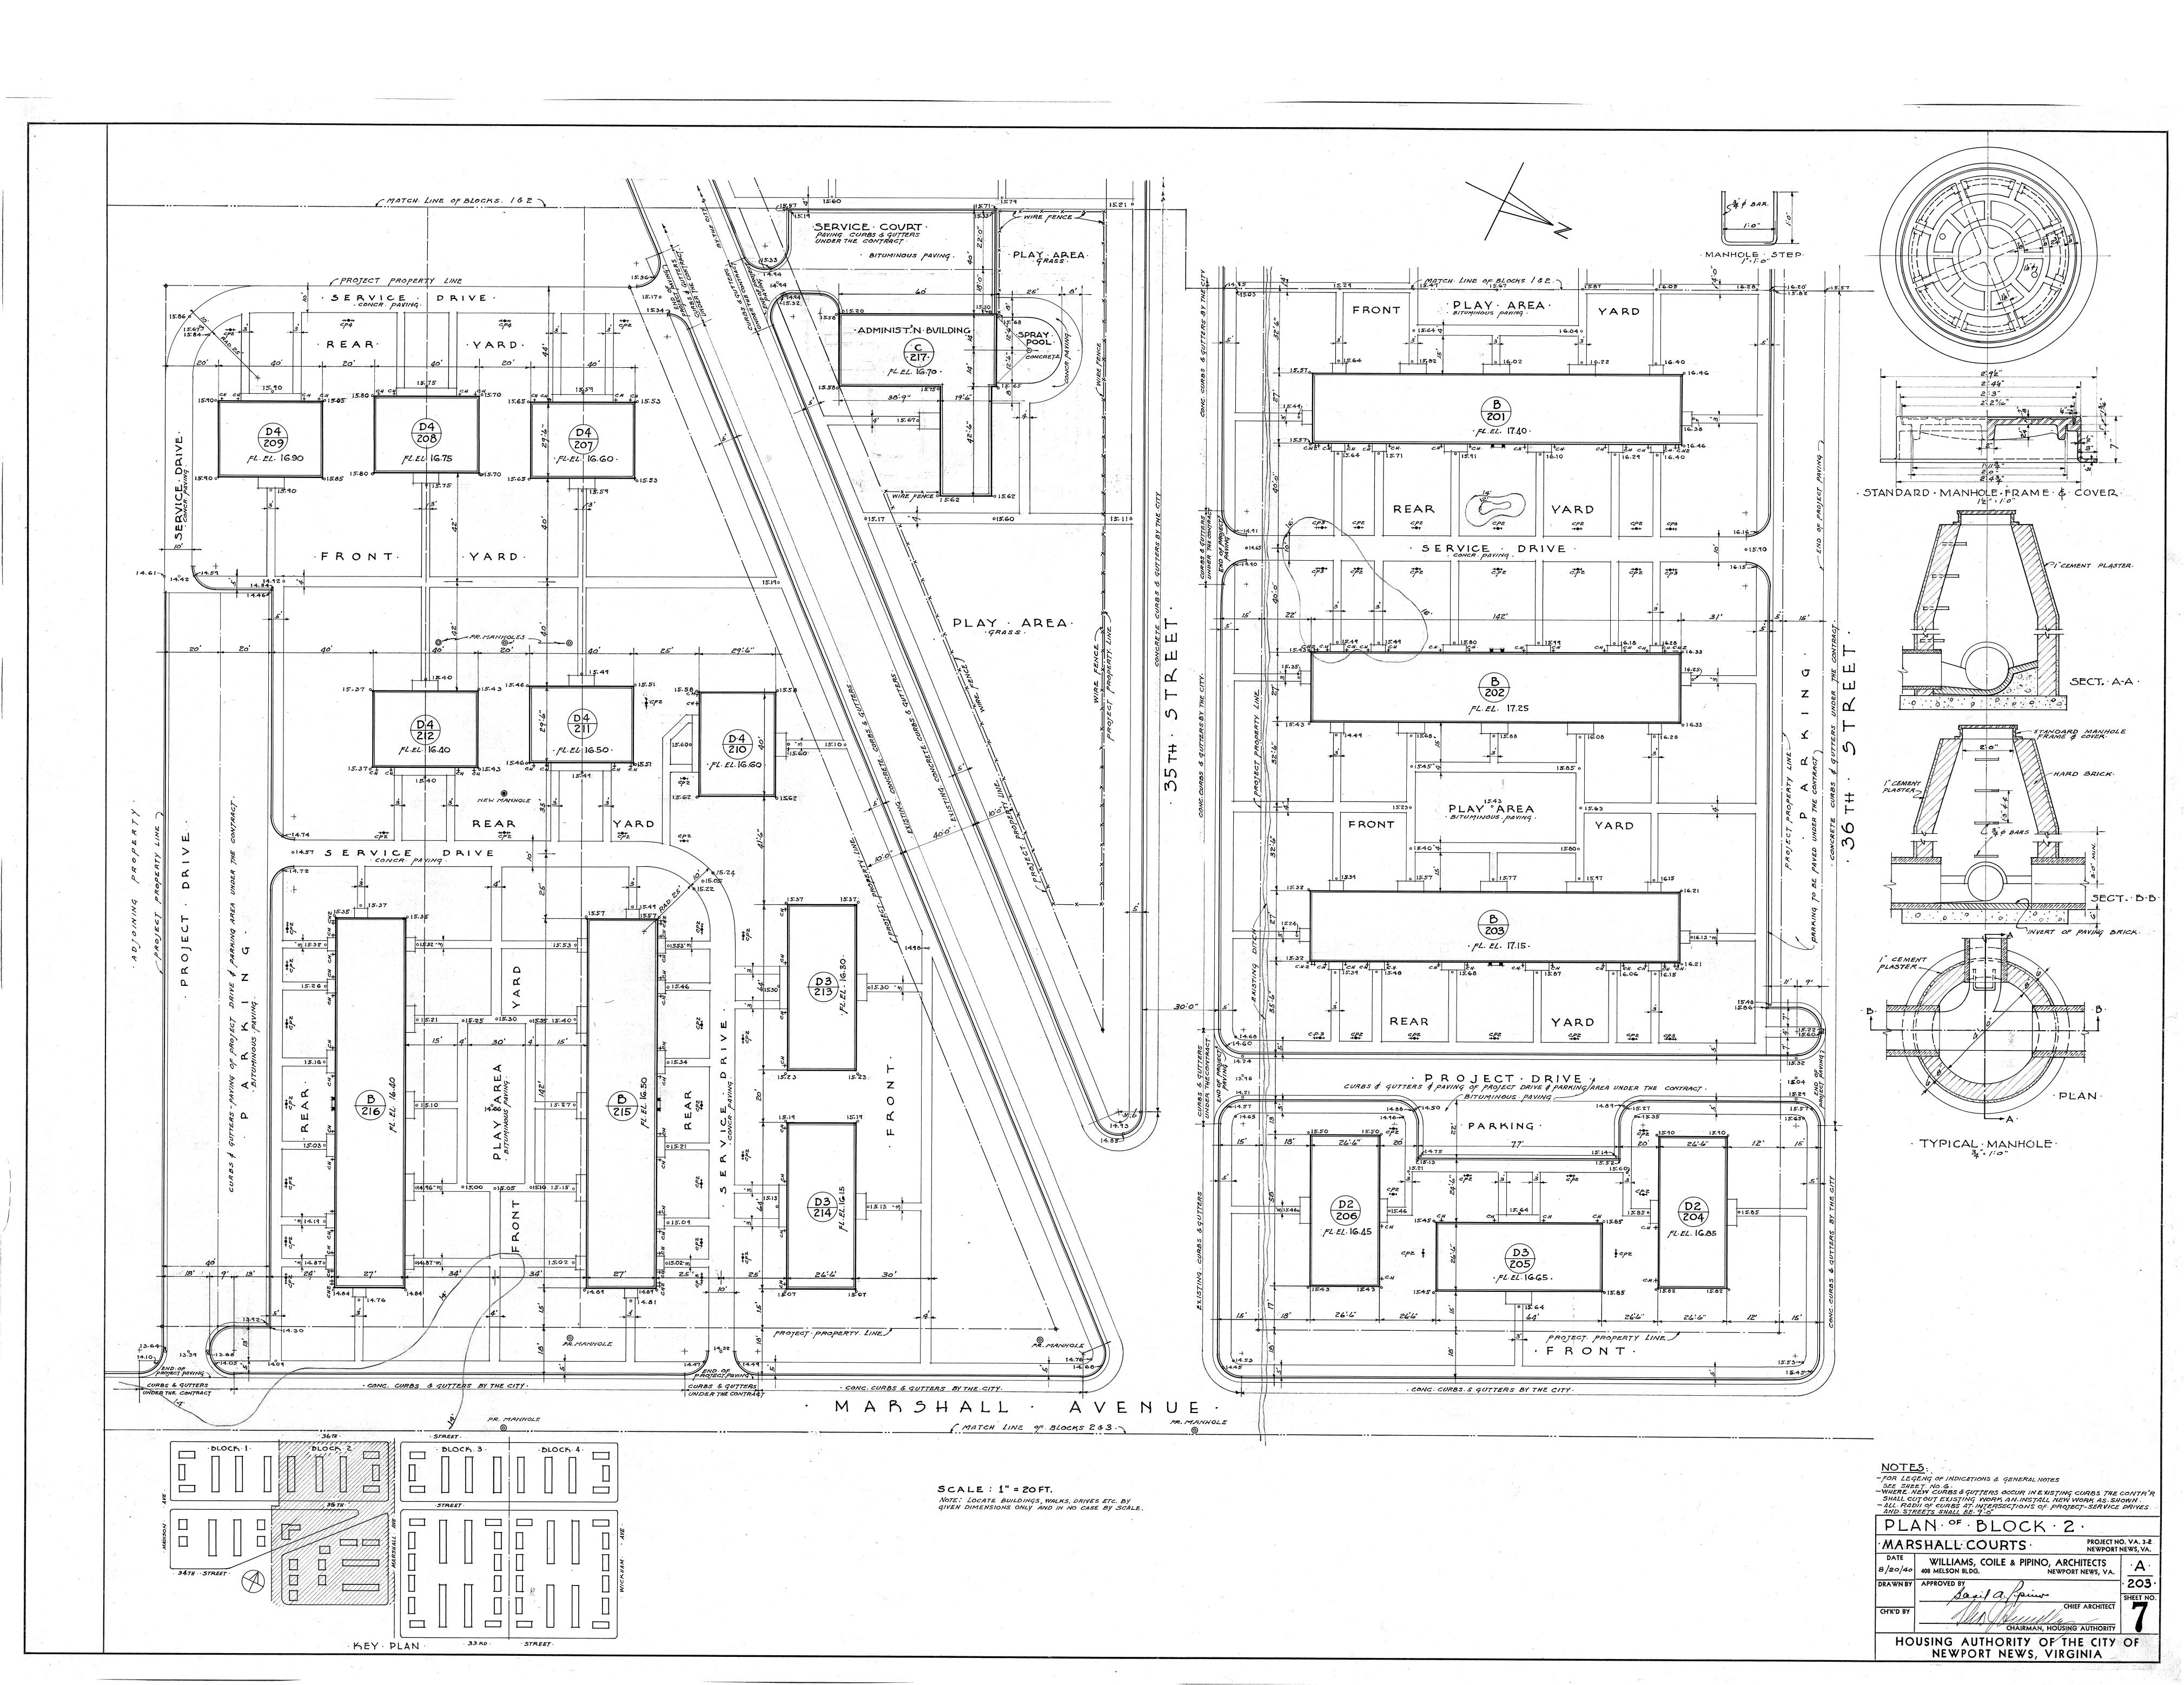


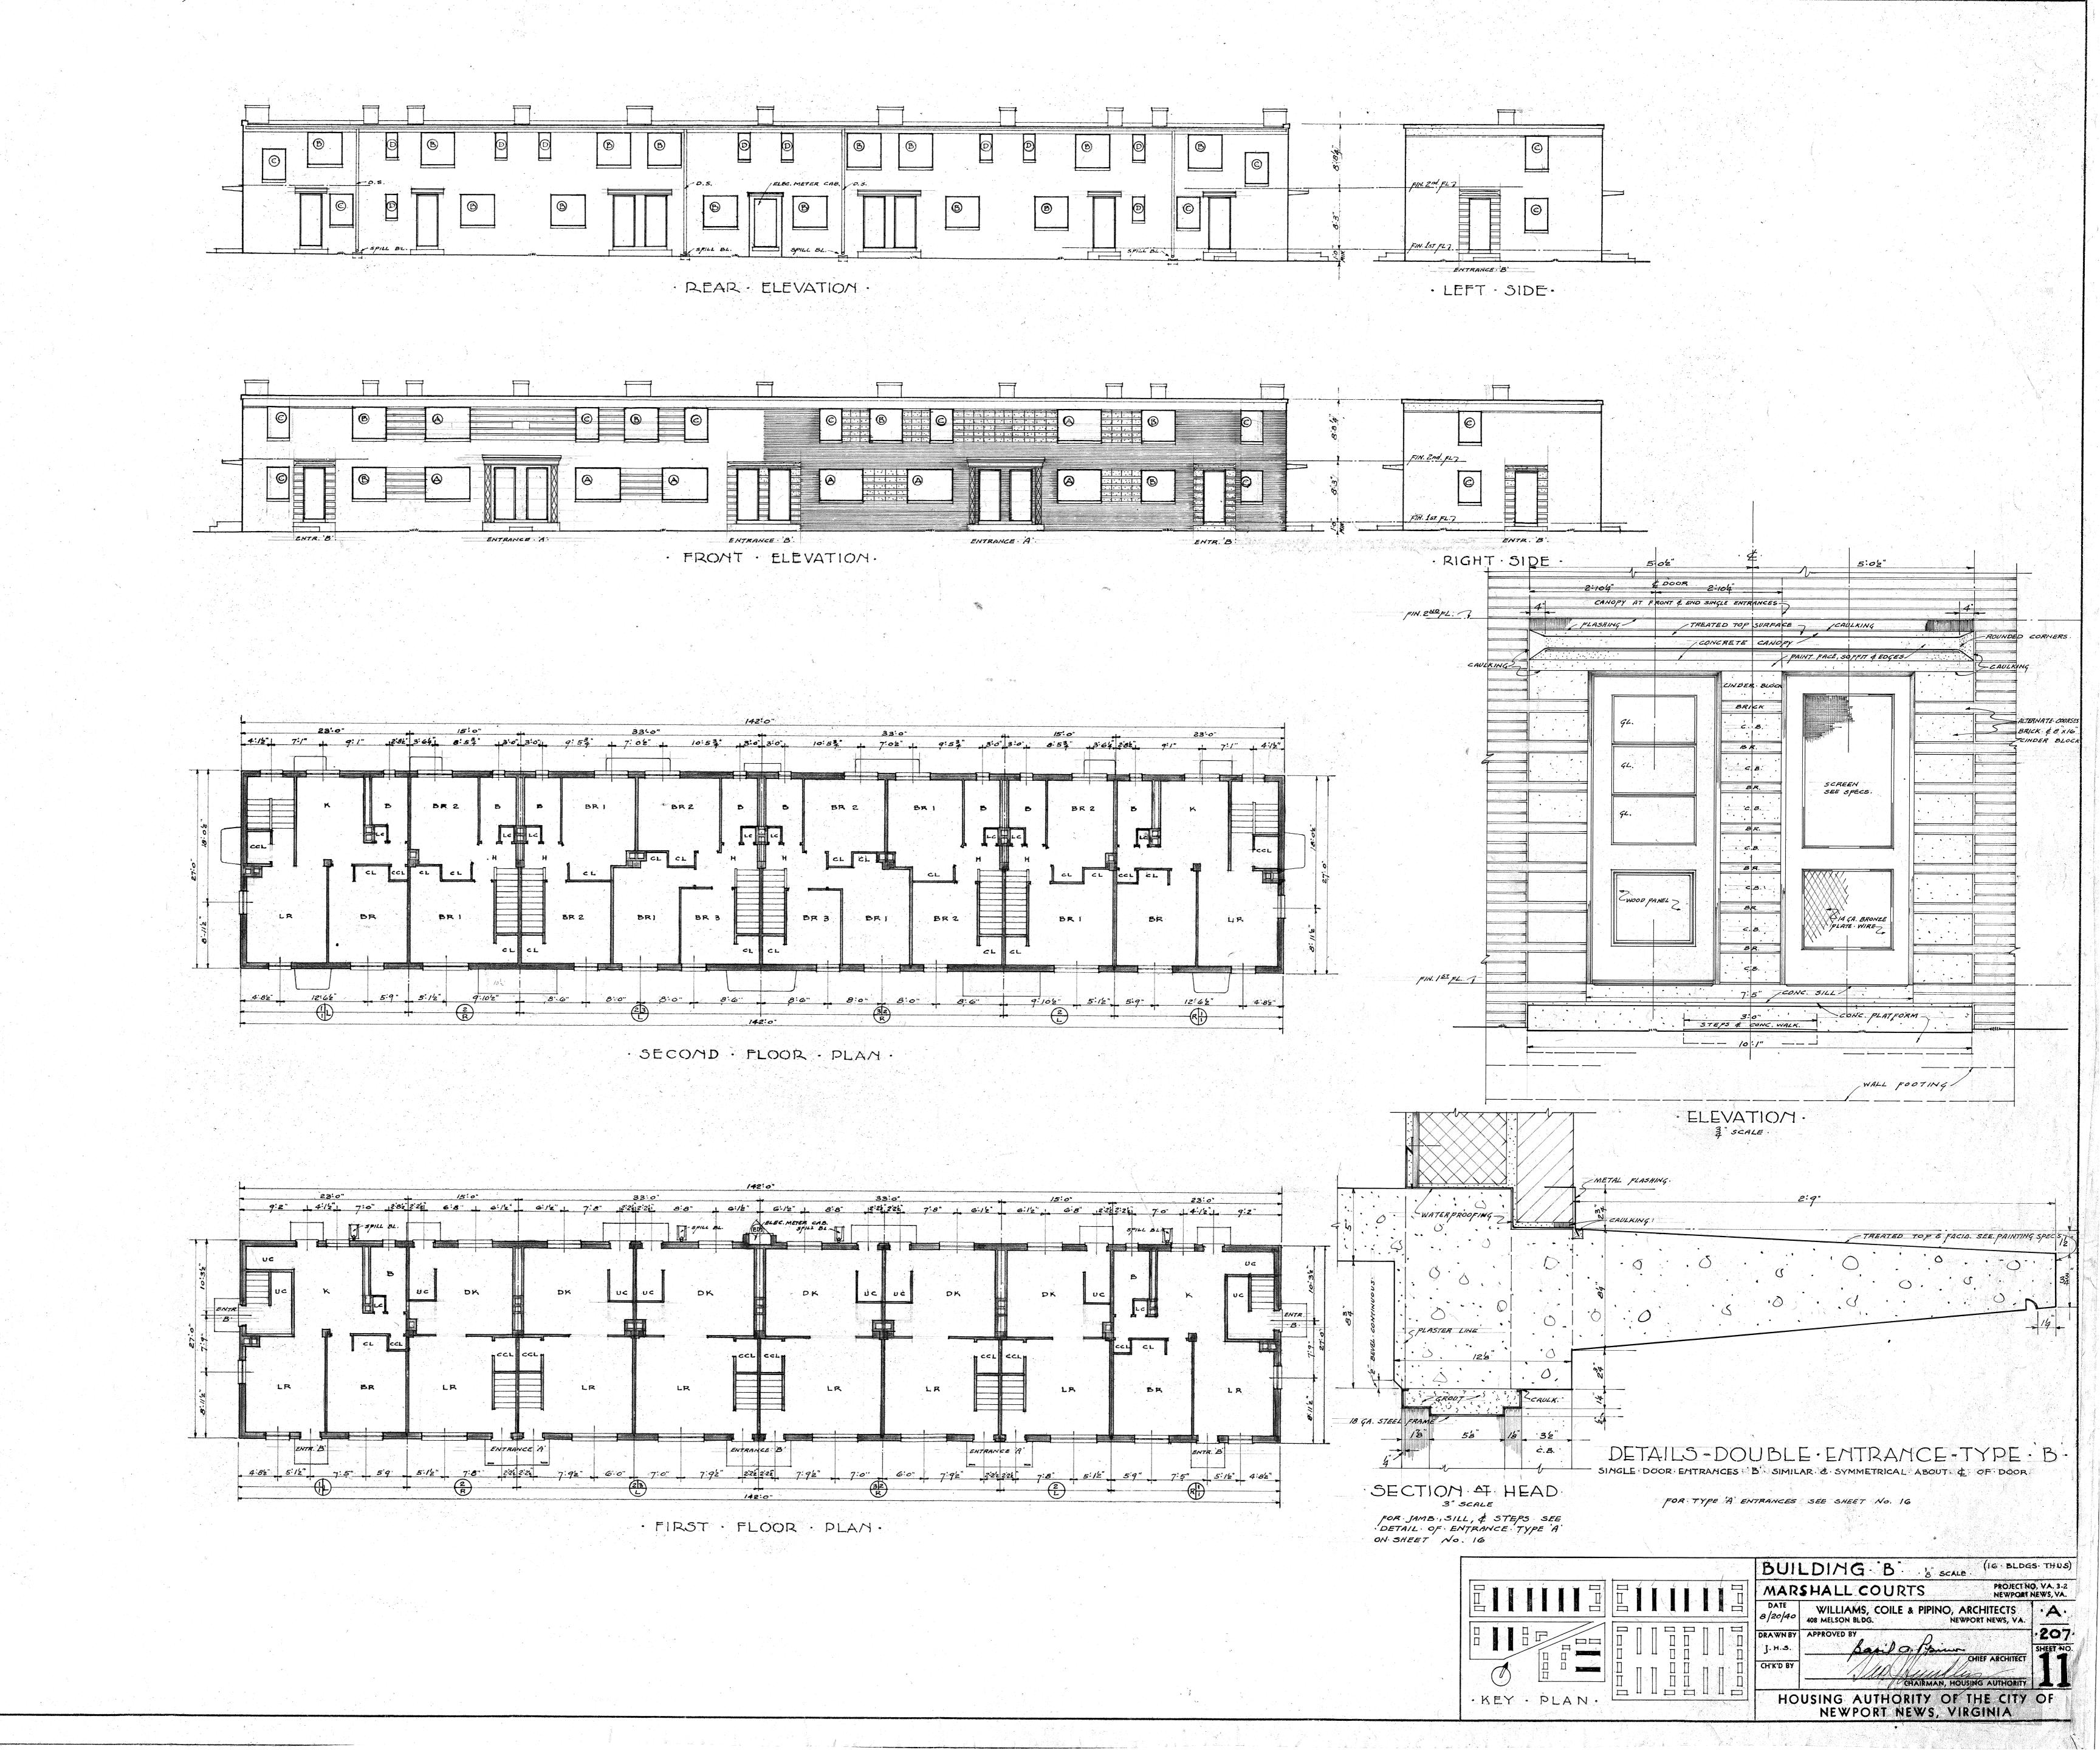


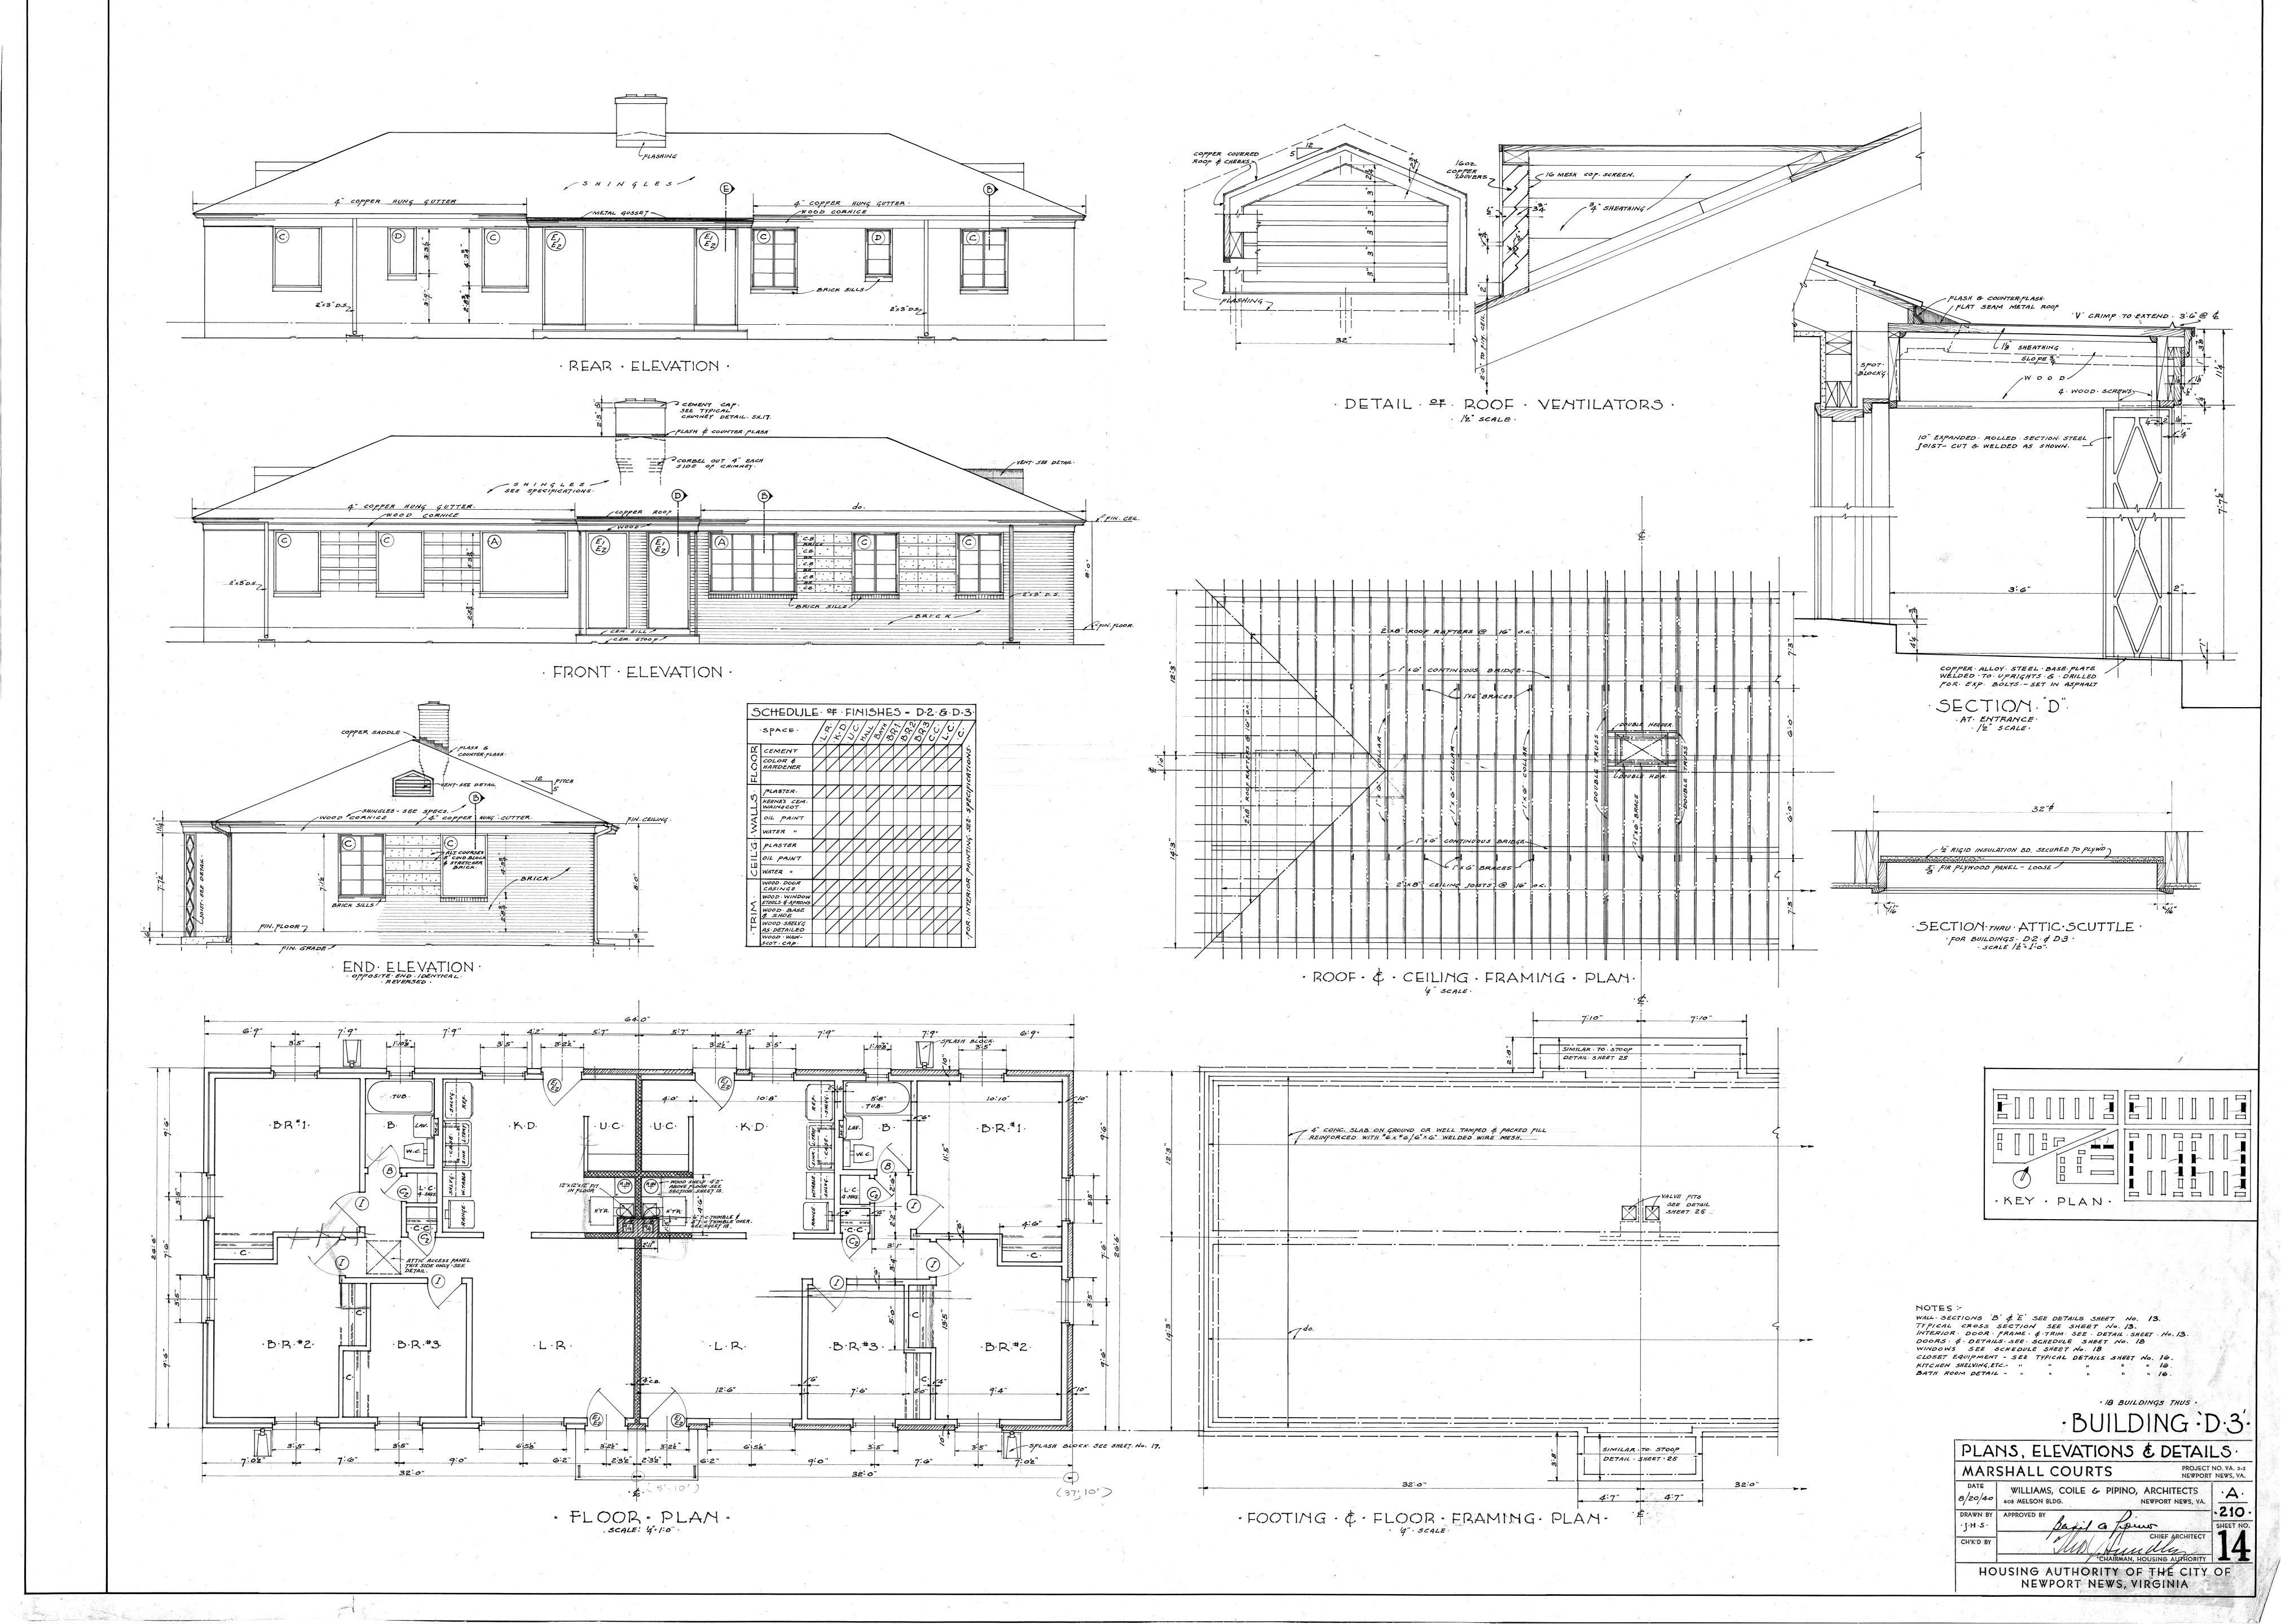


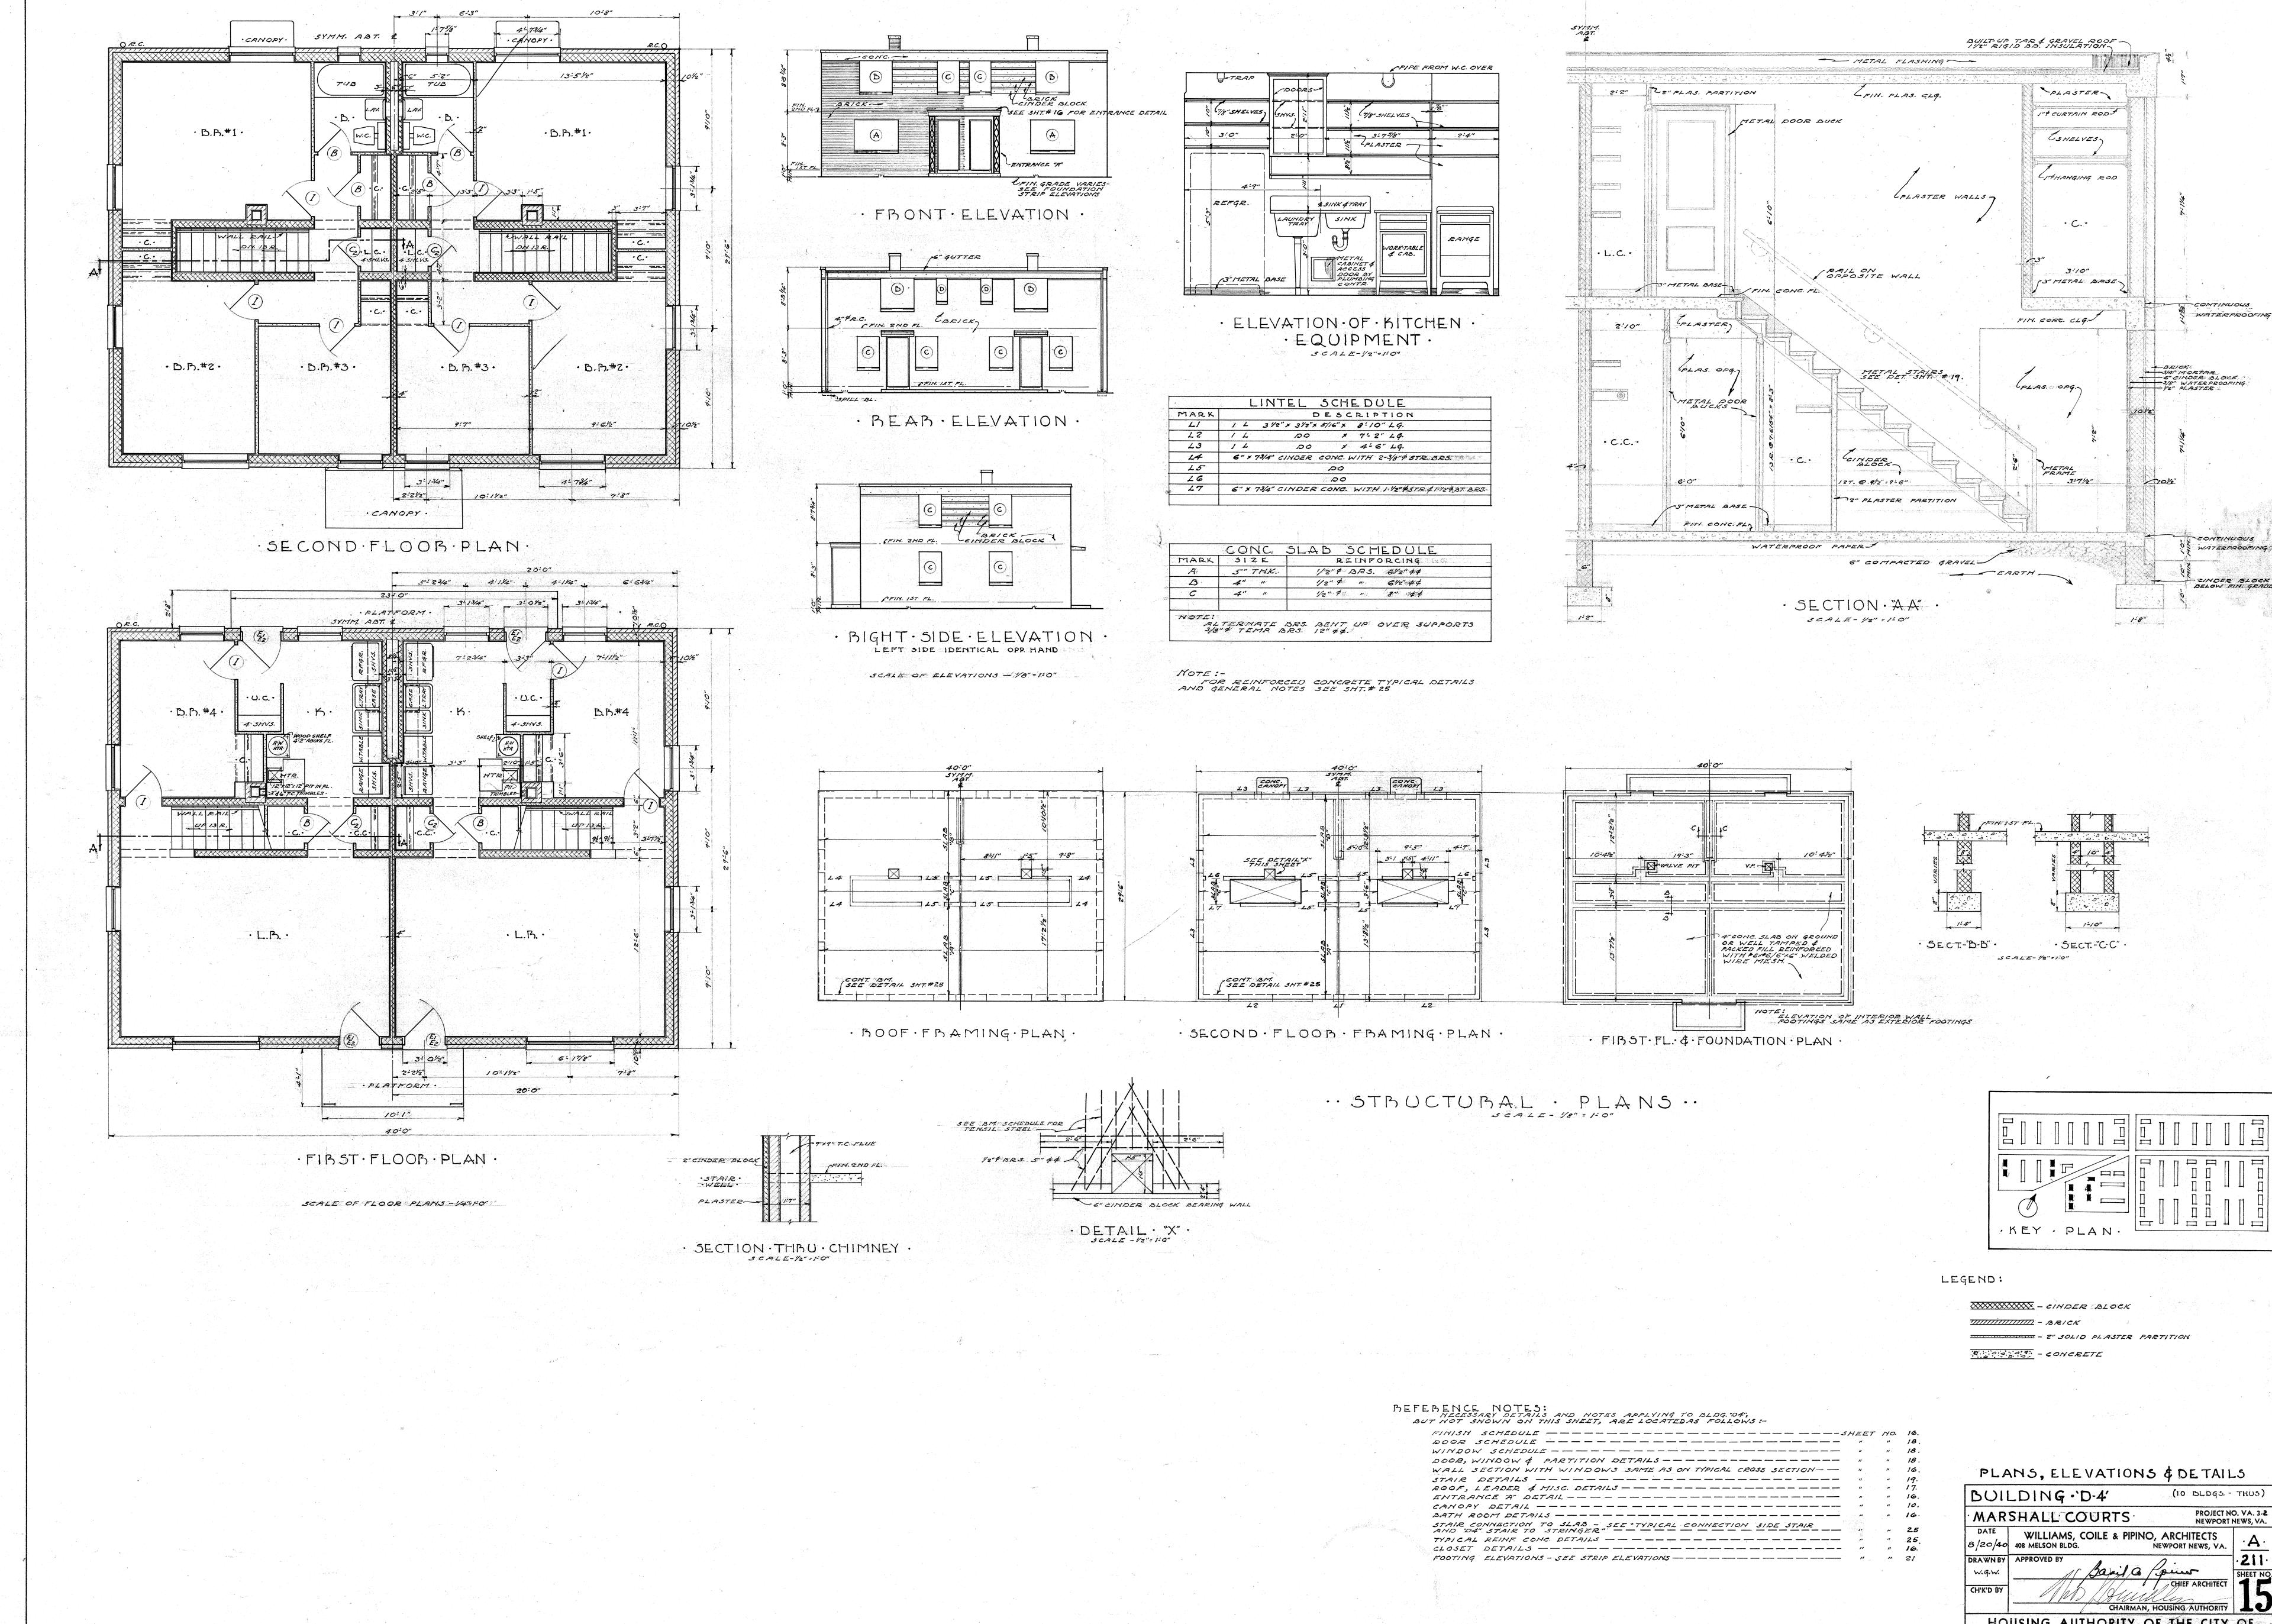



PROJECT NO. VA. 3-2. NEWPORT NEWS, VA. HOUSING AUTHORITY OF THE CITY OF NEWPORT NEWS, VIRGINIA

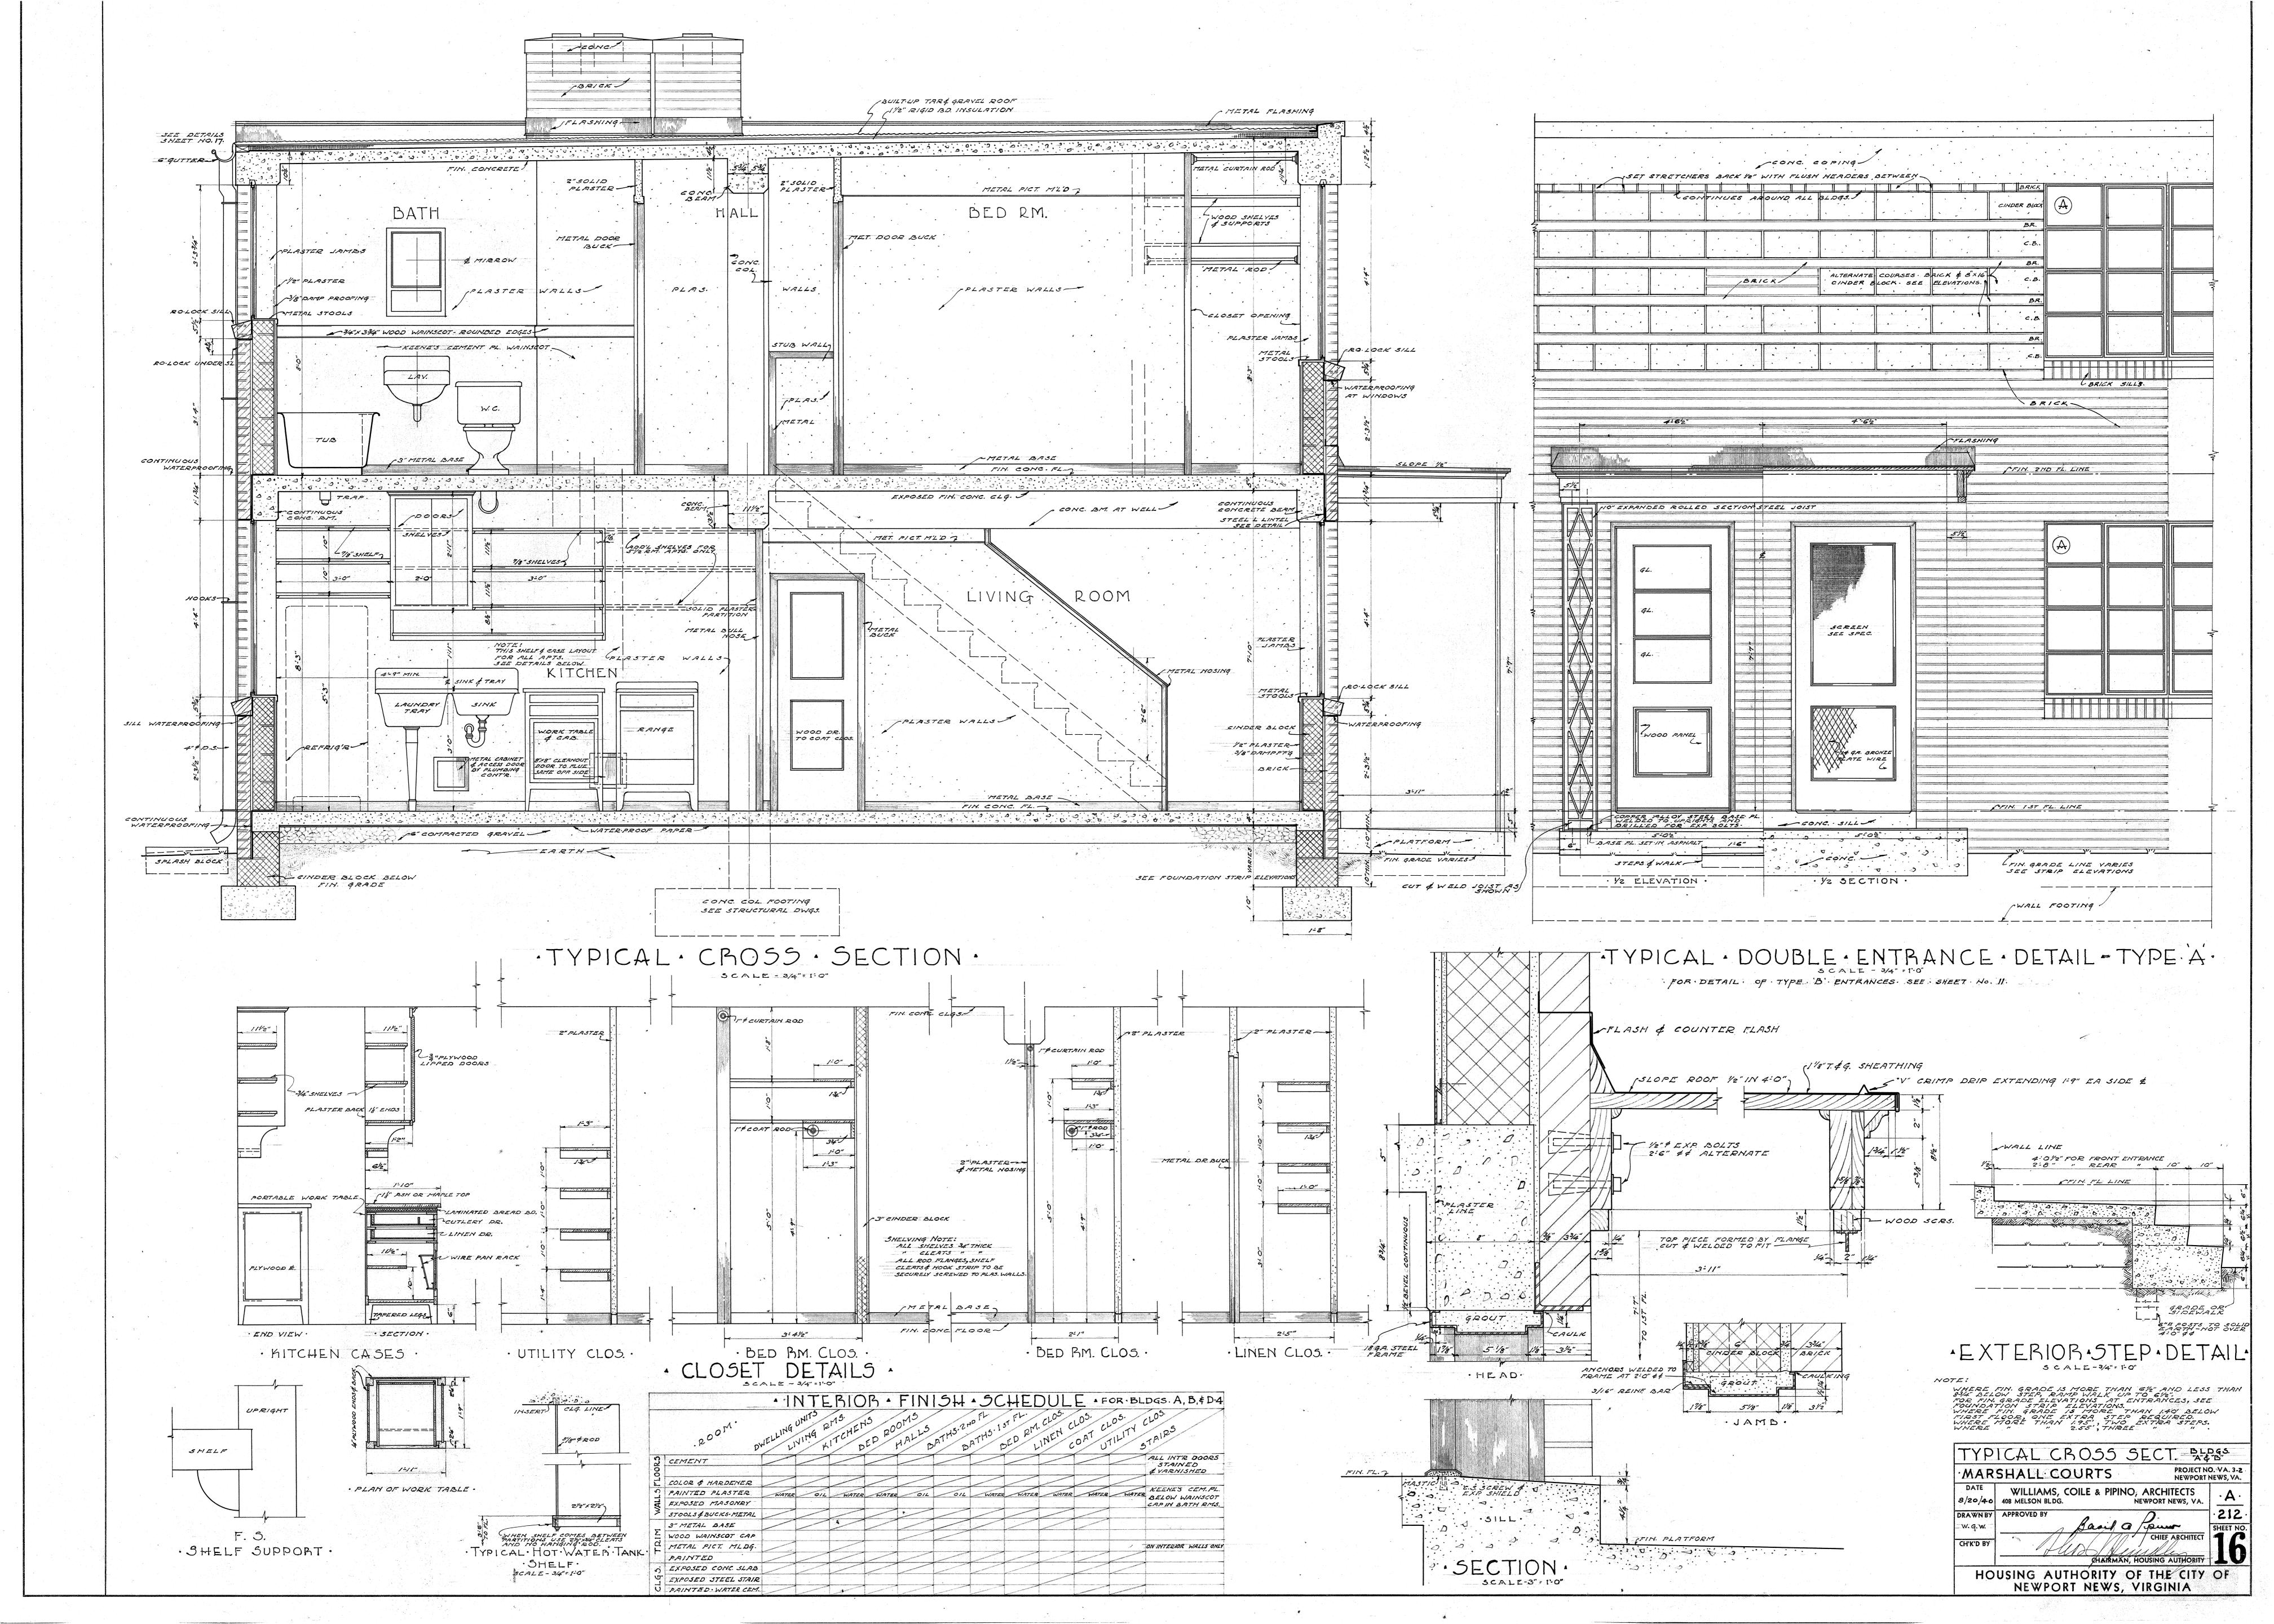


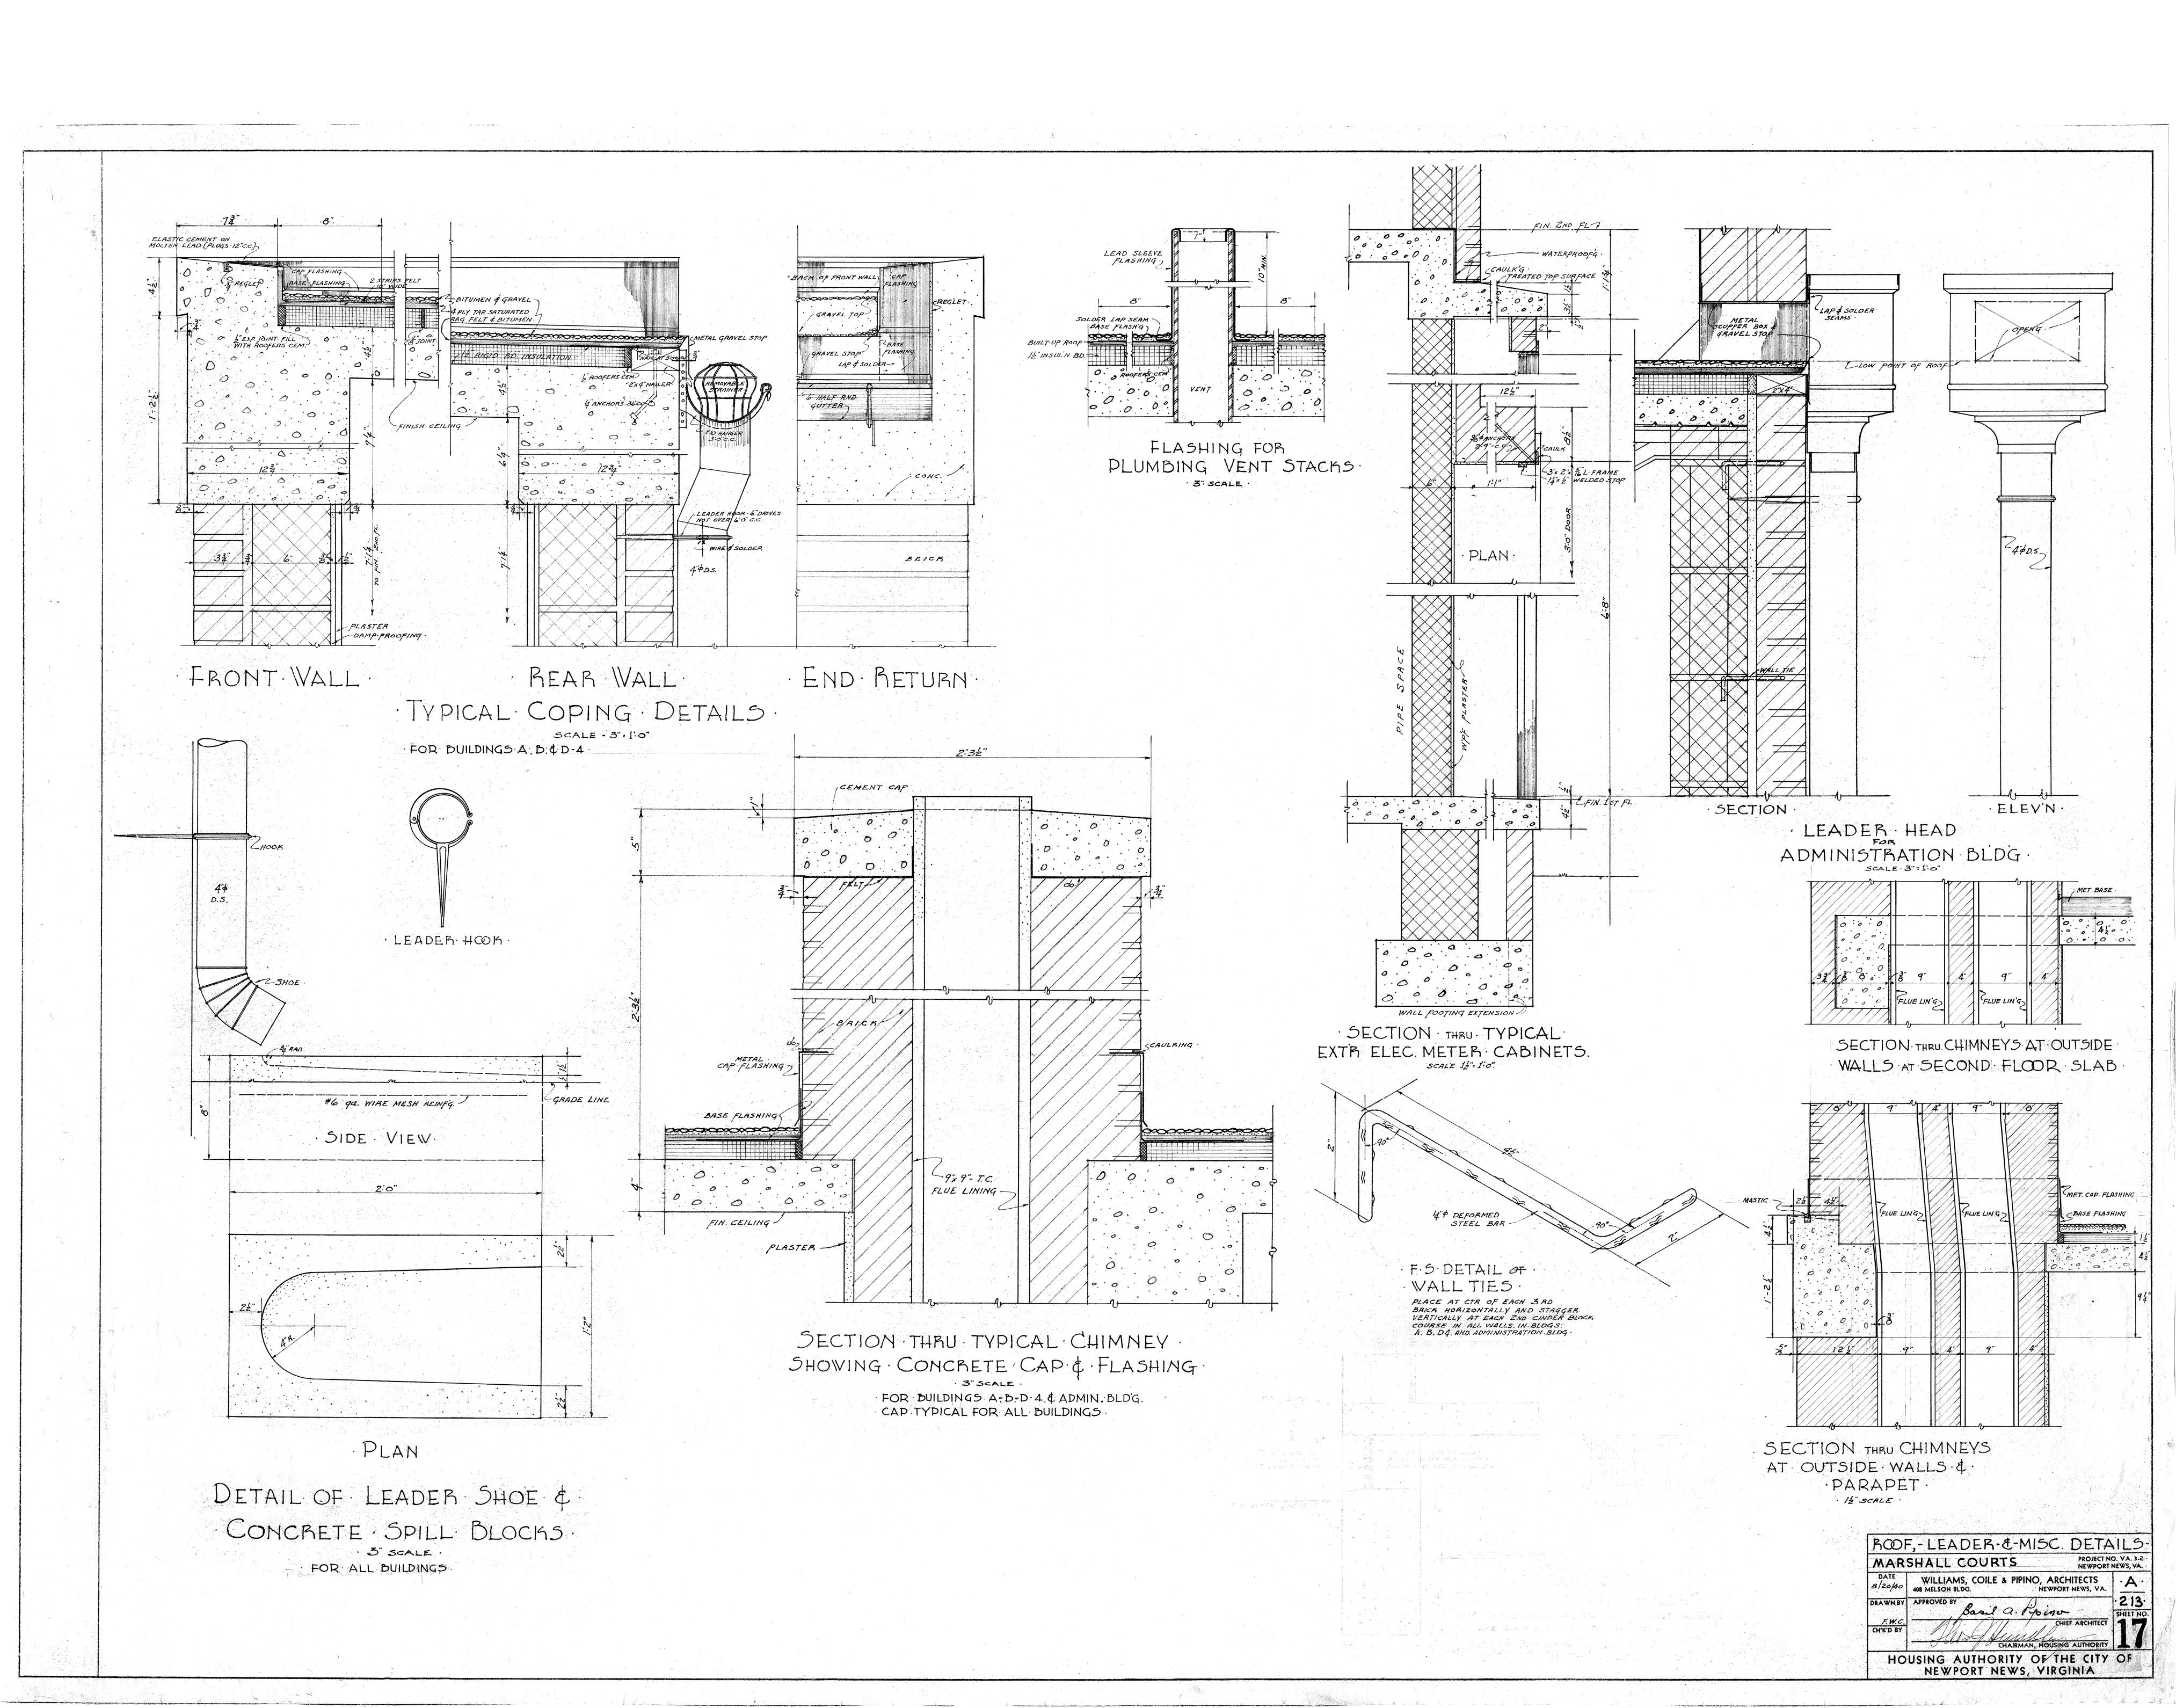


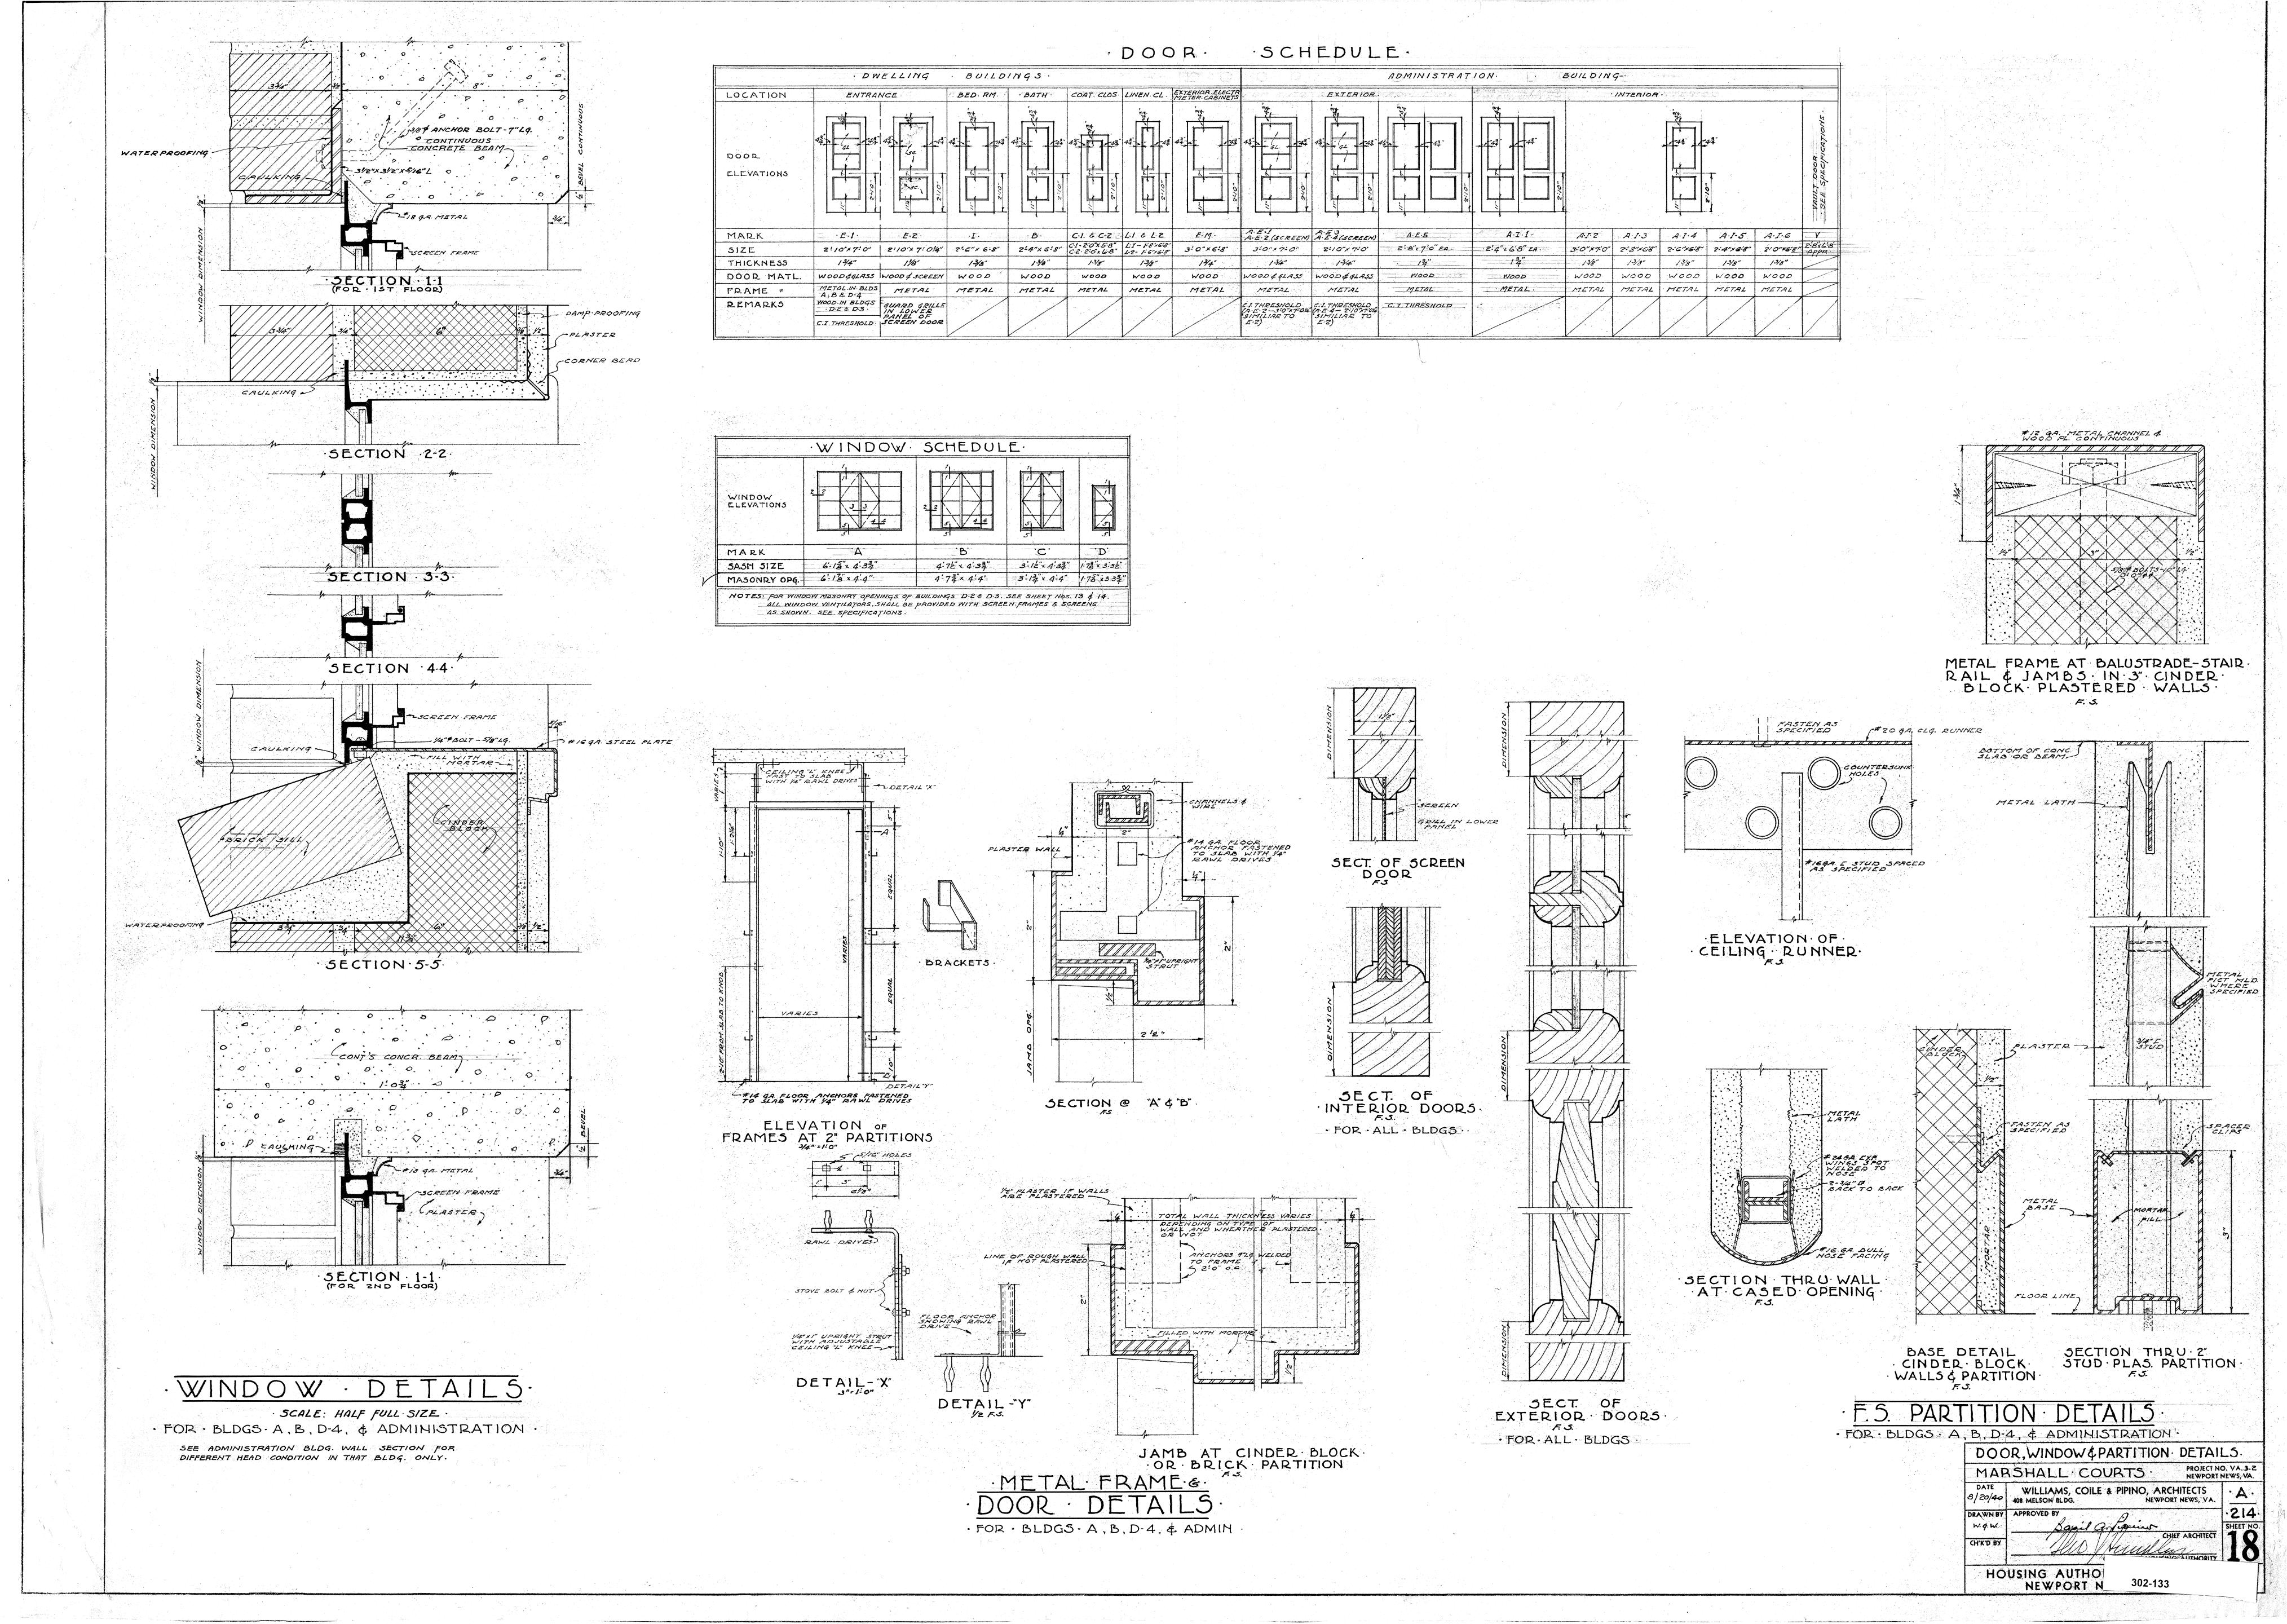


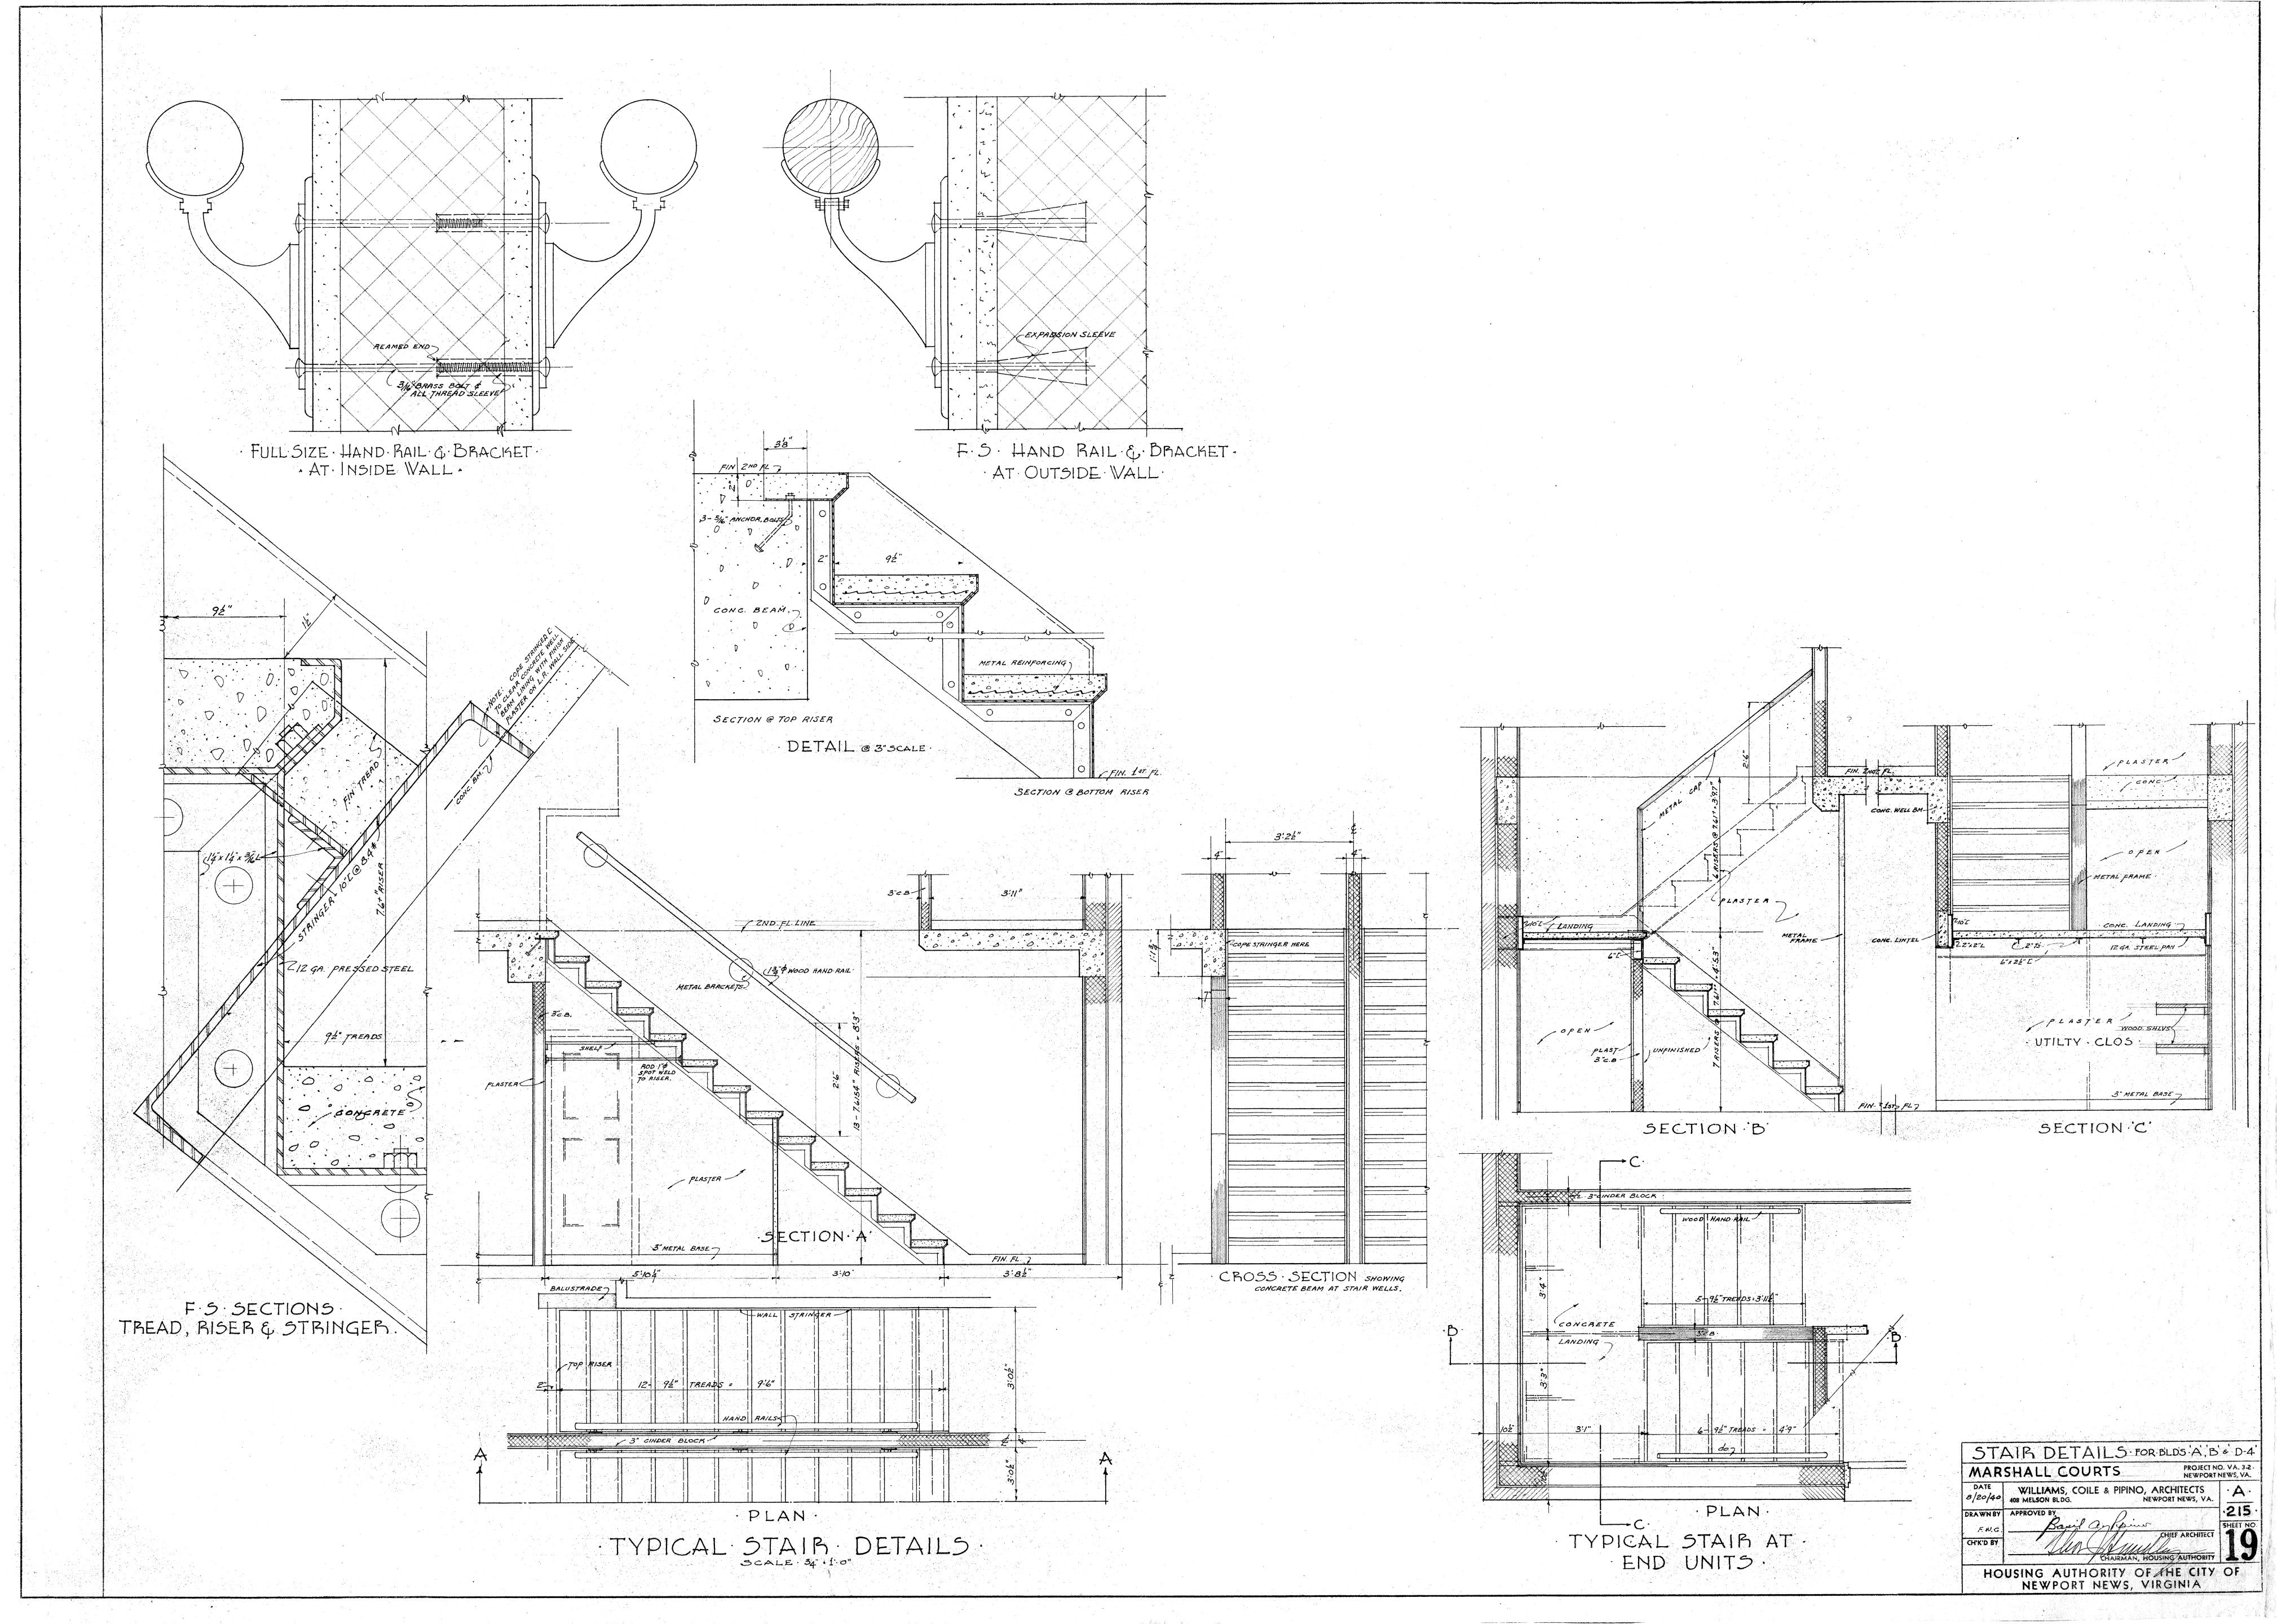


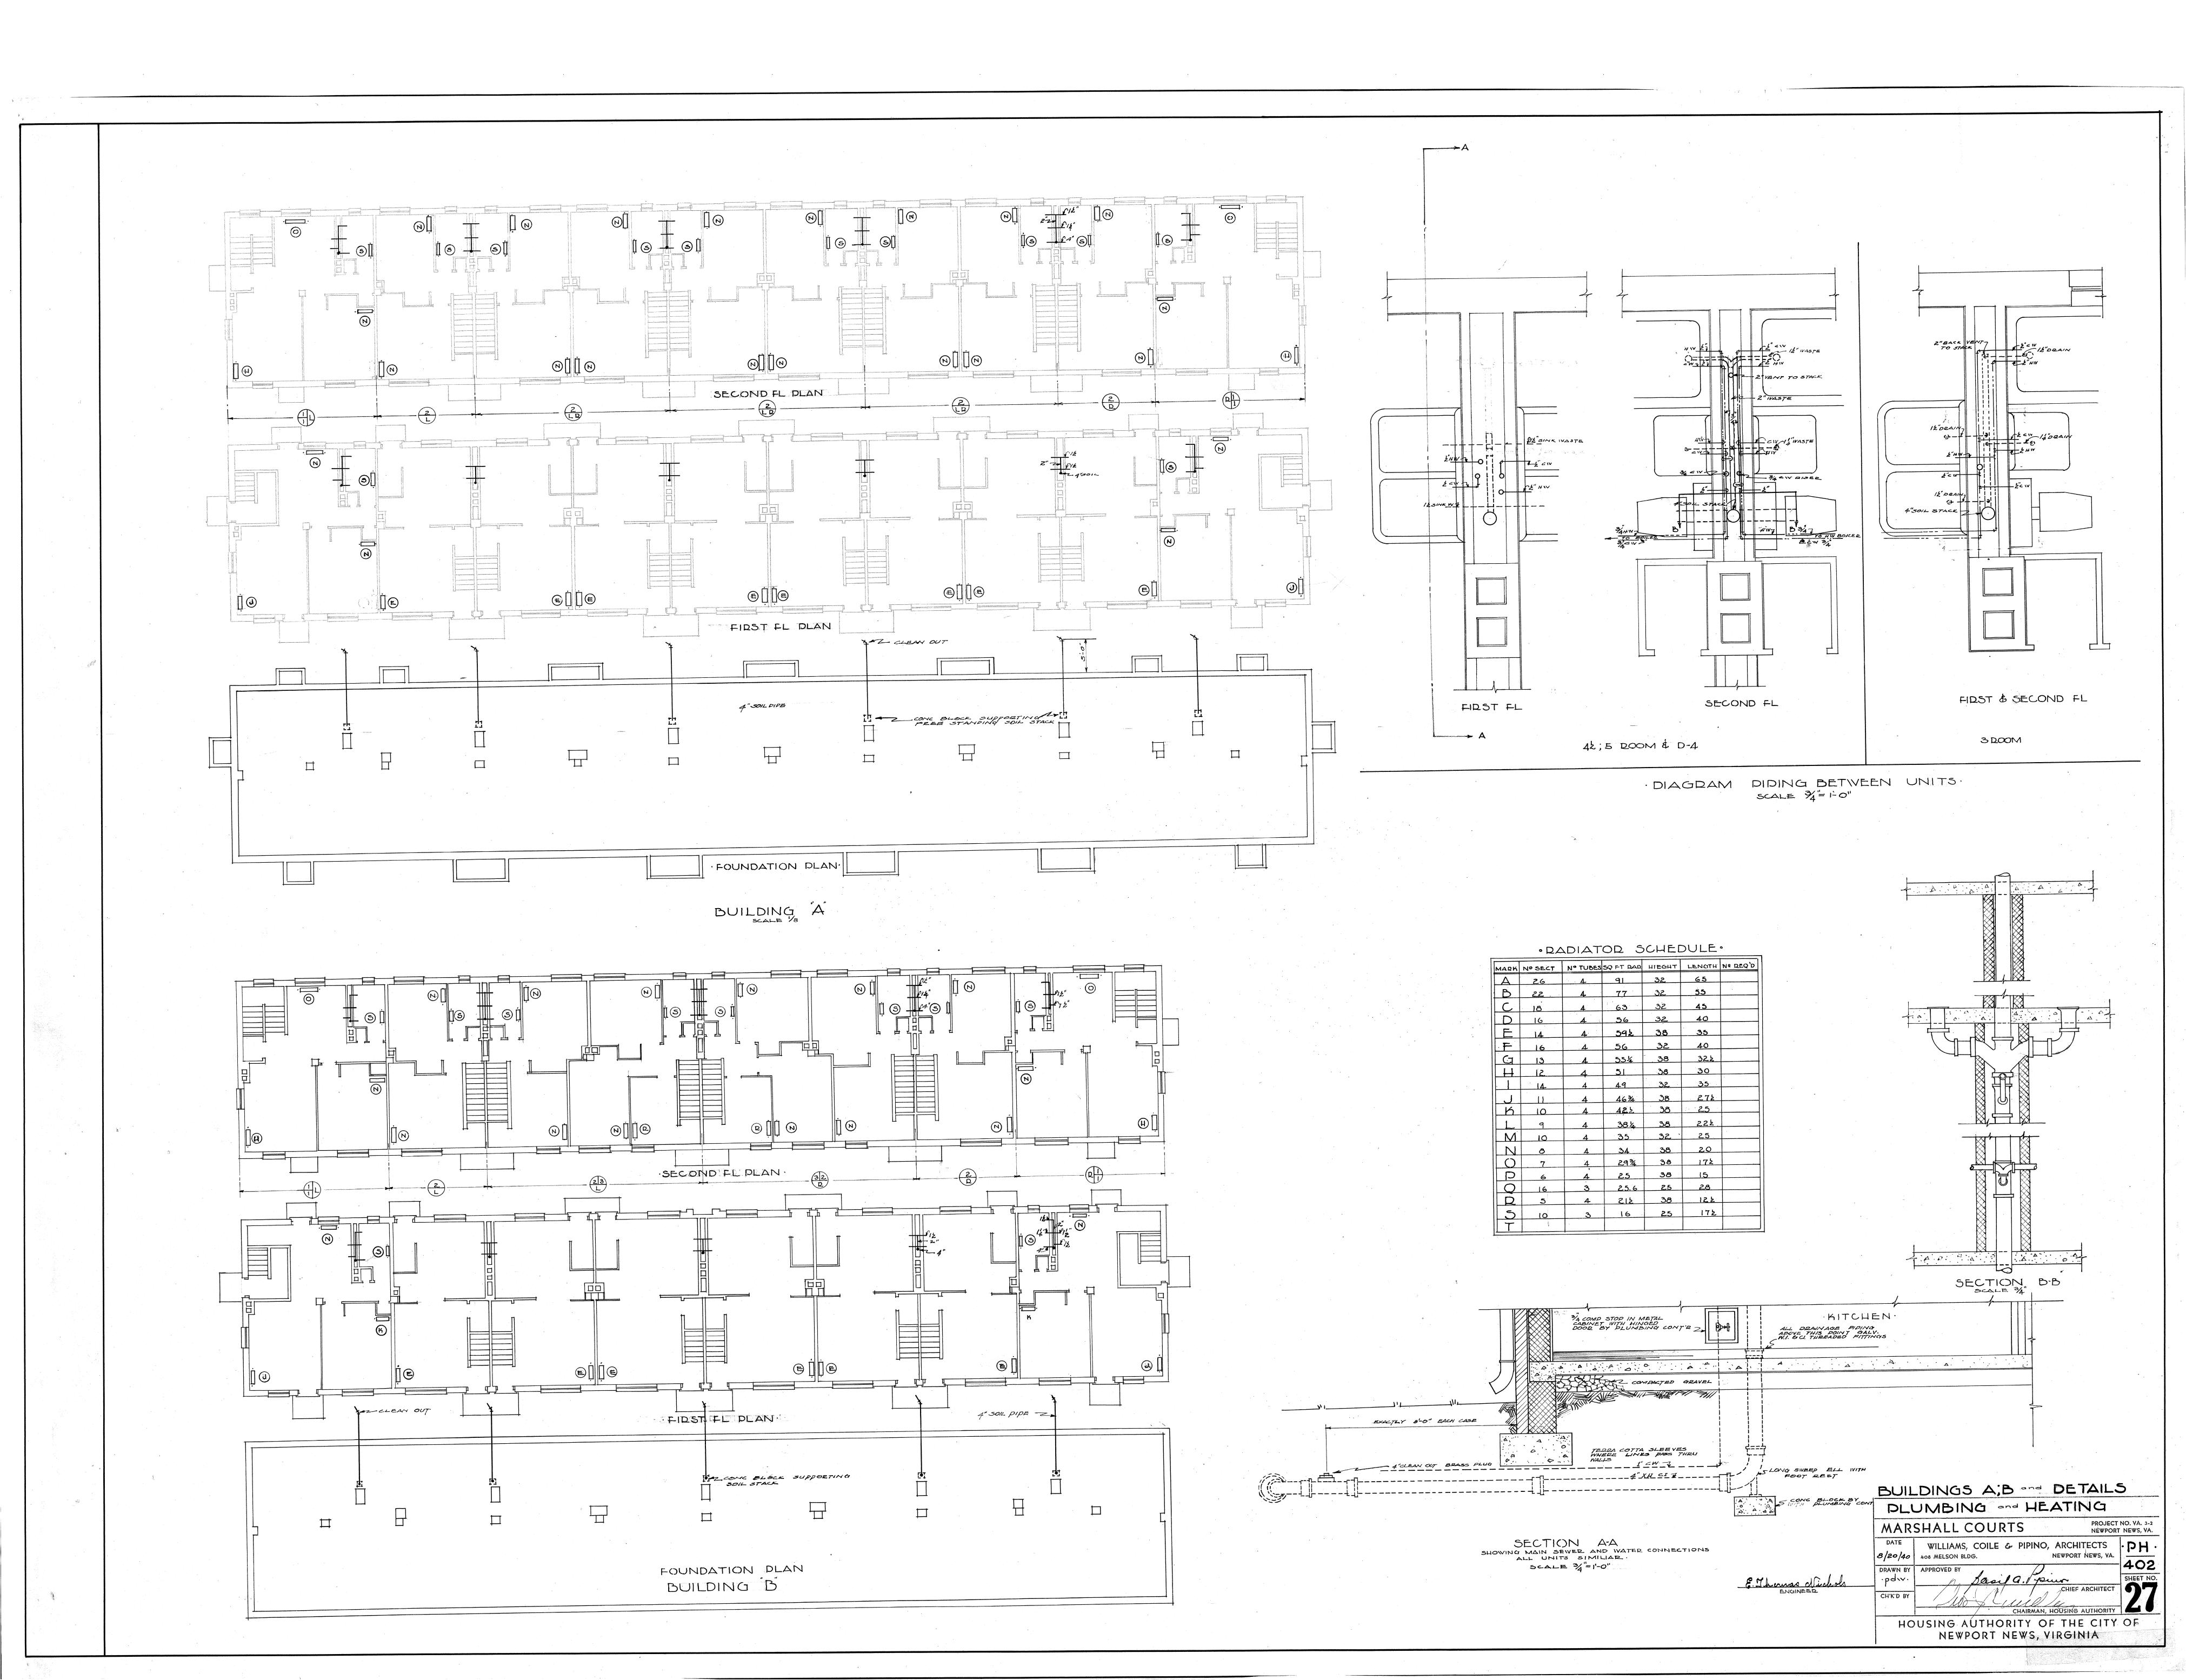


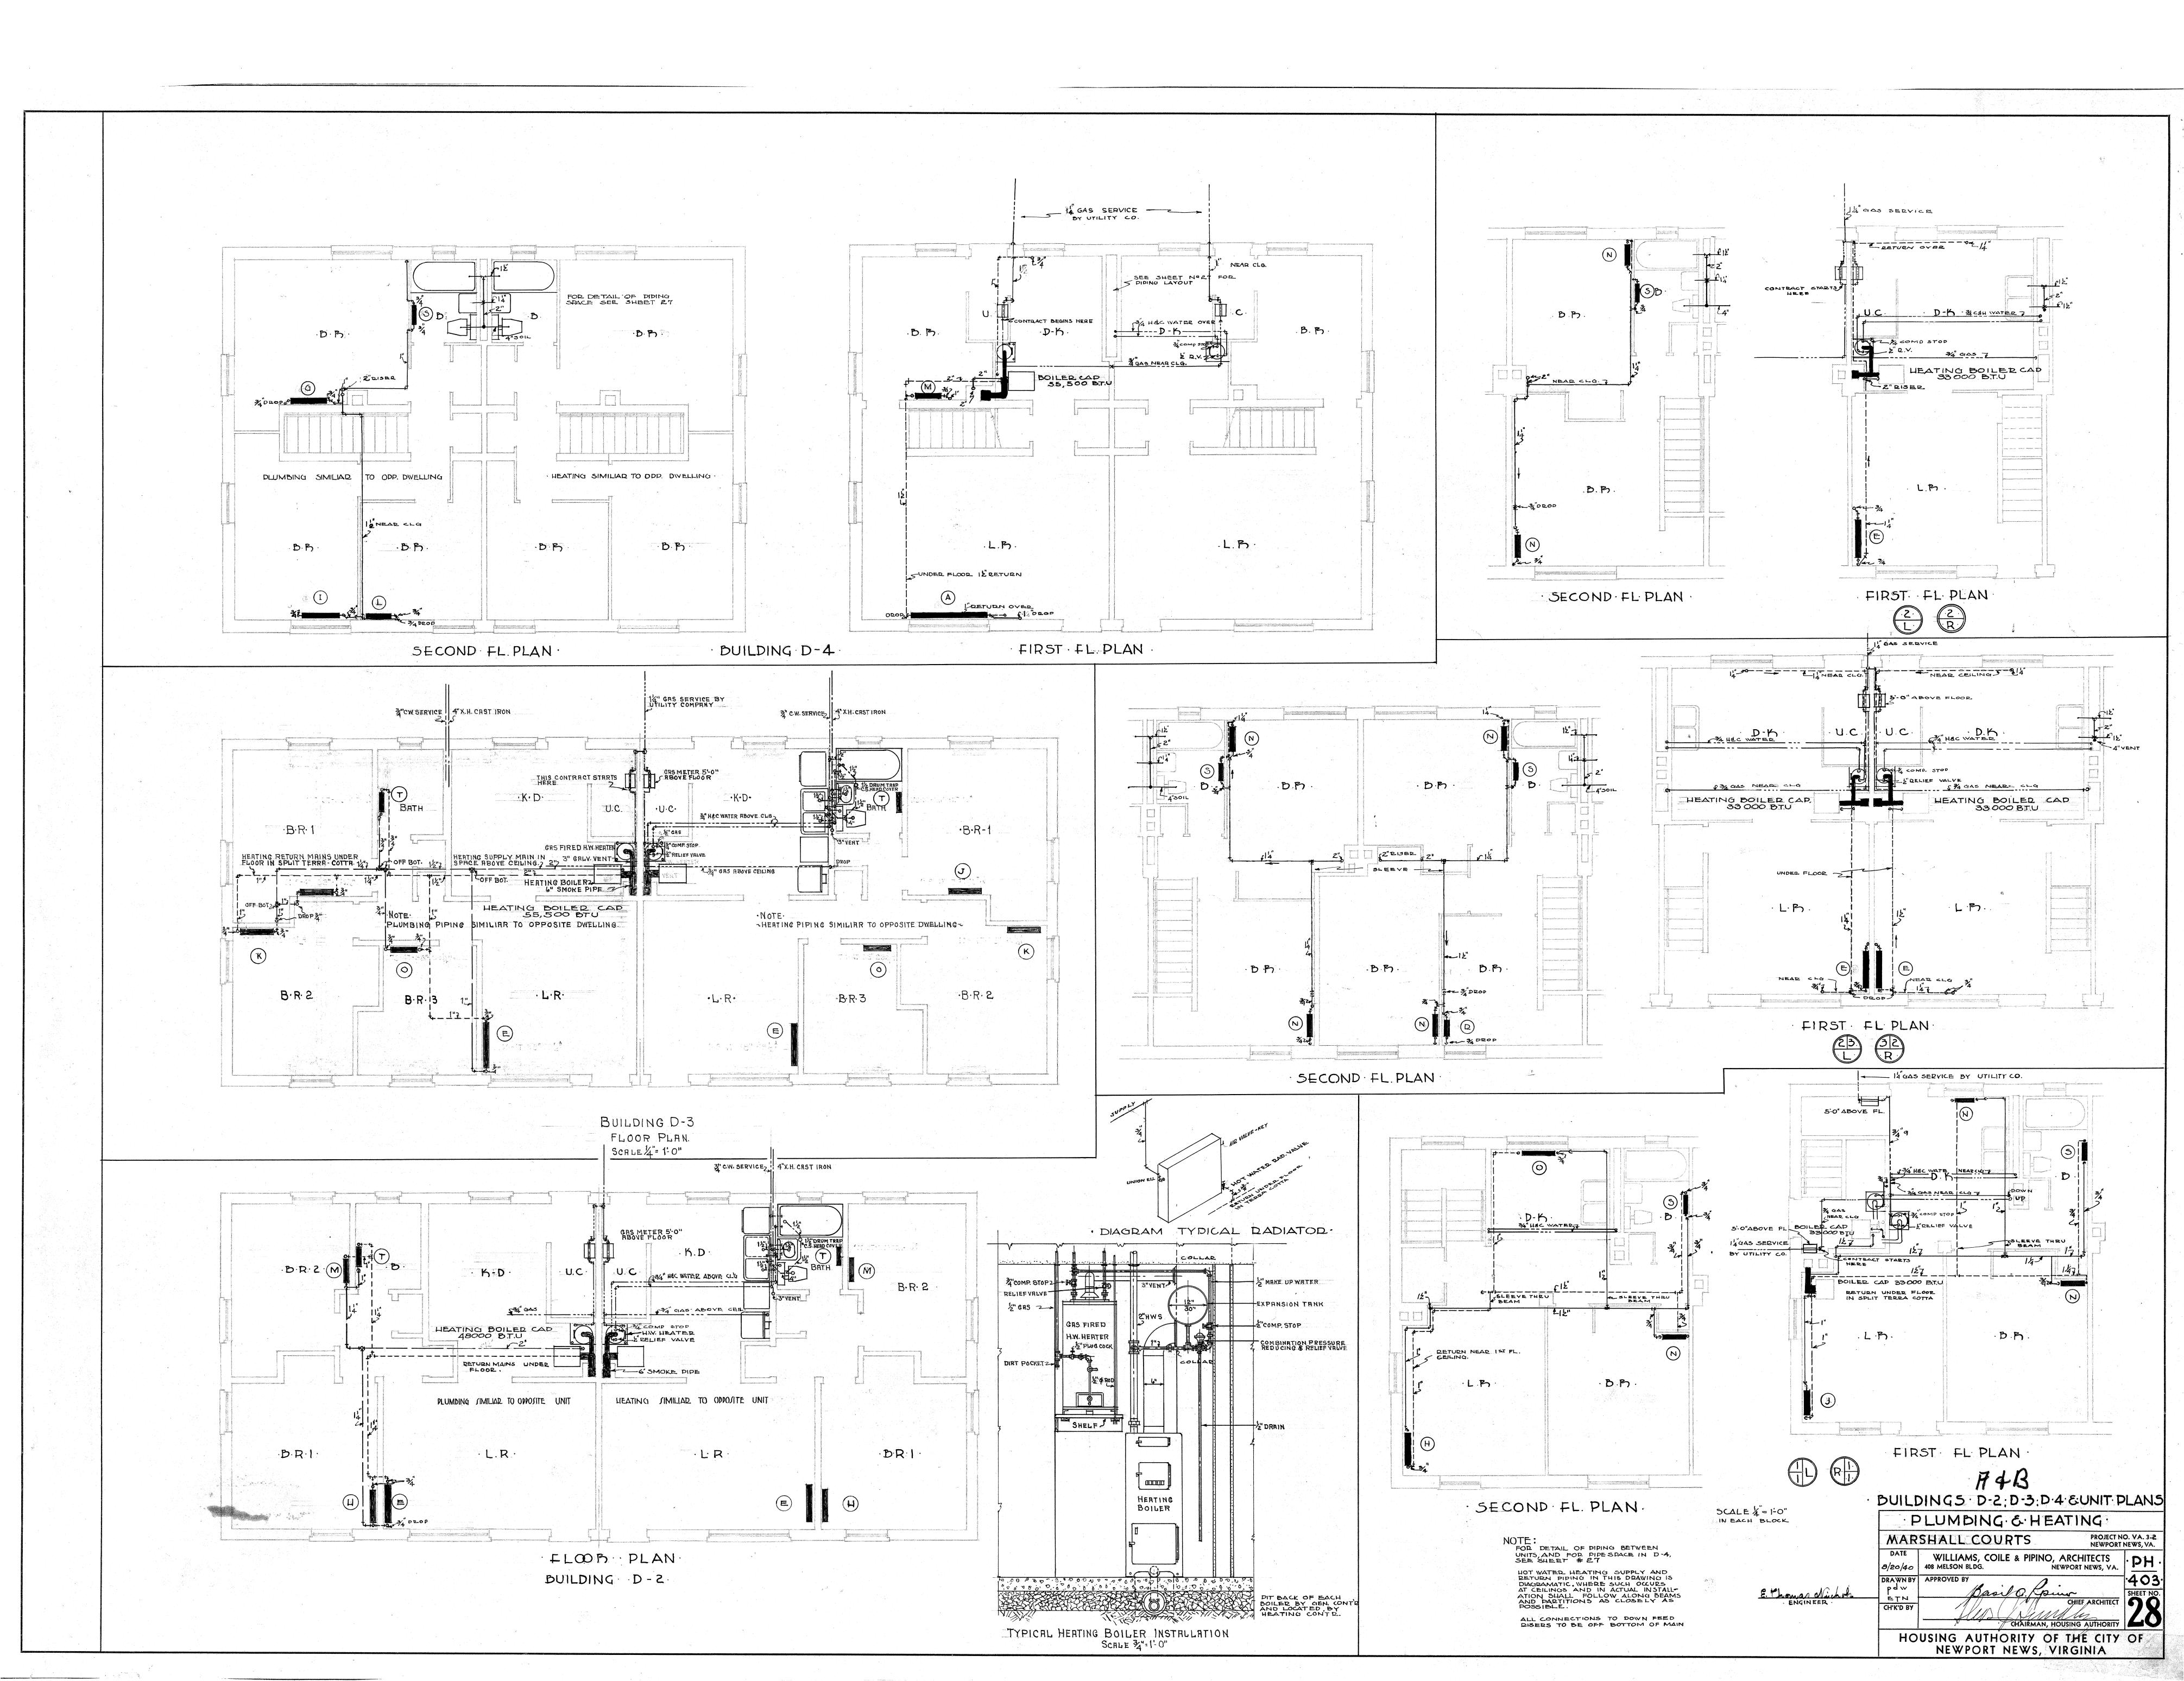

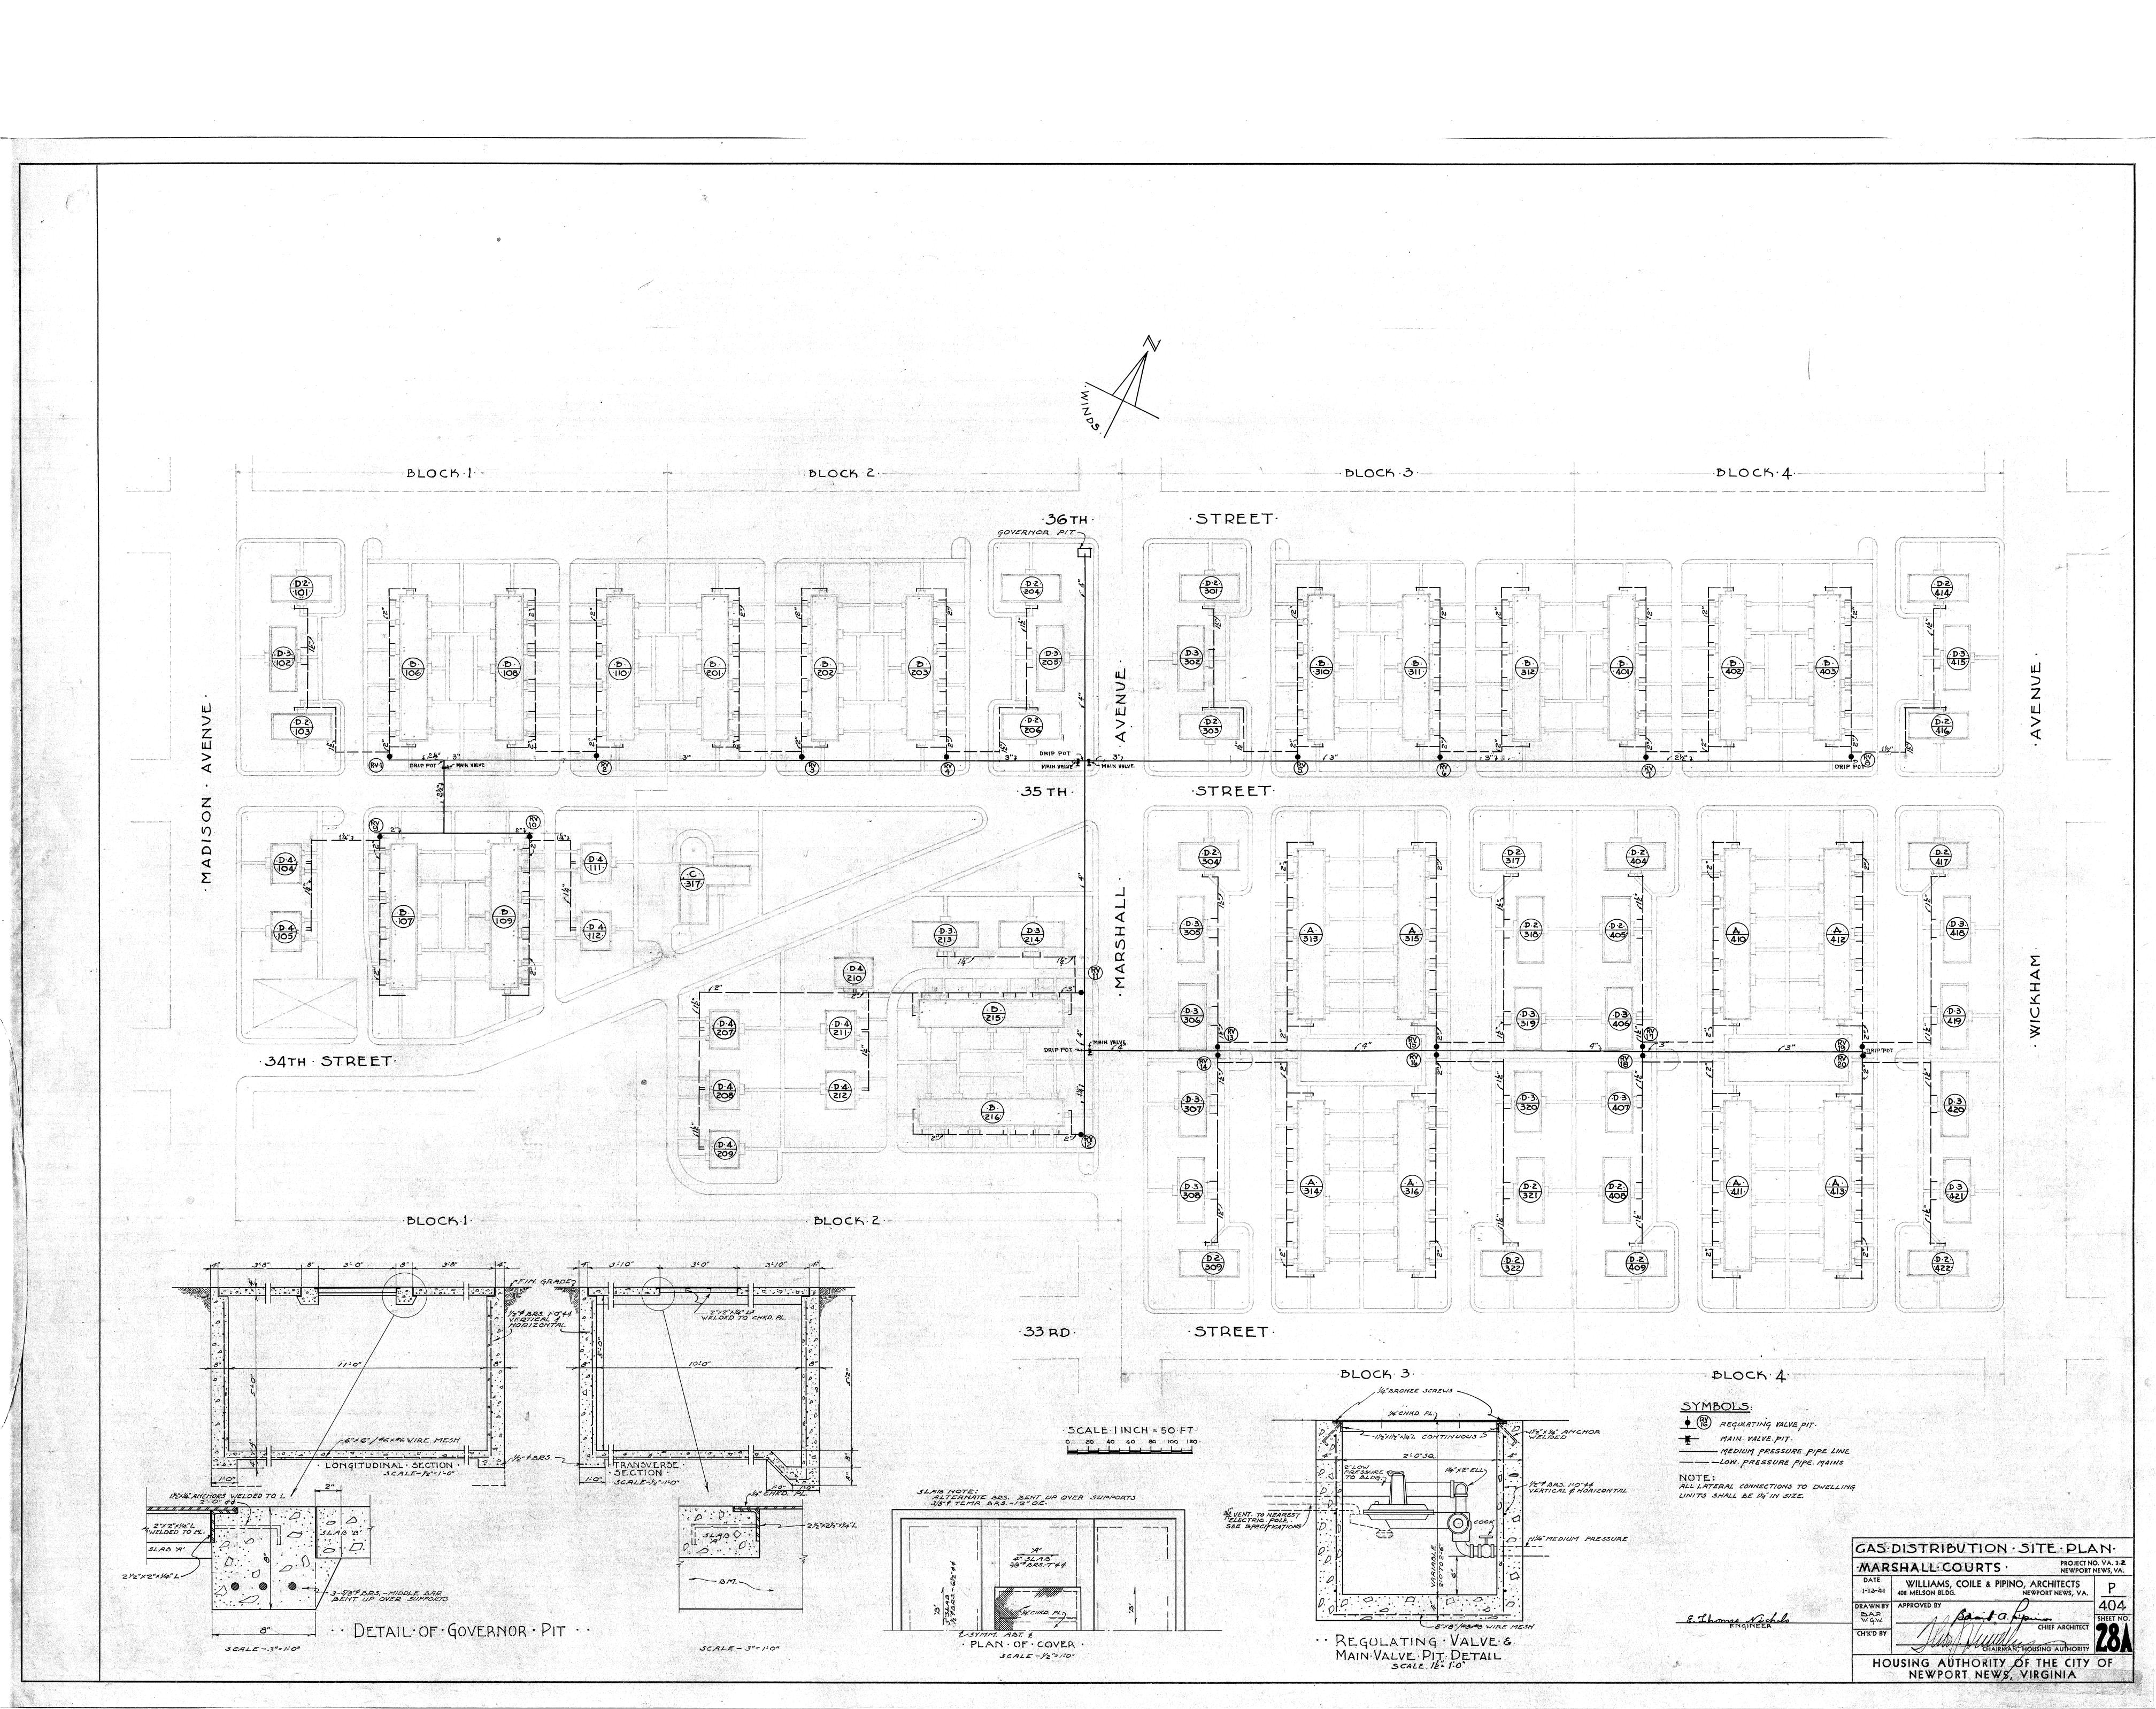

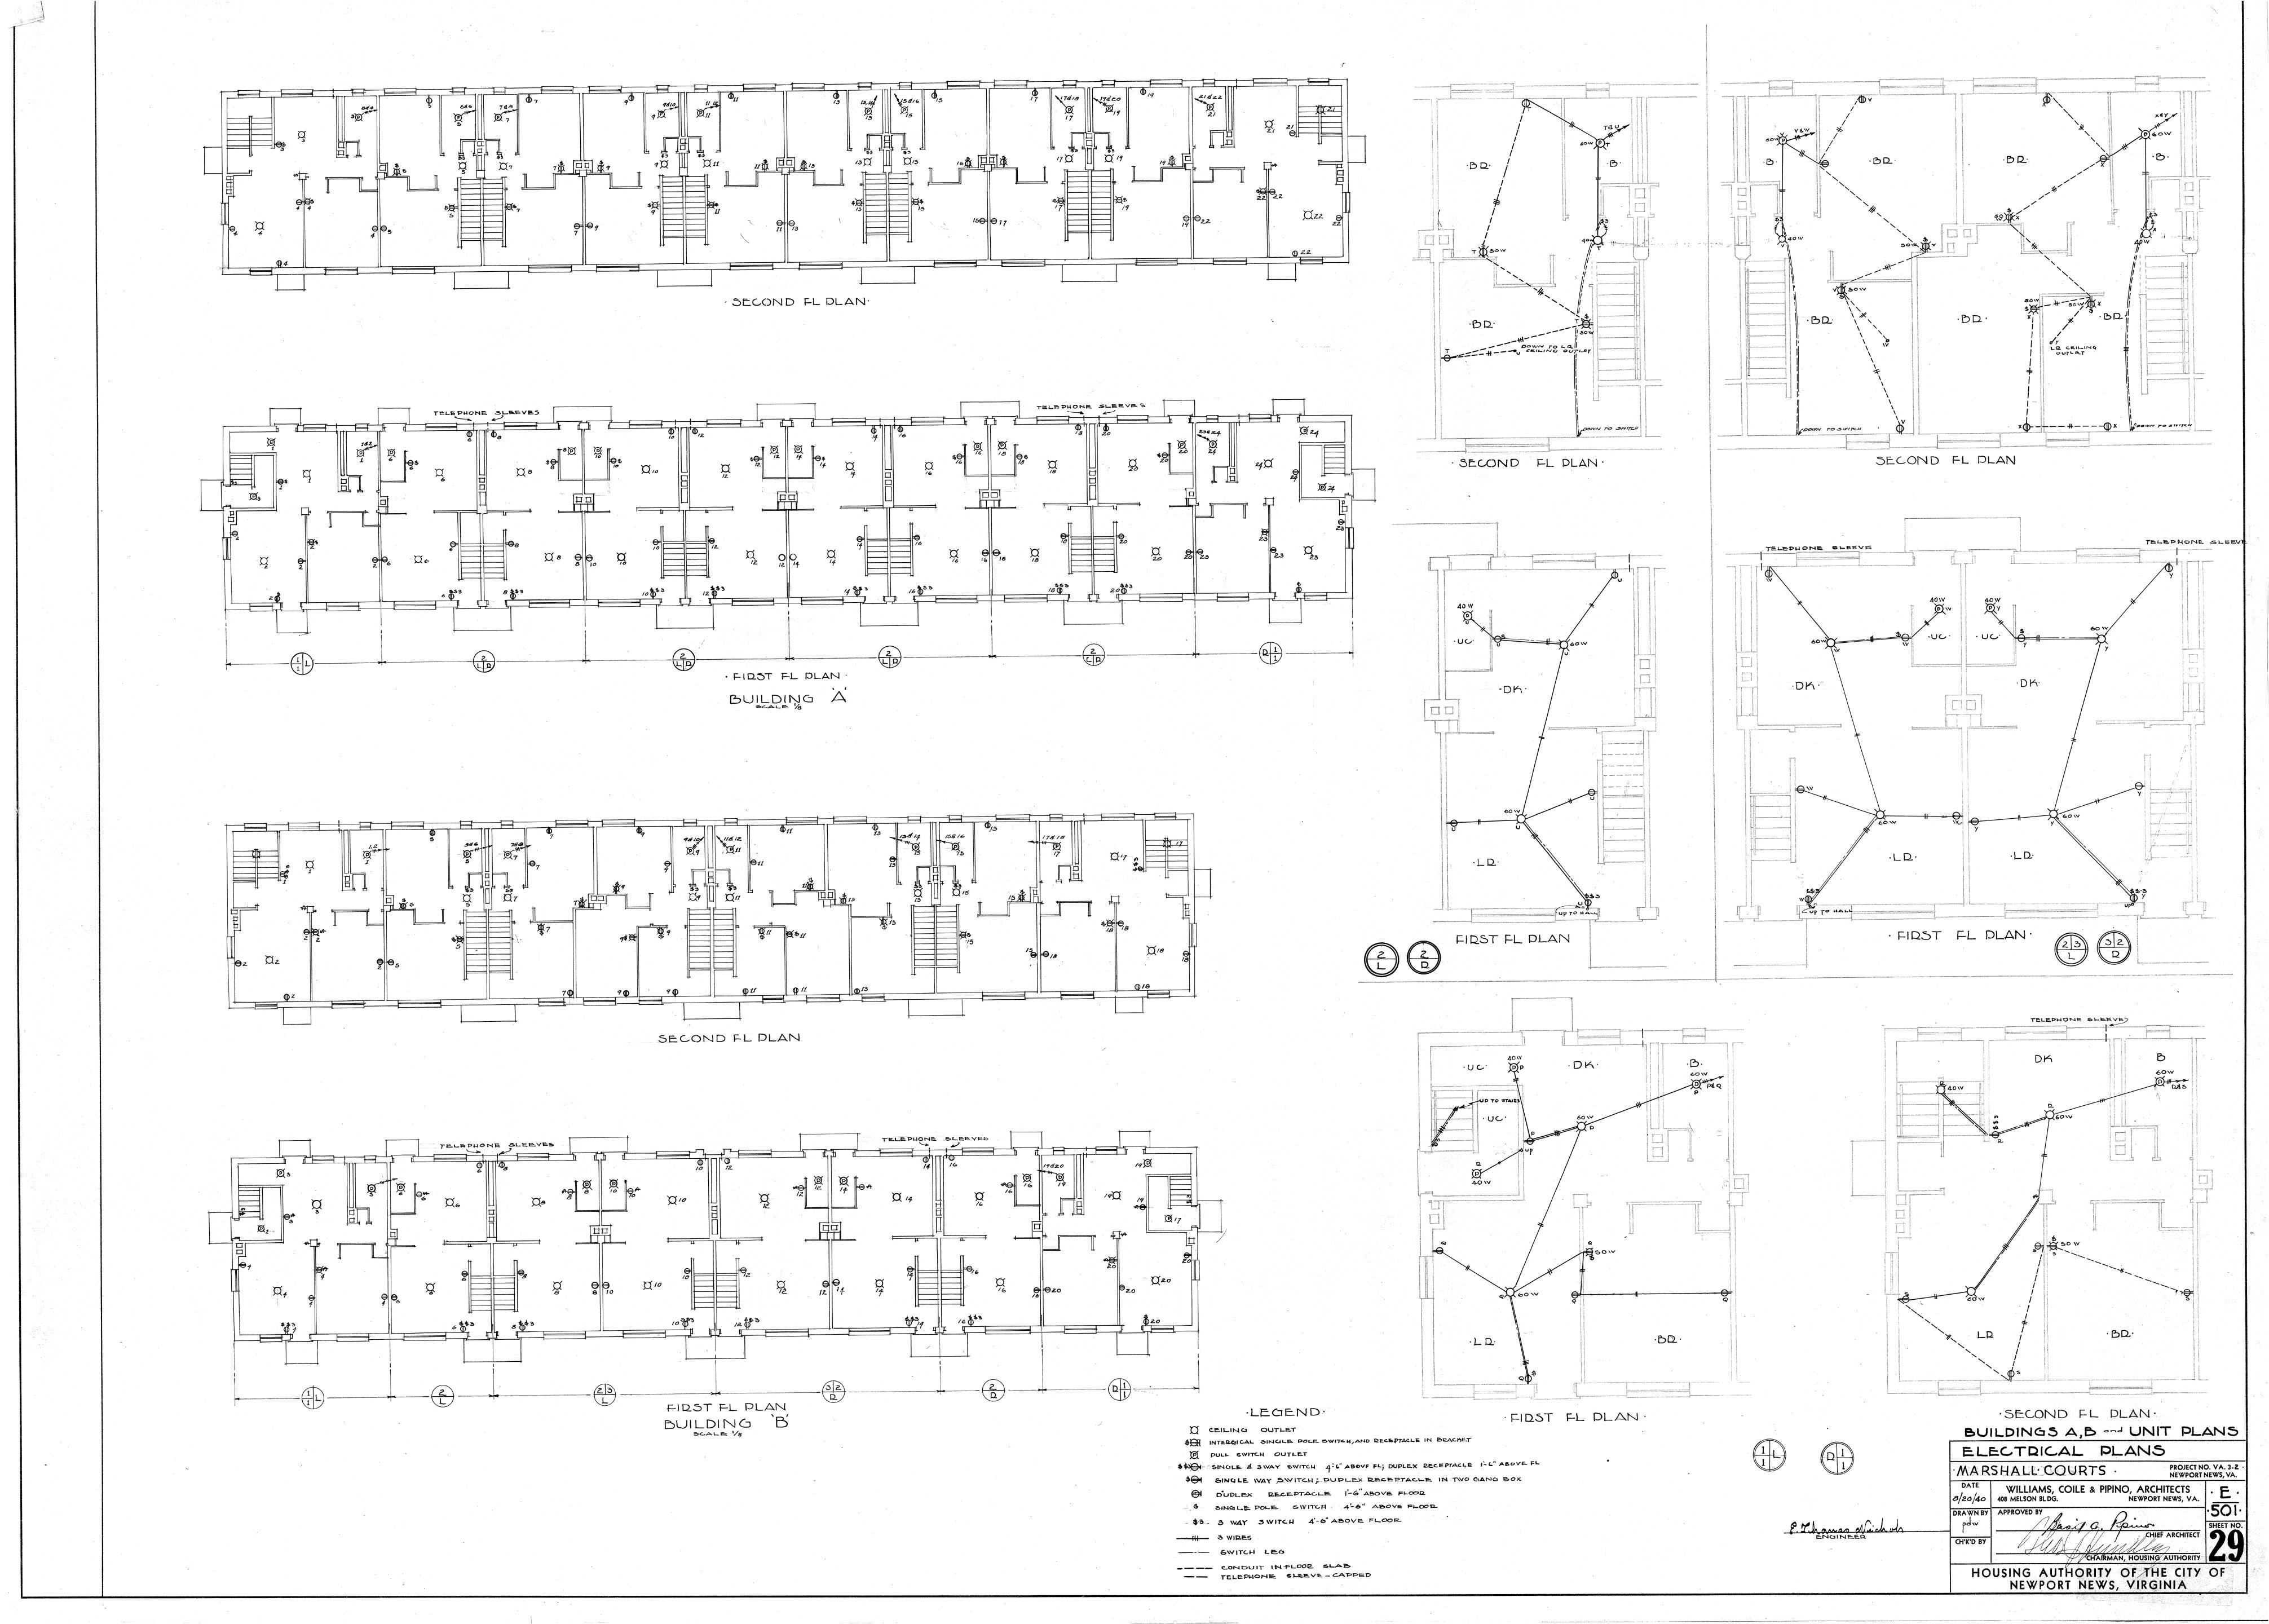

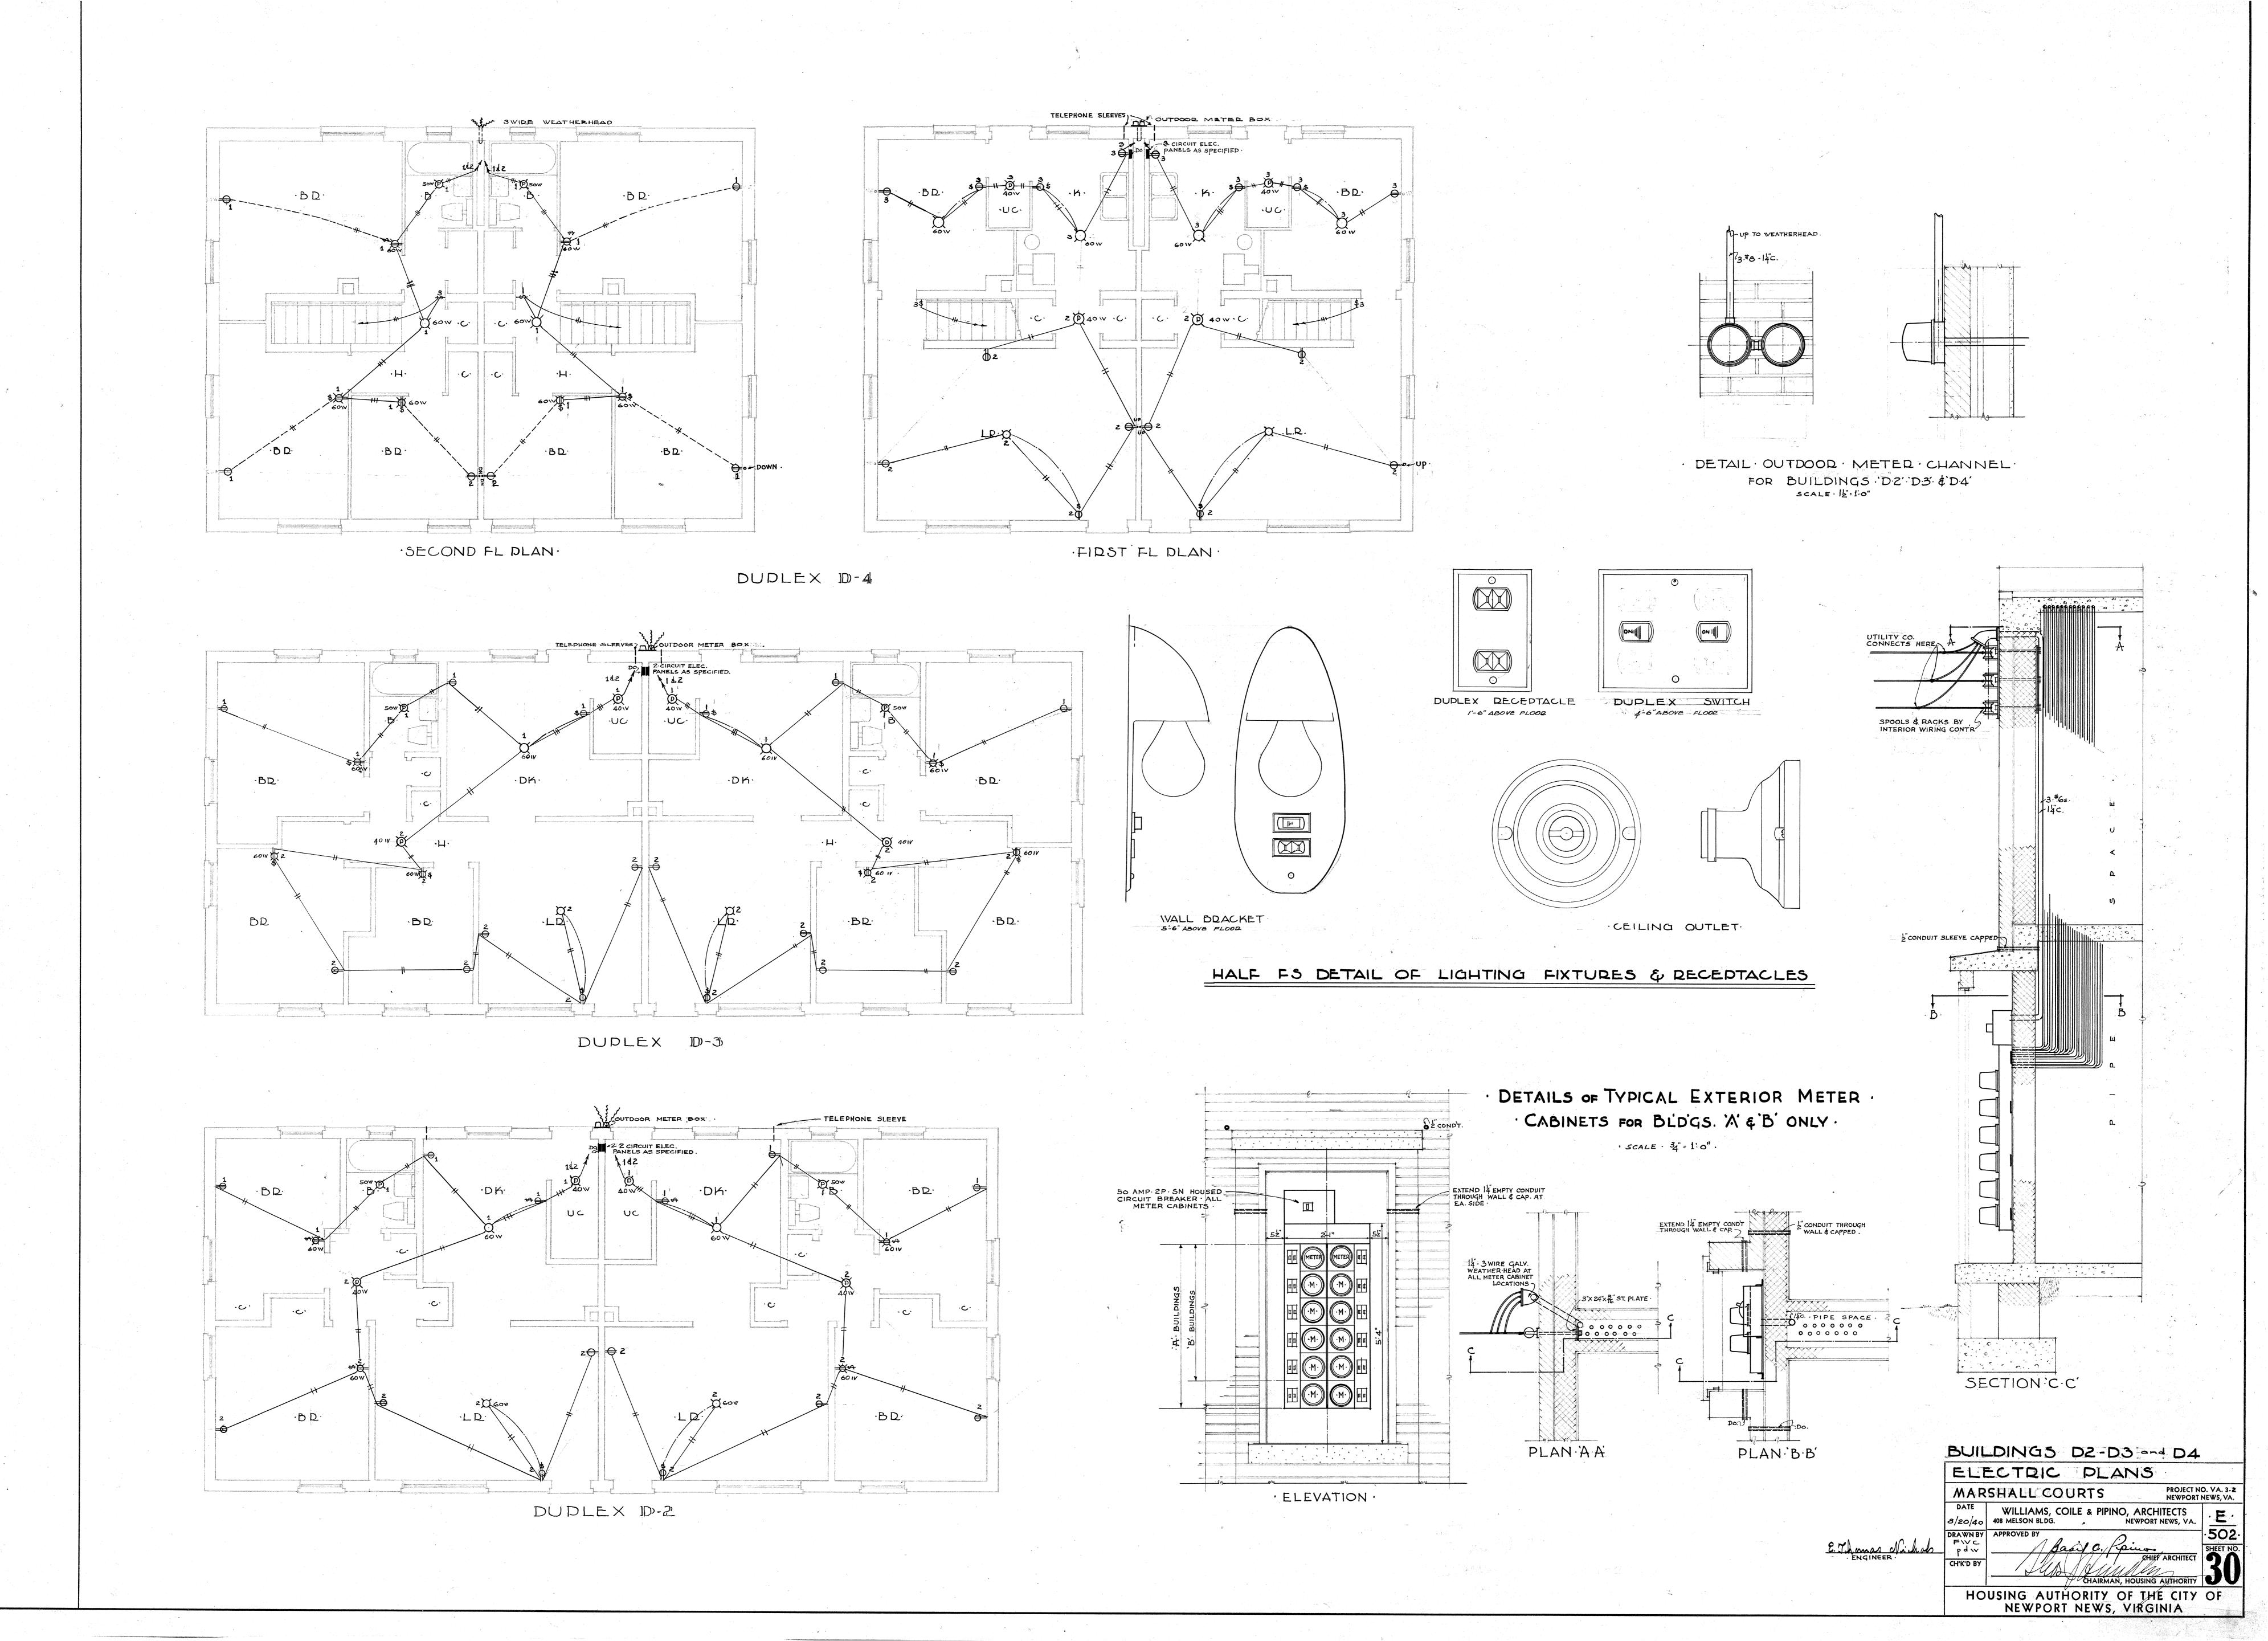

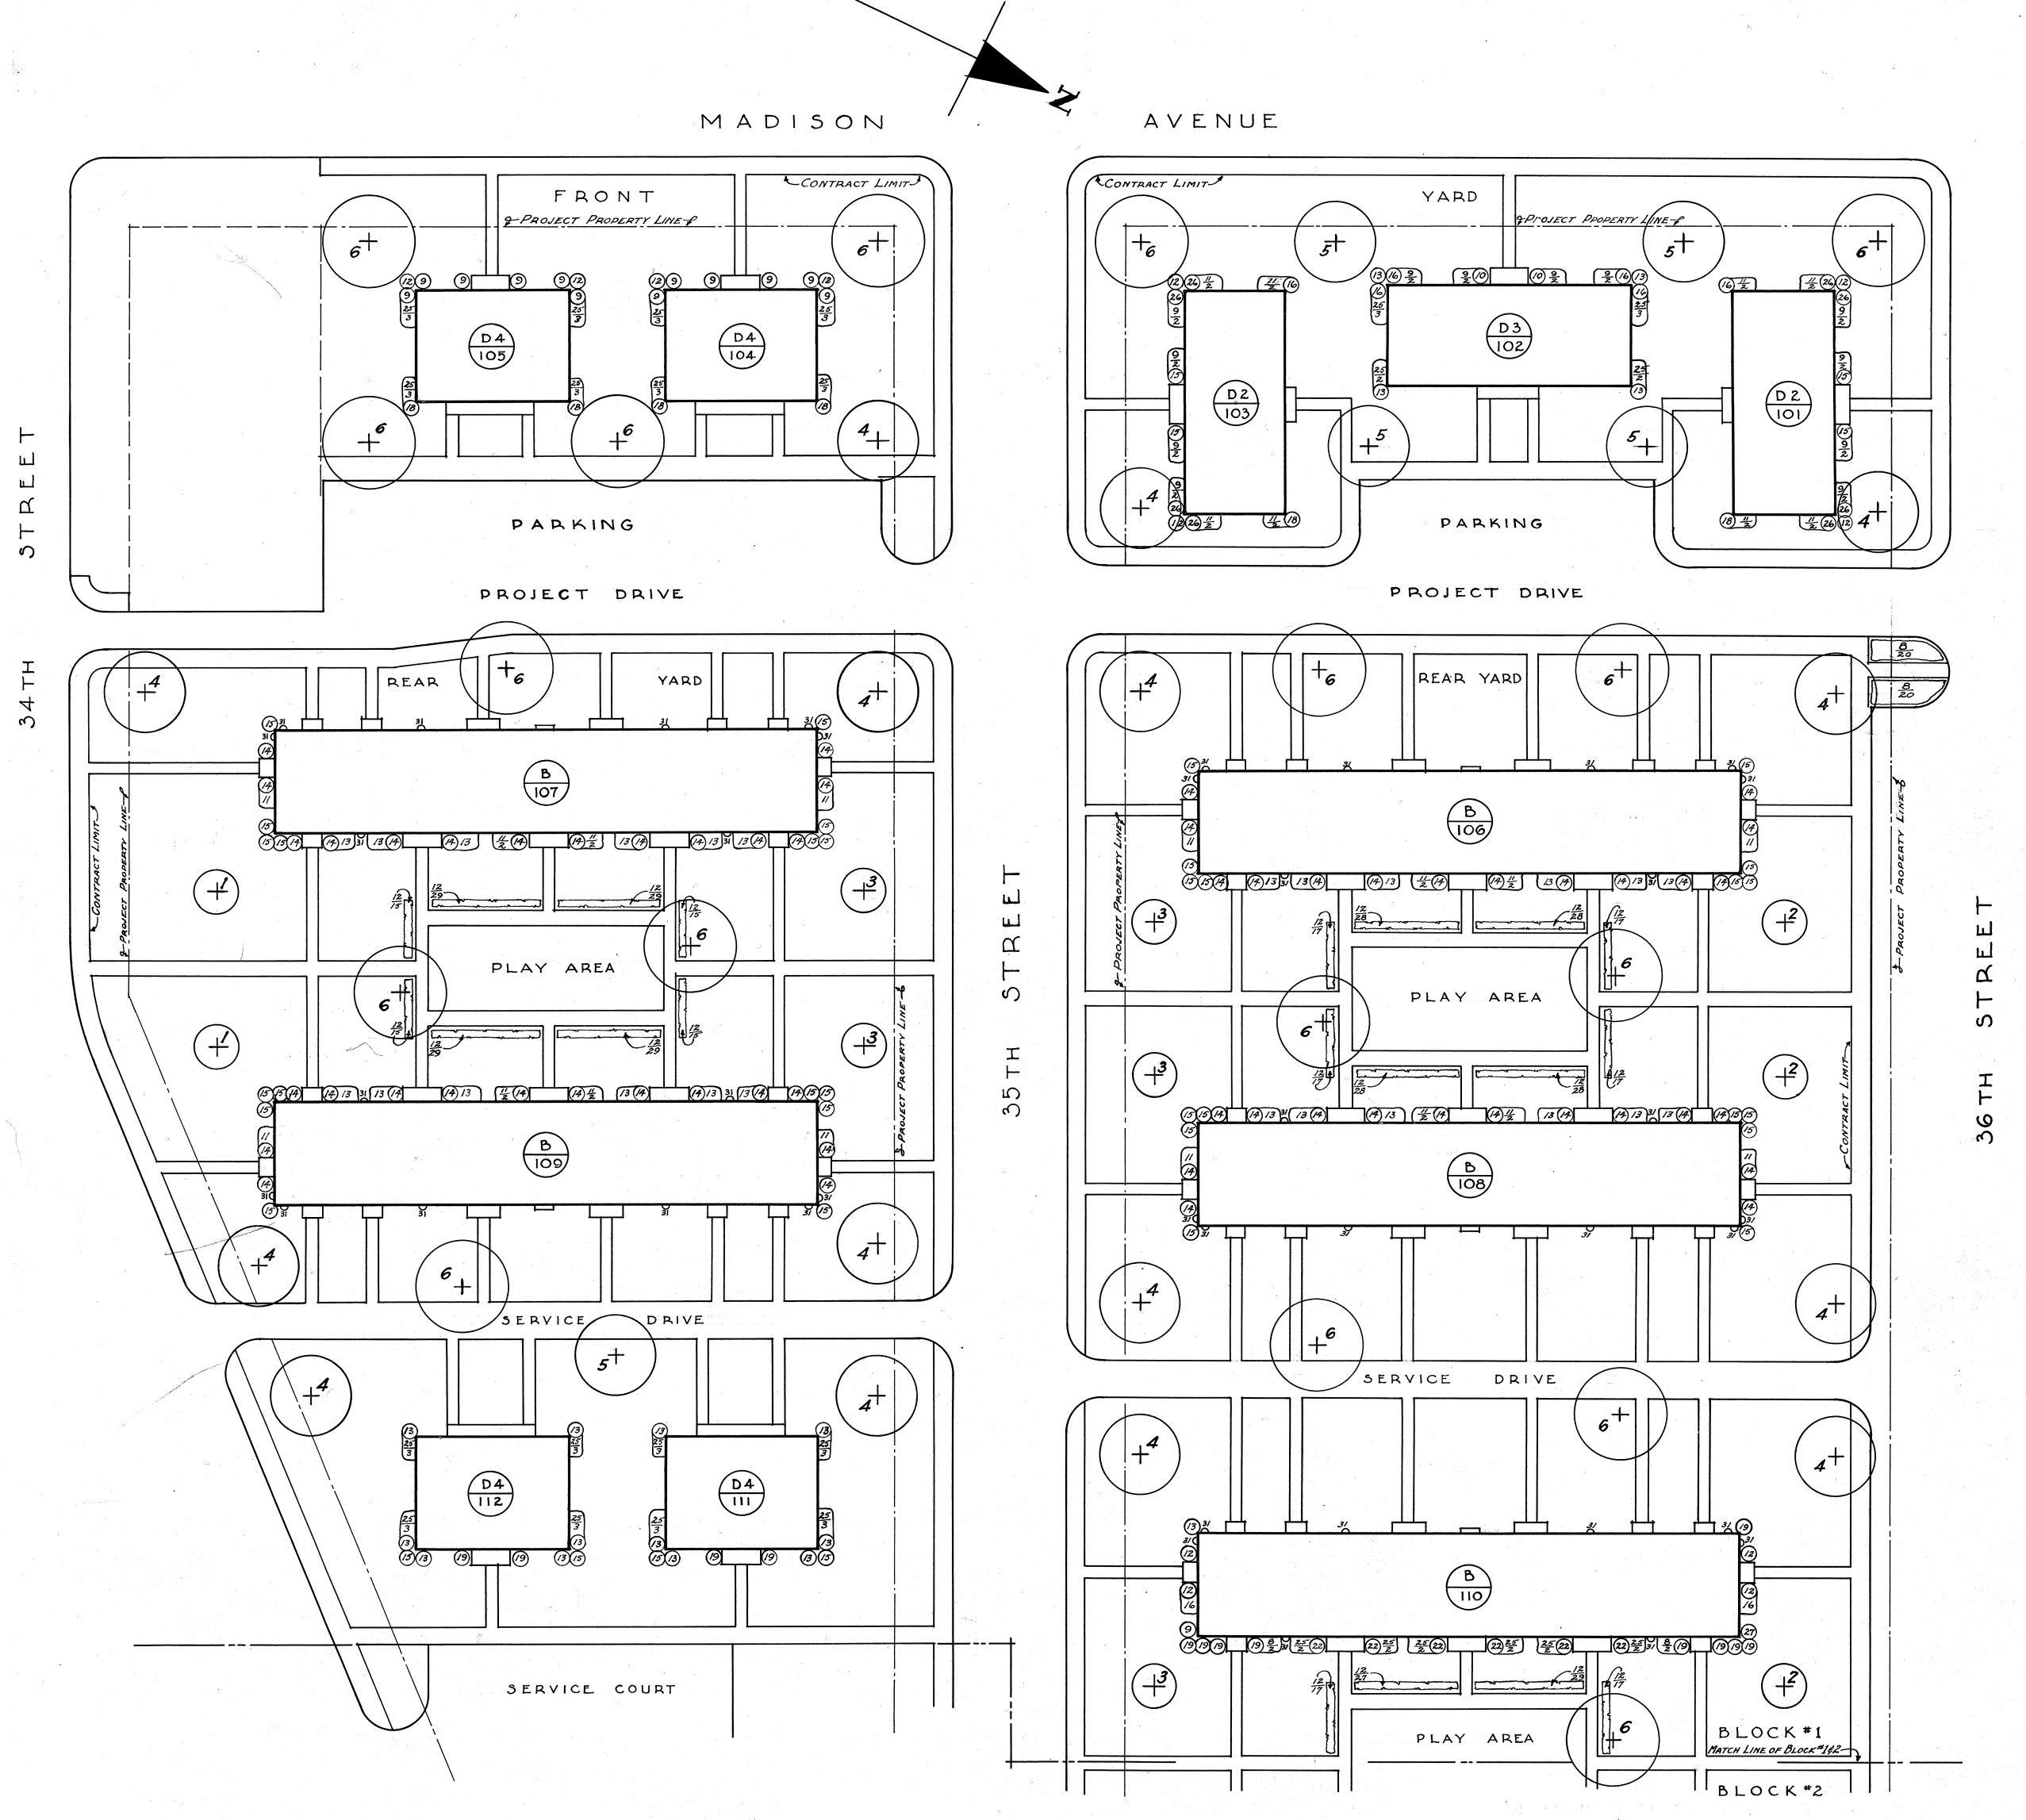

Note-for typical staking detail see sheet No-33


PLANT LIST. TYPE KEY NAME OF PLANT ALBIZZIA julibrissin Mimosa CERCIS canidensis American Redbud CORNUS florida Dogwood QUERCUS palustris Pin Oak TILIA vulgaris Common Linden ULMUS americana American Elm ABELIA grandiflora Abelia BERBERIS julianae Wintergreen Barberry COTONEASTER franchetti Cotoneaster ELEAEGNUS pungens Russian Olive JASMINUM floridum Jasminum LIGUSTRUM lucidum compactum Glossy Privet LONICERA nitida Honeysuckle OSMANTHUS fortunei Fortune Osmanthus PRUNUS lanrocerasus caroliniana Carolina Cherry Laurel PYRACANTHA coccinea lalandi Laland Firethorn PYRACANTHA crenulata yuannensis Firethorn VIBURNUM tinsus Viburnum VIBURNUM rhytidophyllum Viburnum BUDDLEIA davidi isle defrance Butterfly Bush CHAENOMELES lagenaria Japanese Quince FORSYTHIA intermedia Forsythia LAGERSTROEMIA indica Crape Myrtle PRUNUS glandulosa alba plena White Flowering Almond SPIRAEA thunbergii Japanese Spirea SPIRAEA van houttei Van Houttes Spirea VIBURNUM dentatum Arrowwood WEIGELA rosea Weigela LIGUSTRUM obtusifolium regelianum Regels Privet GELSEMIUM sempervirens Carolina Yellow Jessamine HEDERA helix English lvy NOTE: Numbers shown in plant beds refer to the key numbers above. In cases where two numbers are shown, the upper number refers to


NOTE: Numbers shown in plant beds refer to the key numbers above.

In cases where two numbers are shown, the upper number refers to key number above and indicates the kind of plant used; the lower number indicates the number of plants needed.


Location of trees shown thus: 


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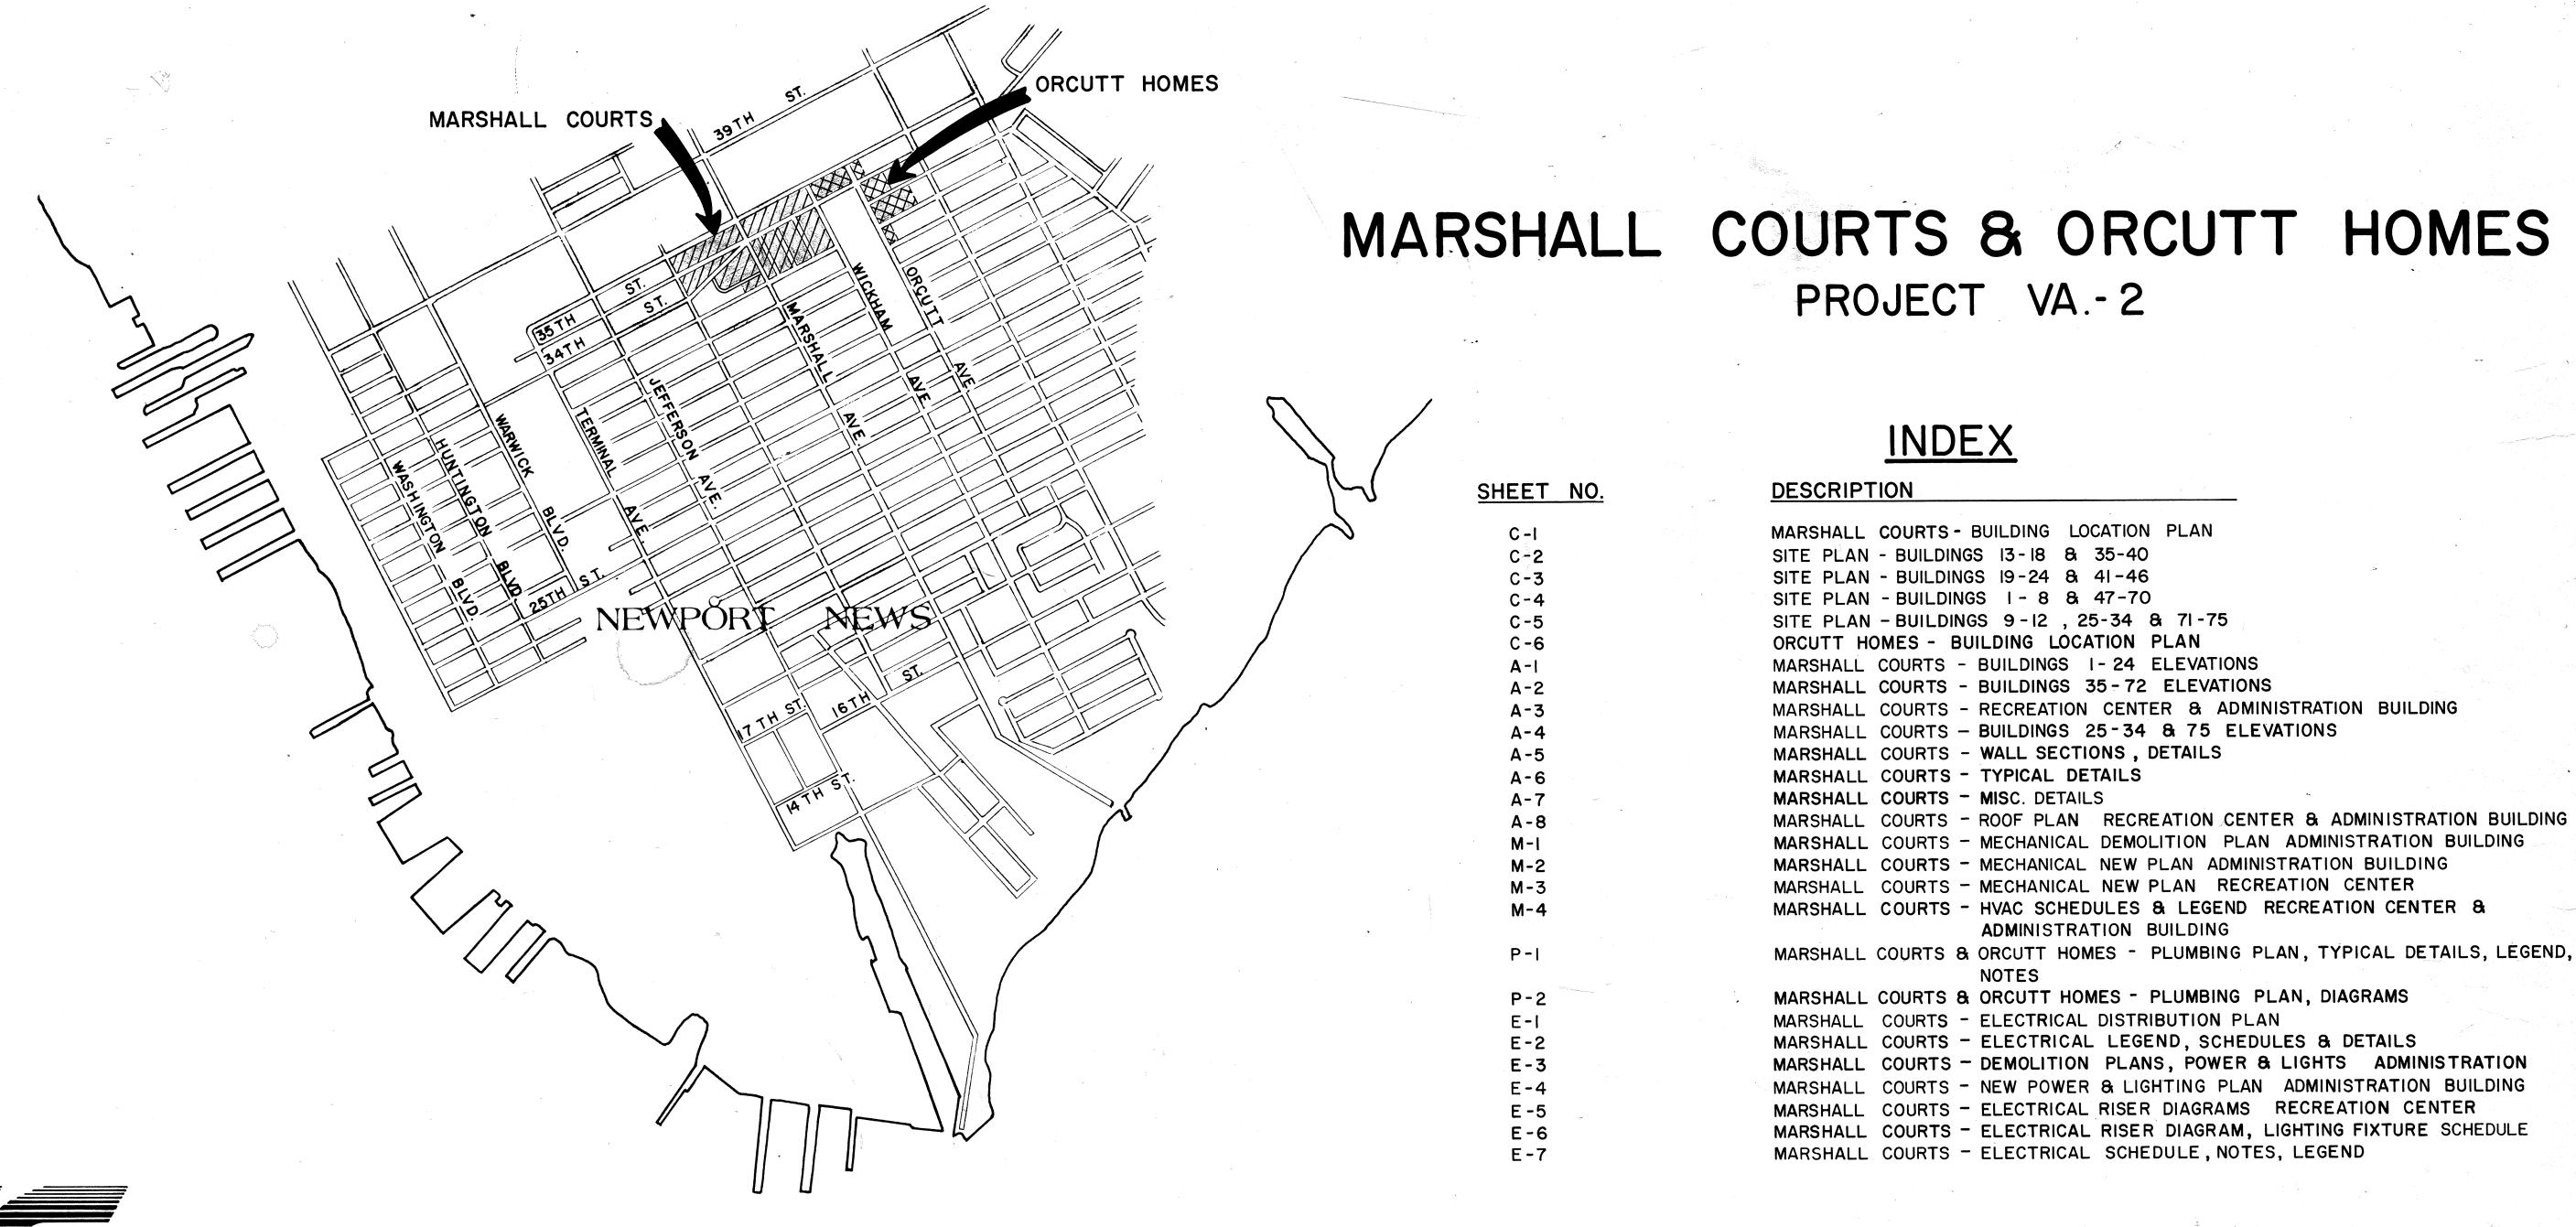
PIERRE GHENT AND ASSOCIATES.
WAS HINGTON, D. C.

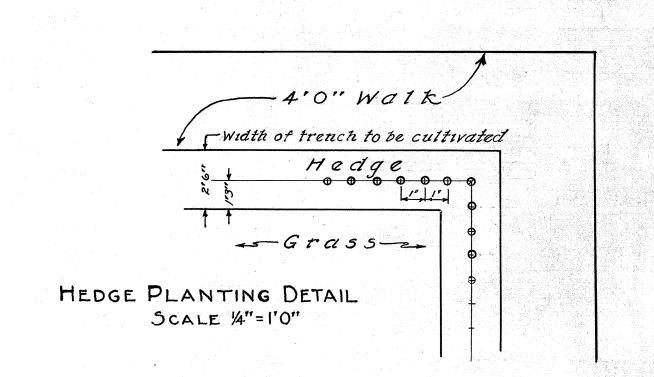

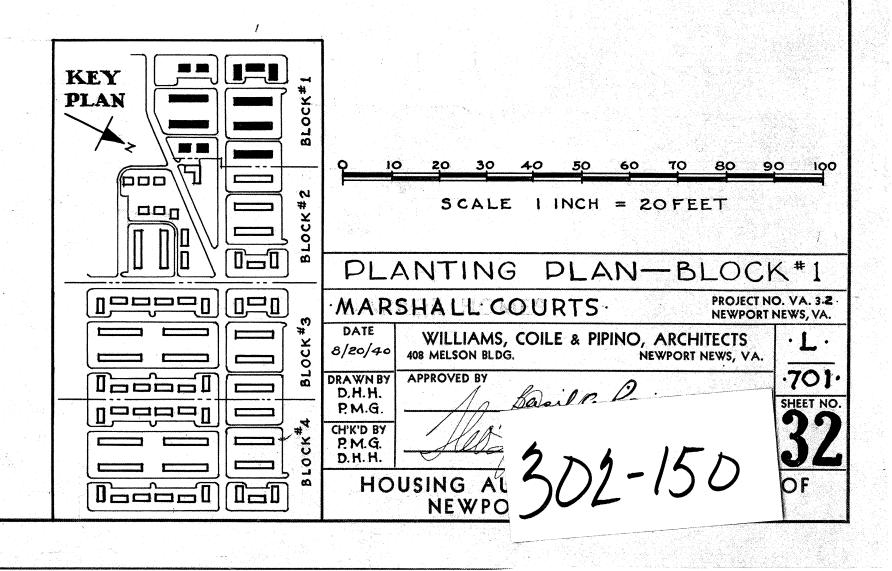

# Newport News Redevelopment and Housing Authority STRUCTURAL RENOVATIONS (PHASE II)

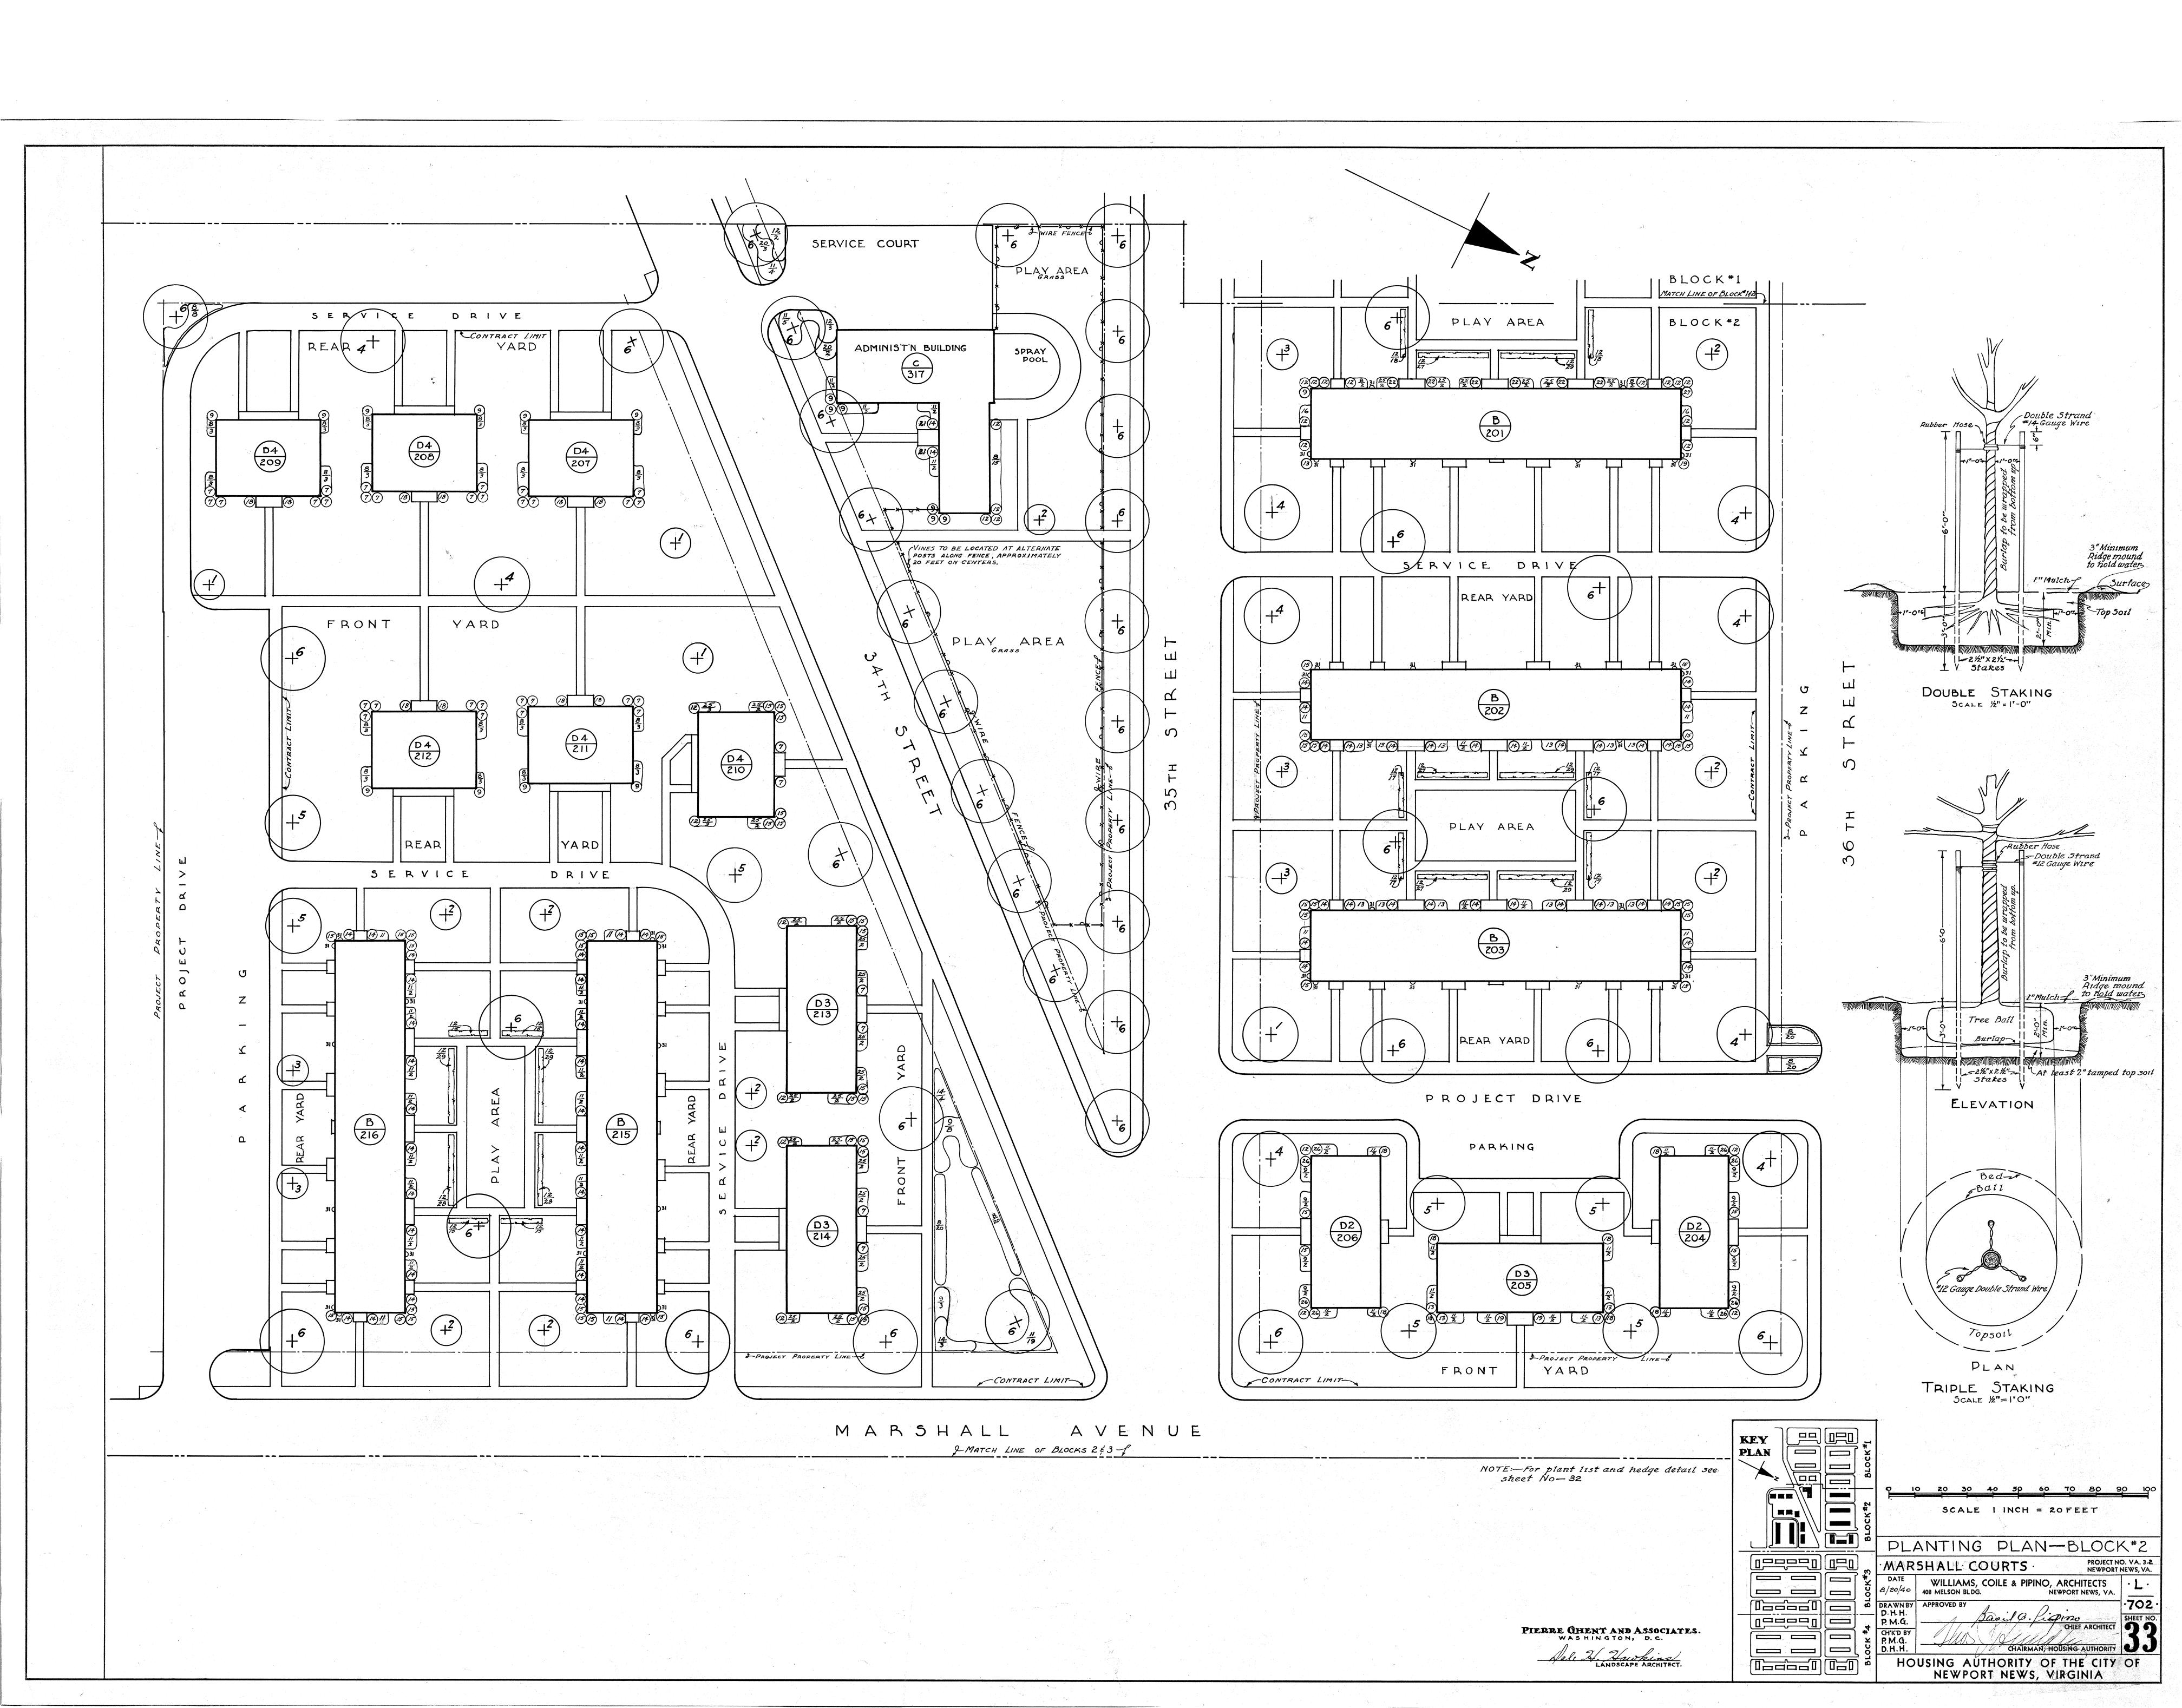Newport News, Virginia

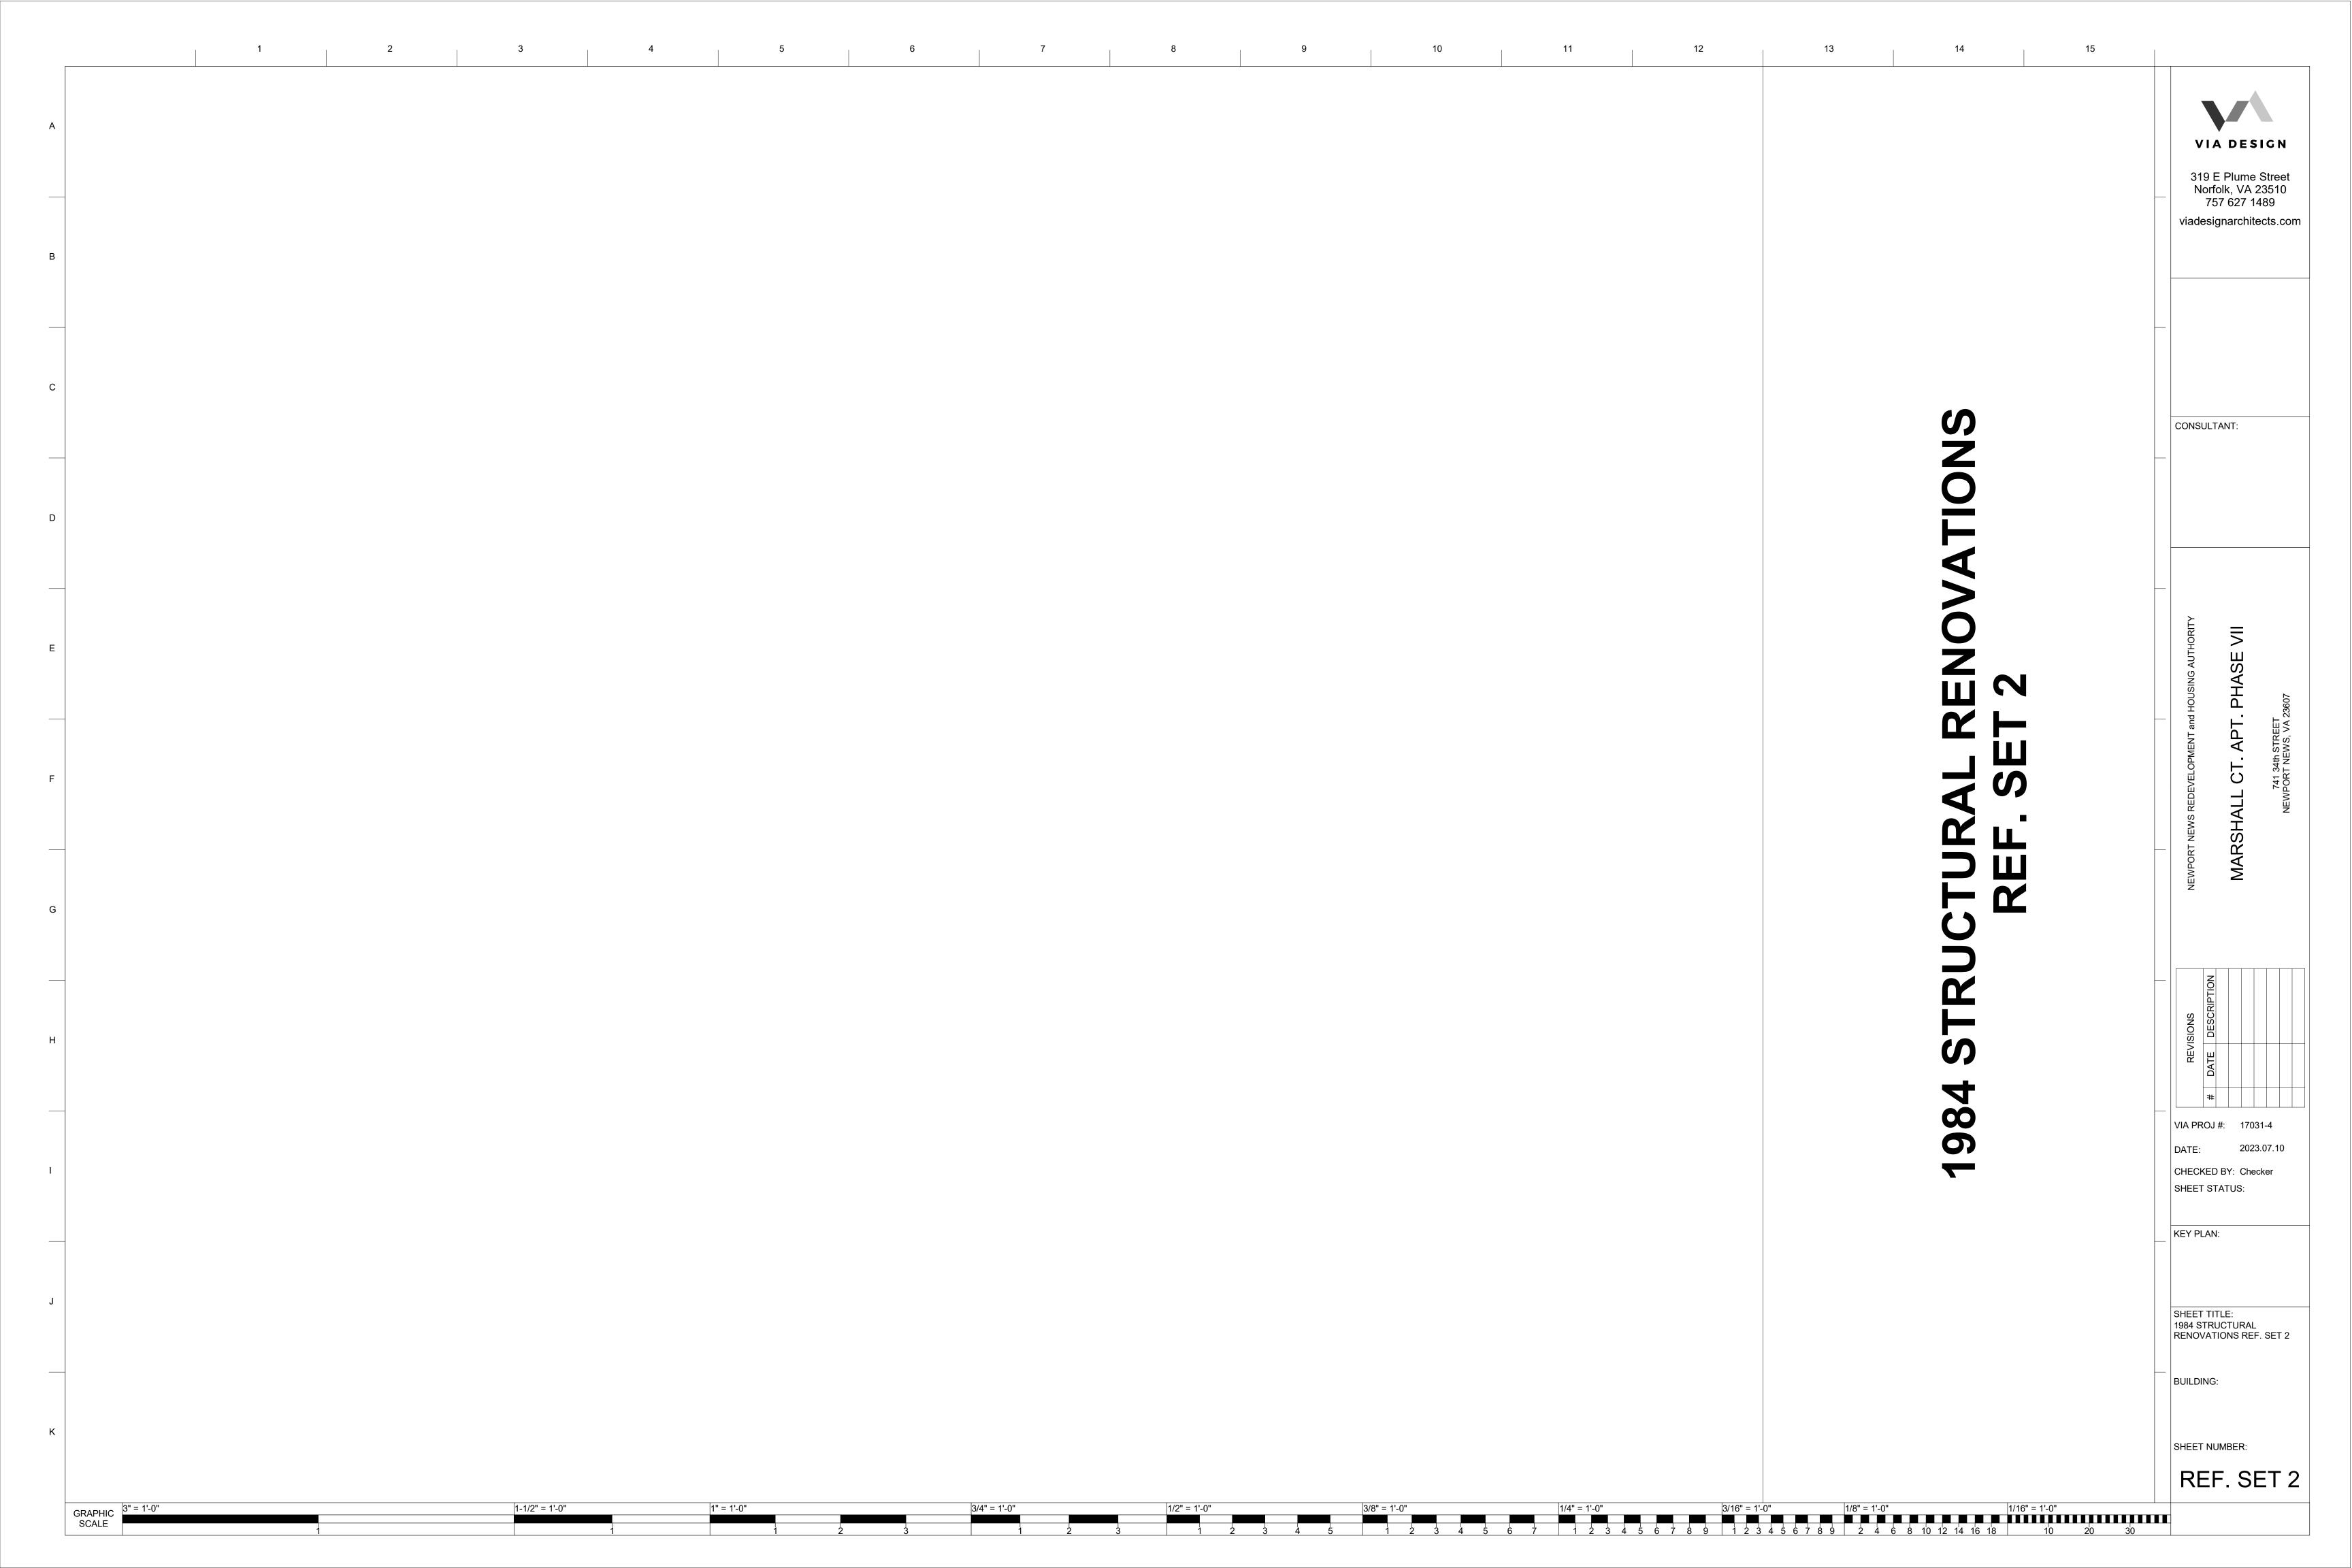



# THE DeYOUNG JOHNSON GROUP INC.


ENGINEERS · ARCHITECTS · SURVEYORS P.O. BOX 197 WILLIAMSBURG, VIRGINIA 23187 (804) 253-0673/(804) 874-5015


# CONSULTANT :


MATHEW J. THOMPSON III CONSULTING ENGINEERS INC. / MECHANICAL NEWPORT NEWS, VIRGINIA Within Janes


Jacob Harring


SET #20

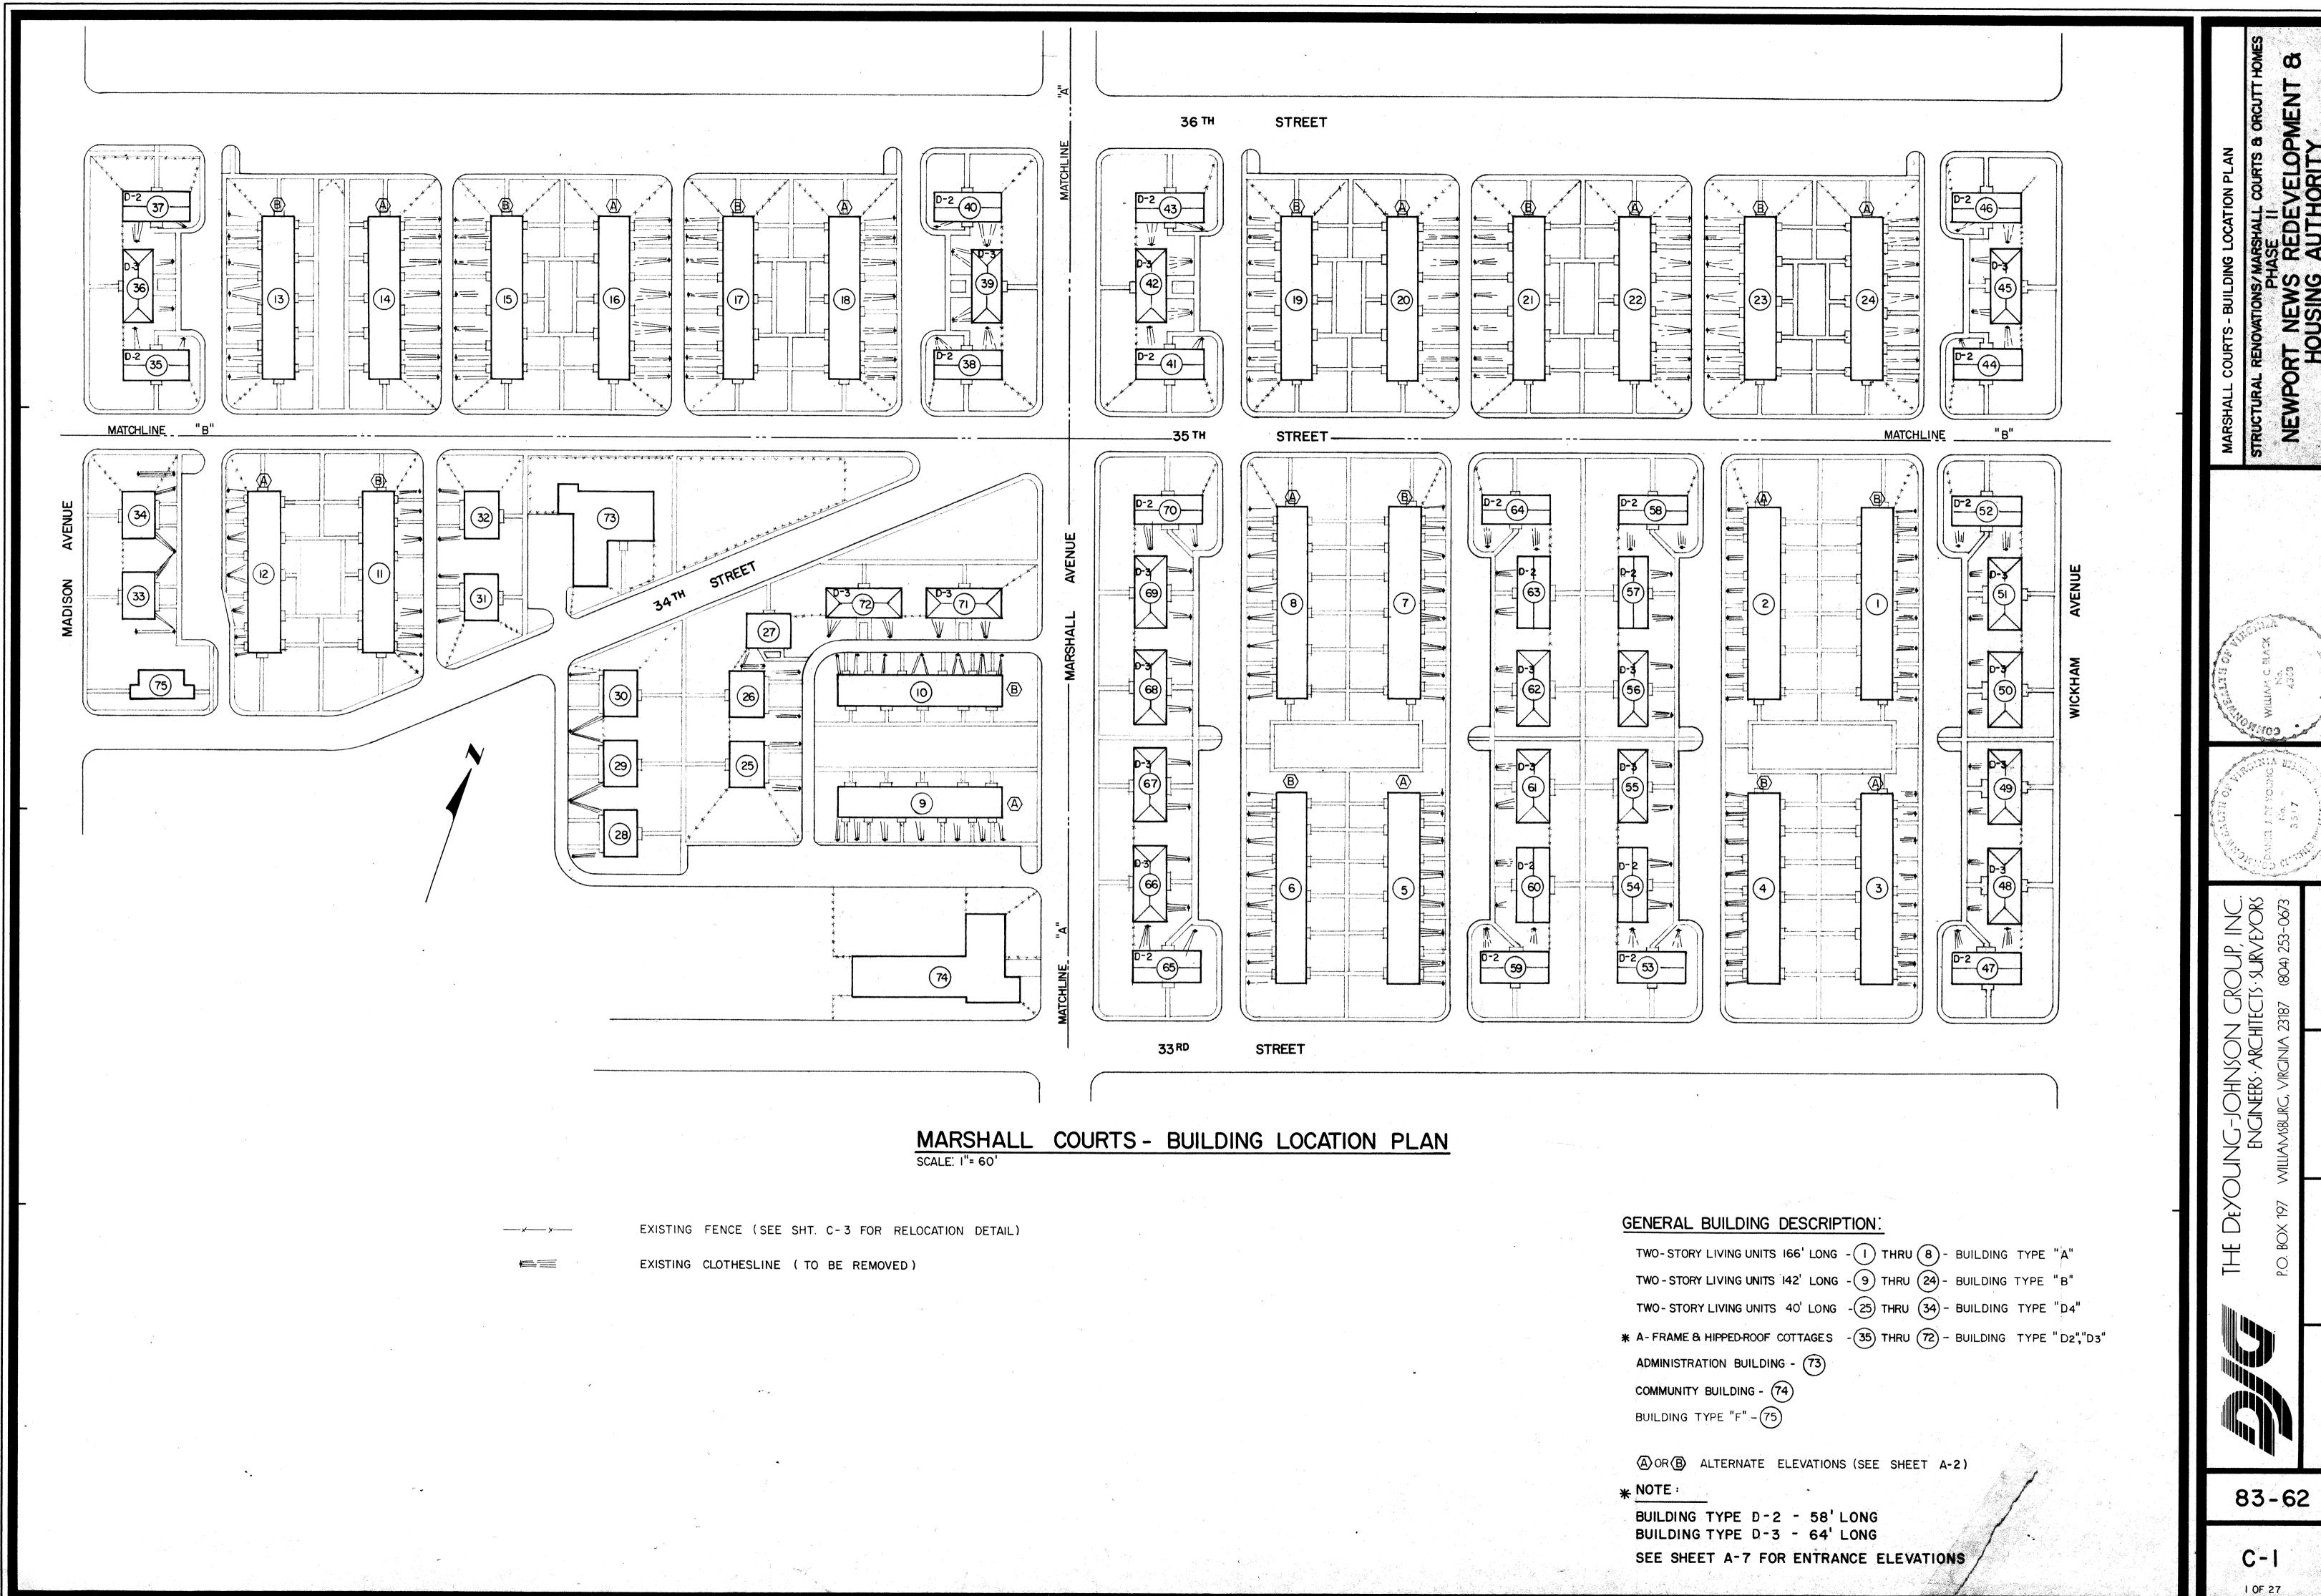


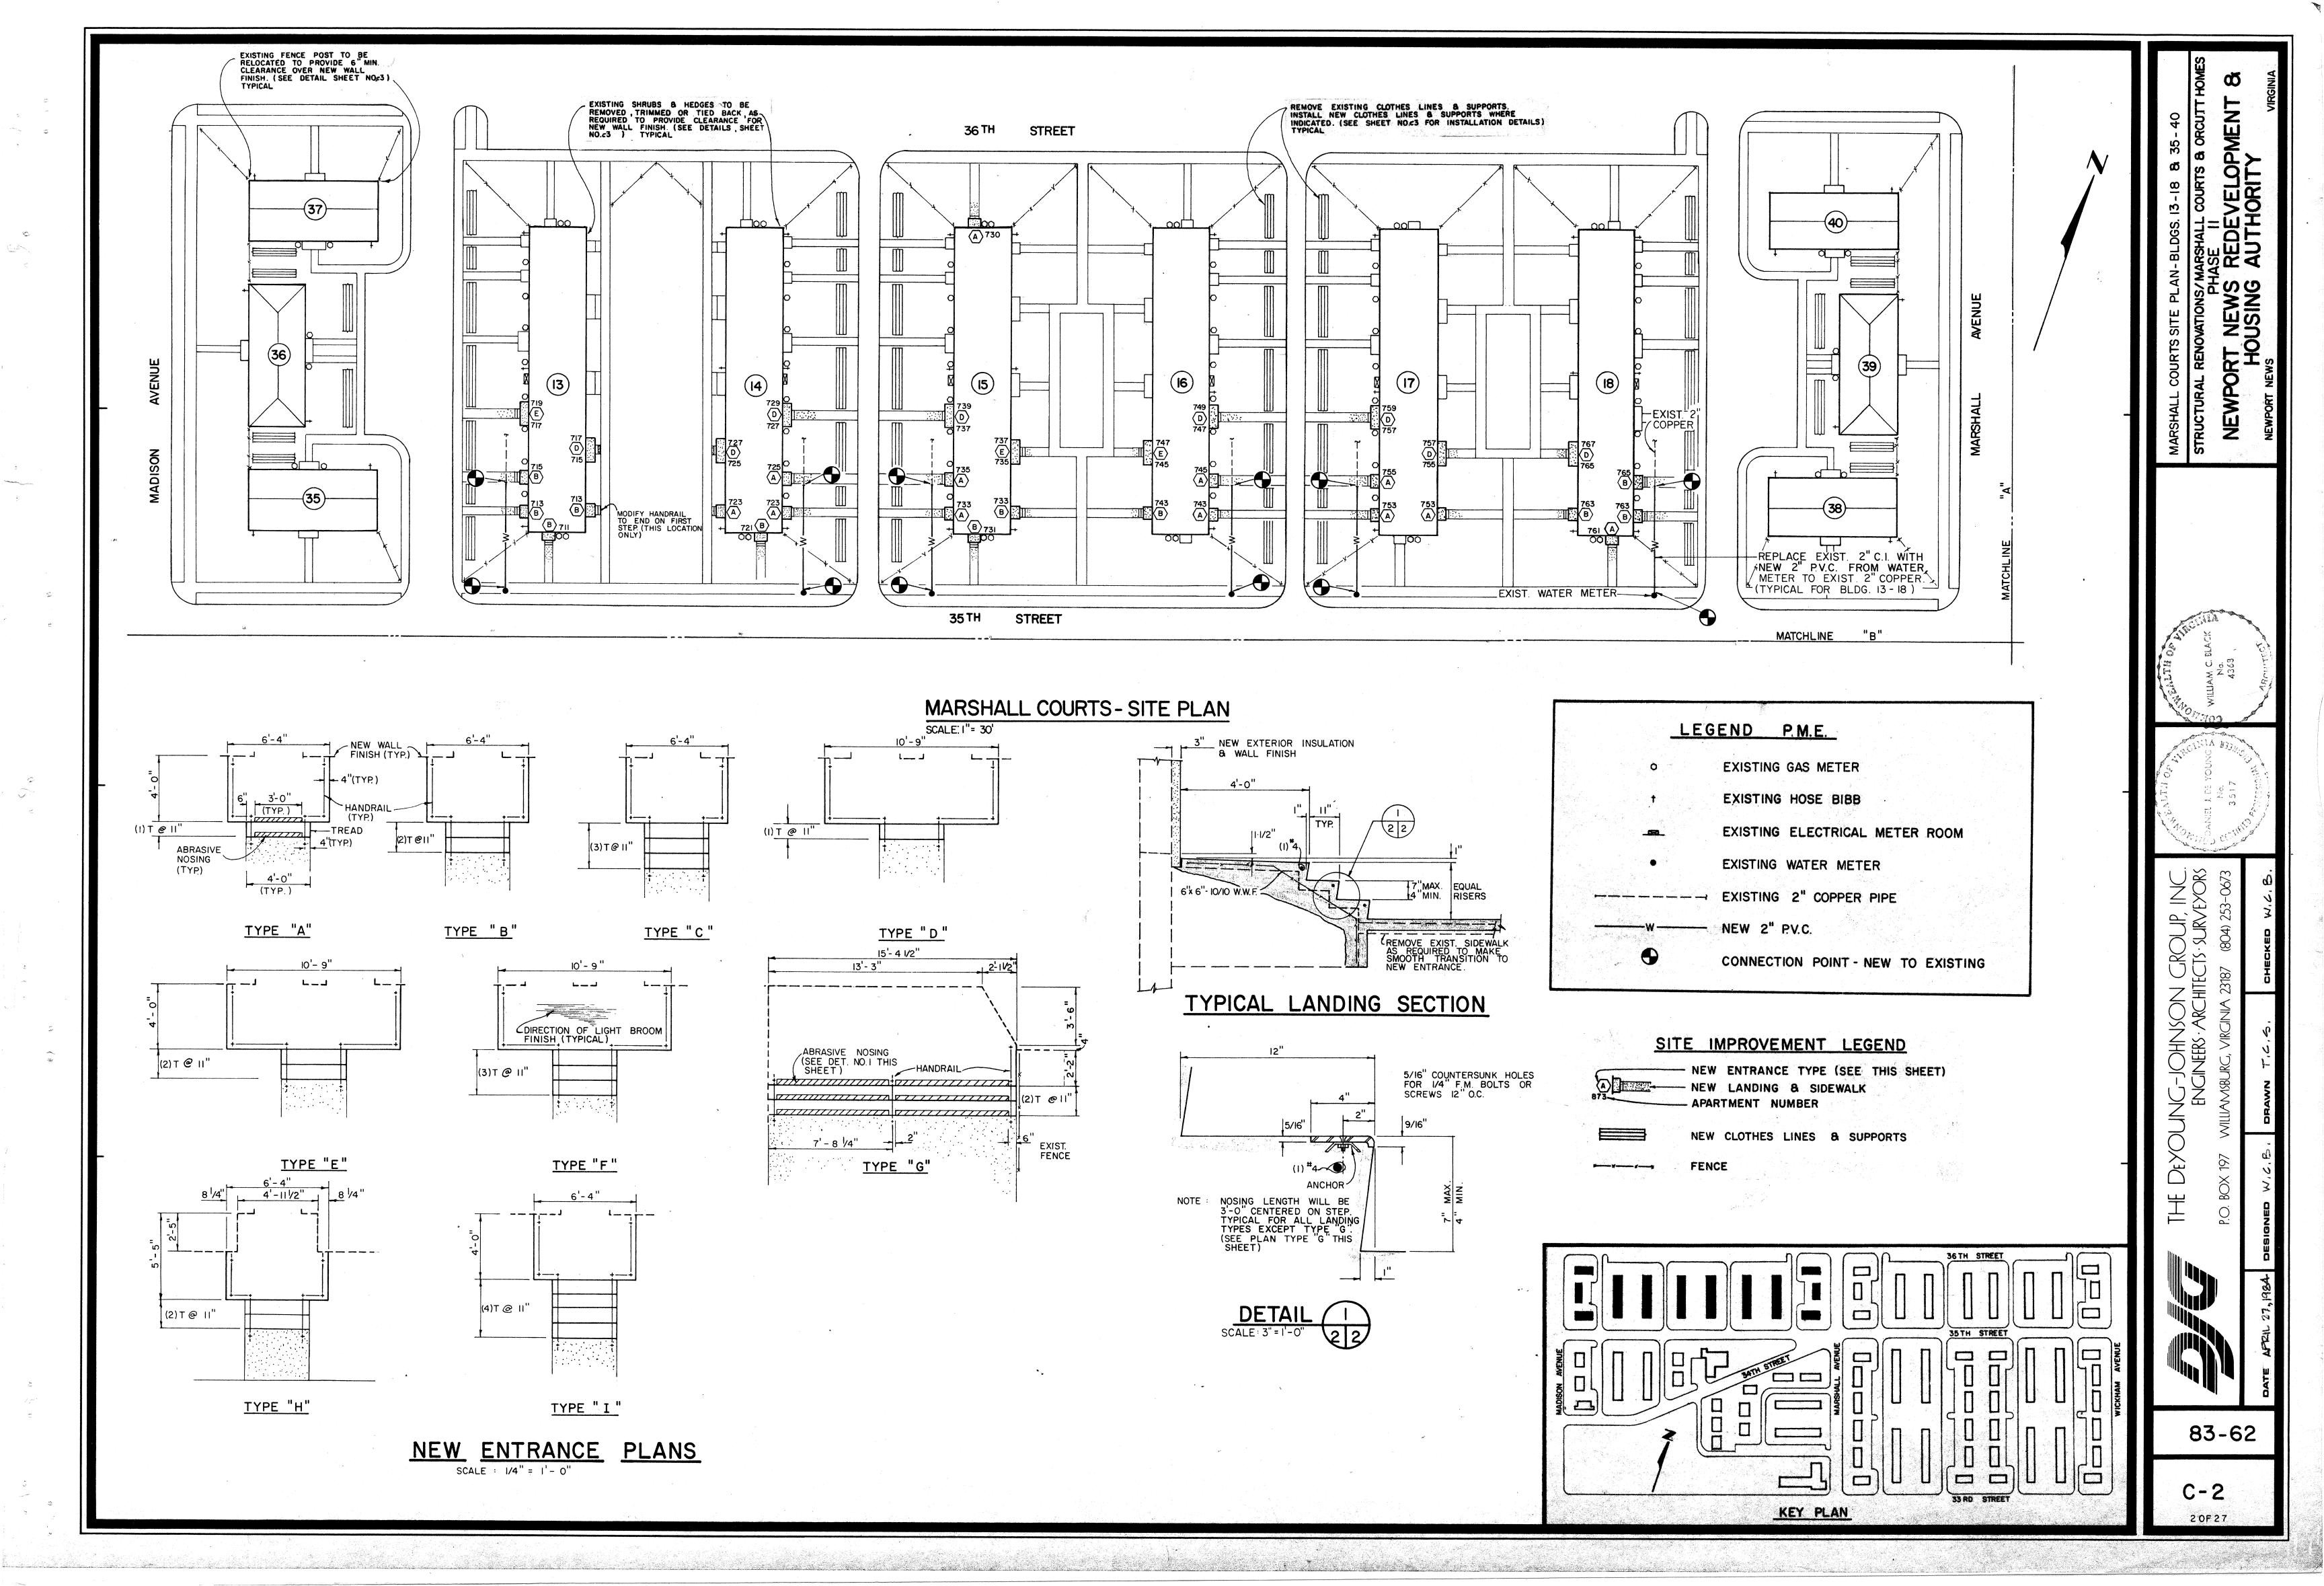

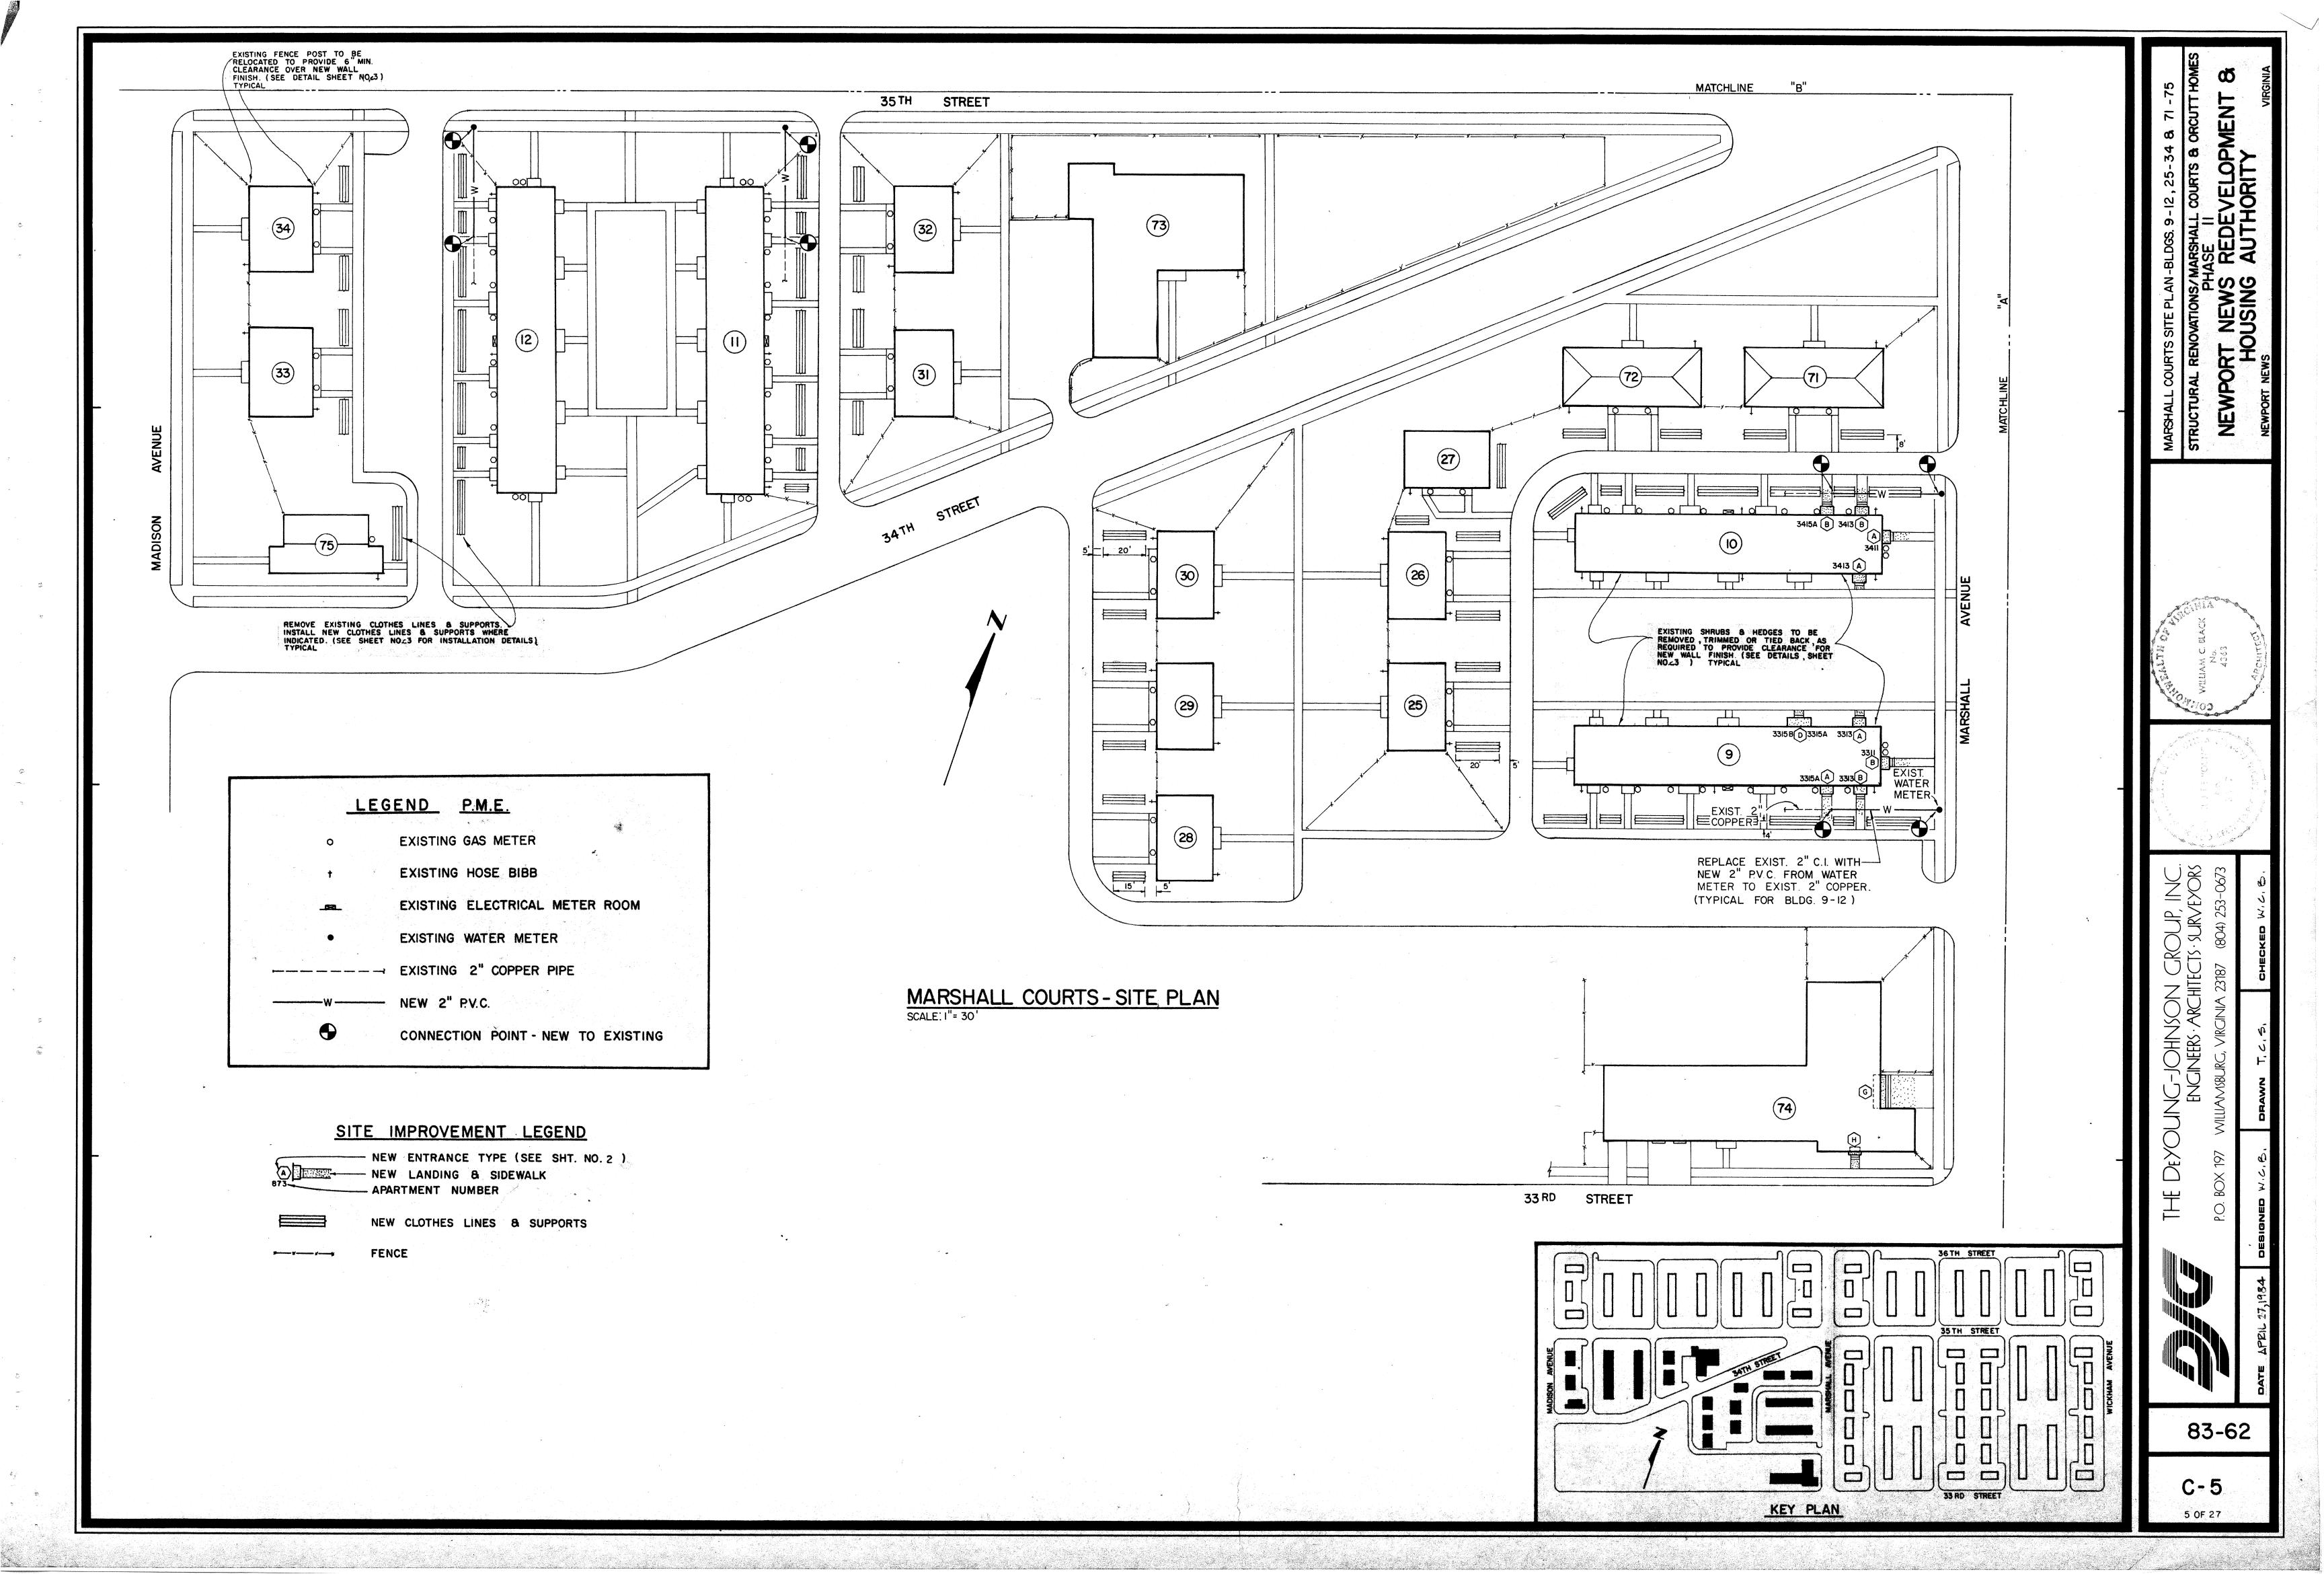

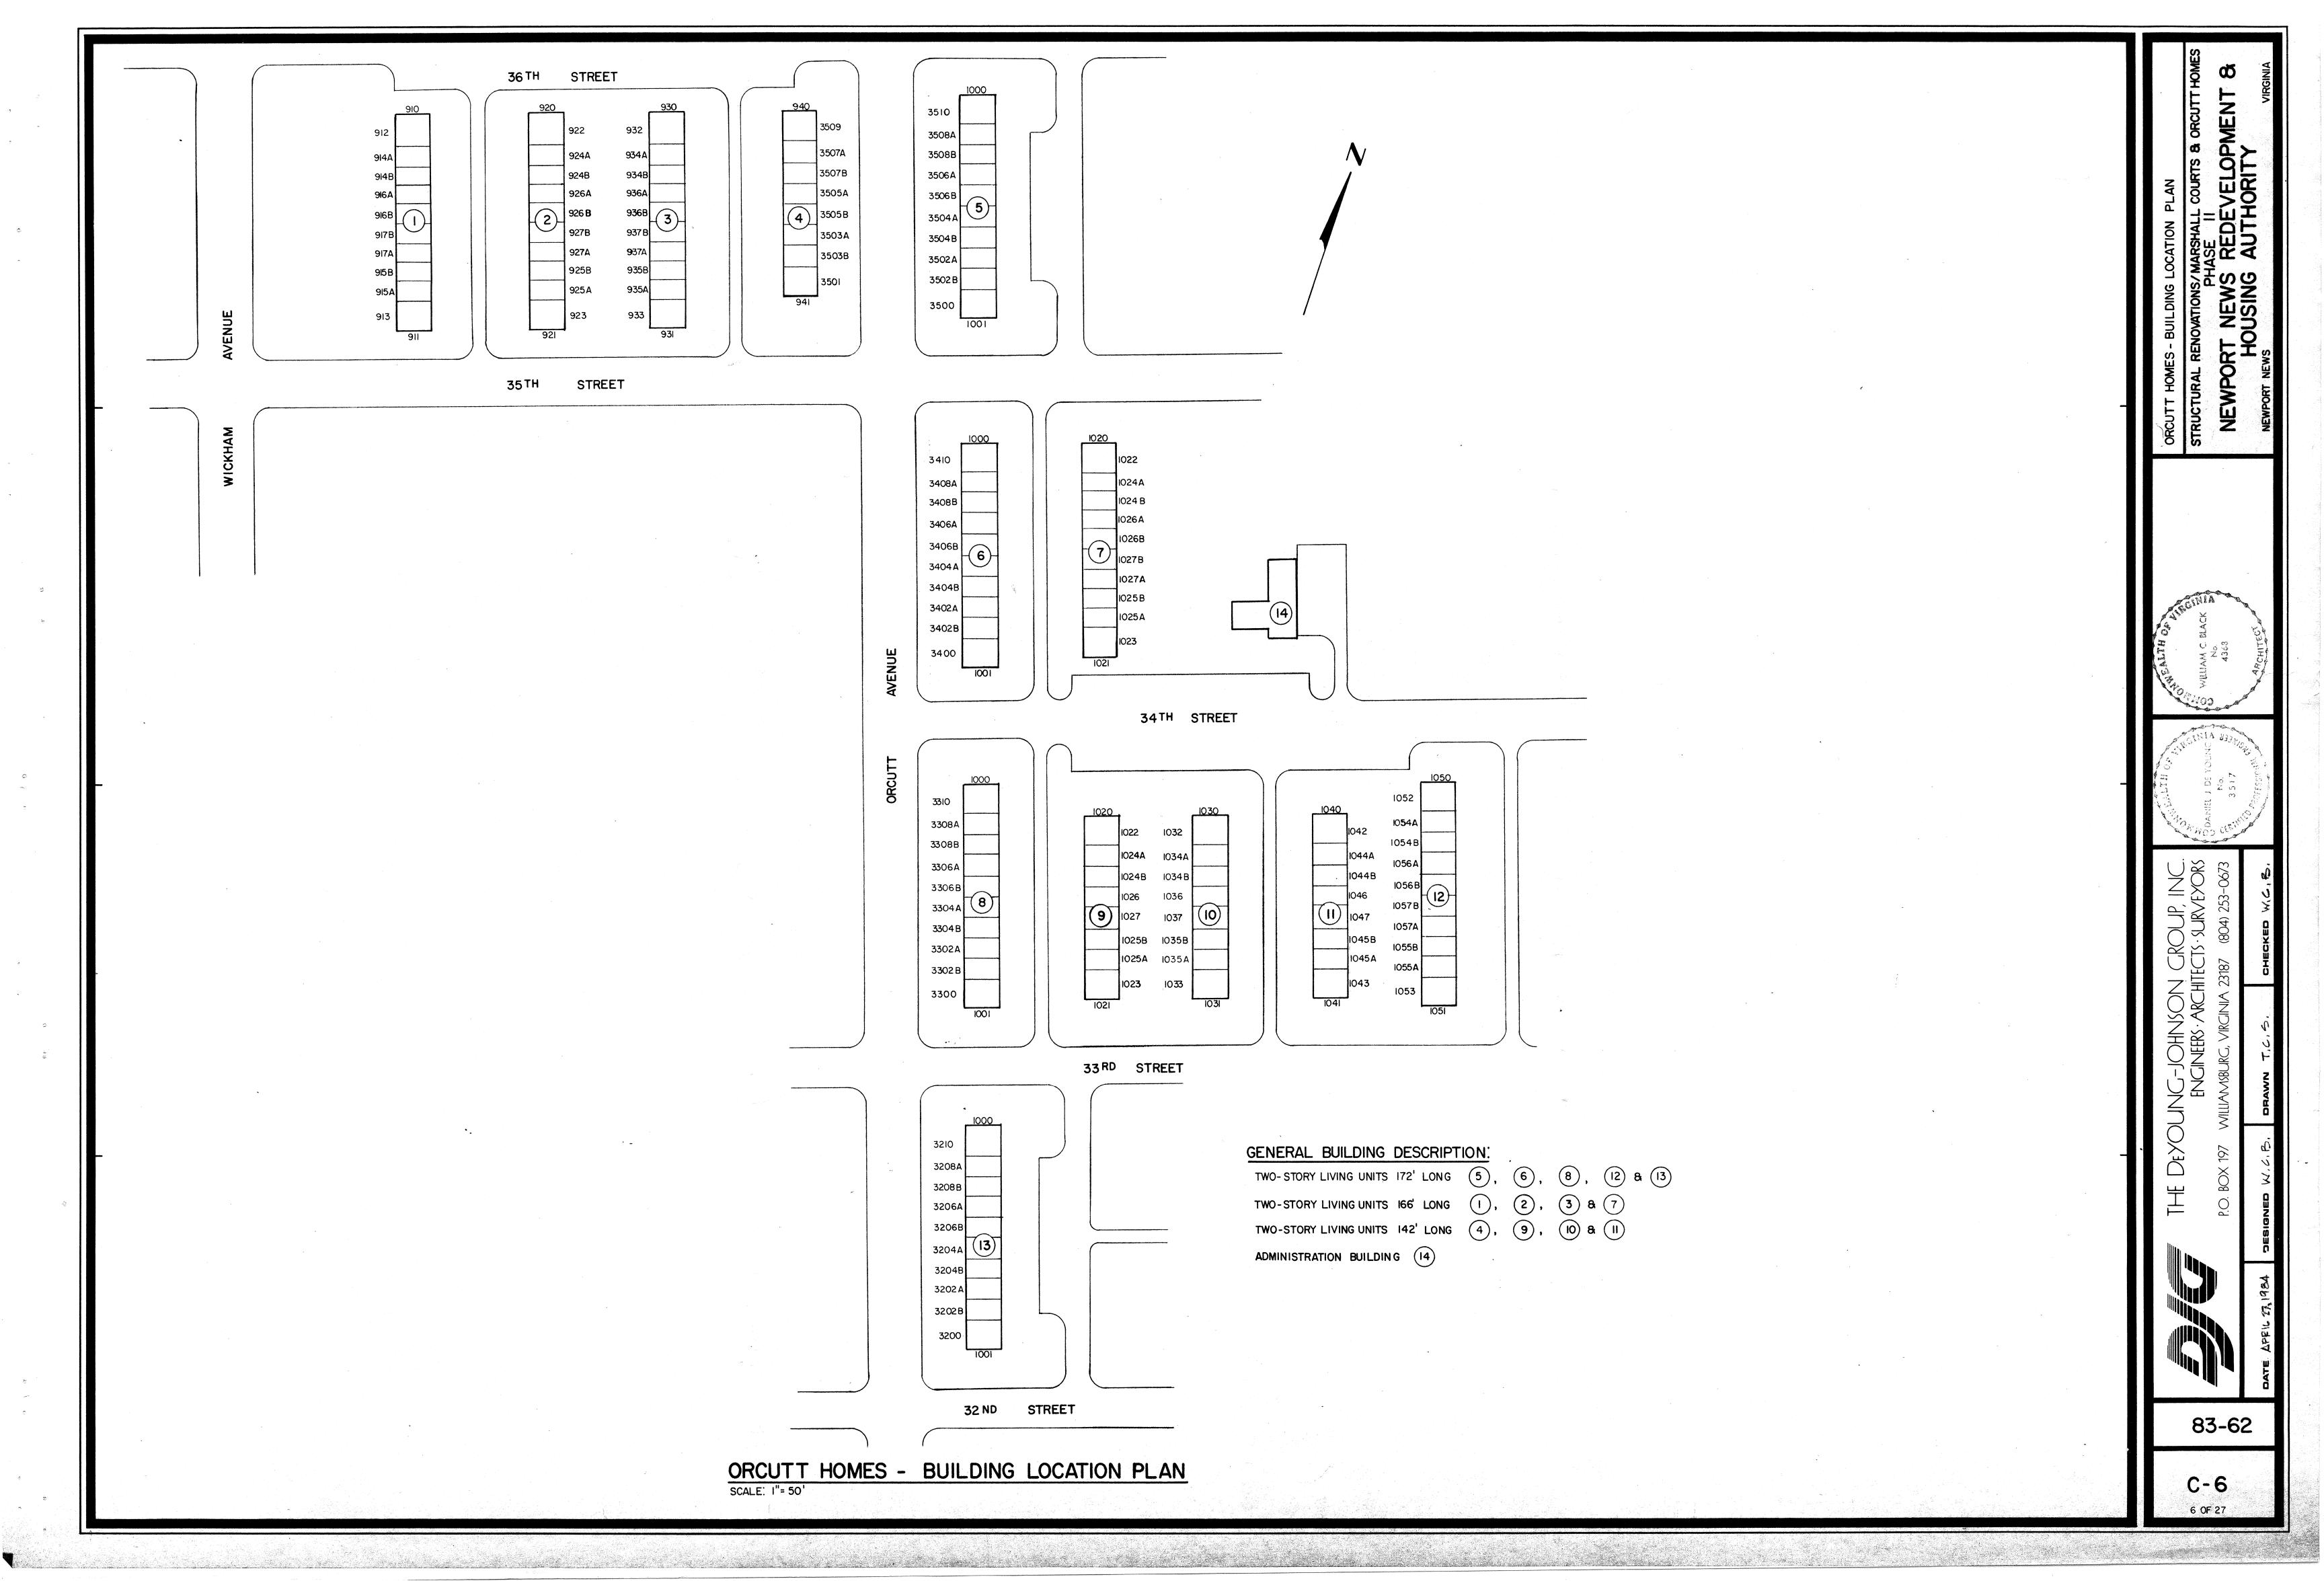

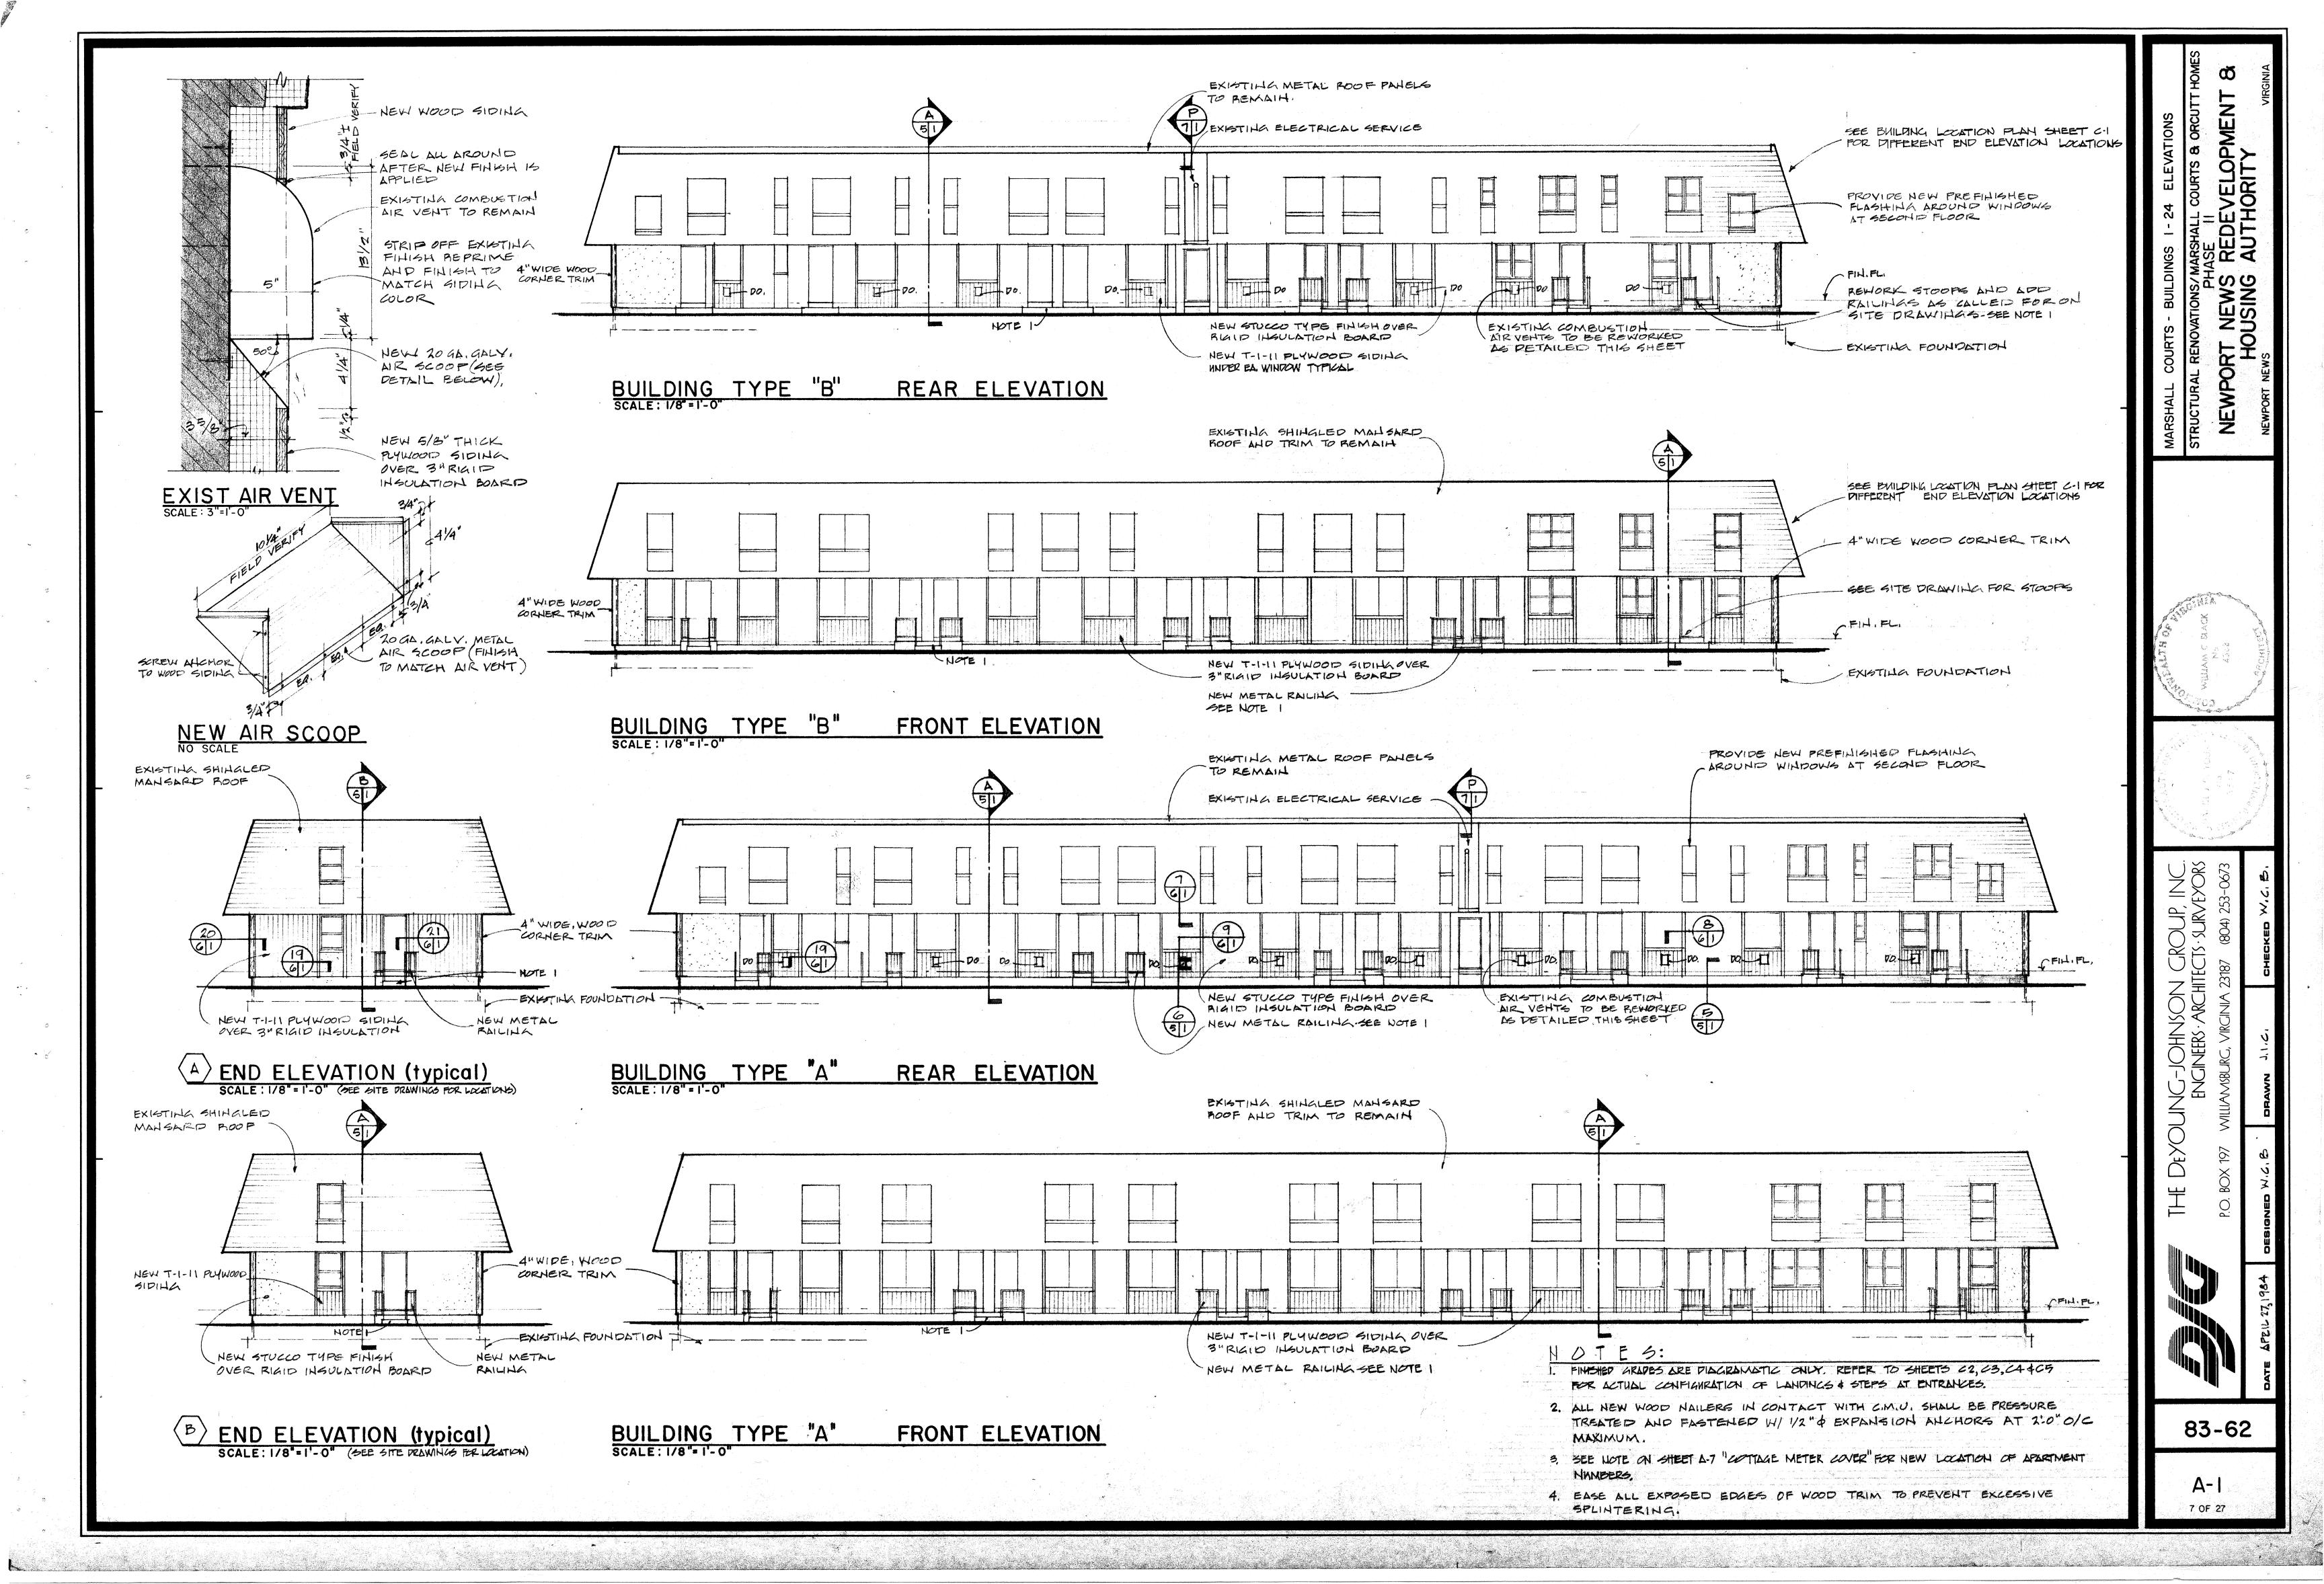


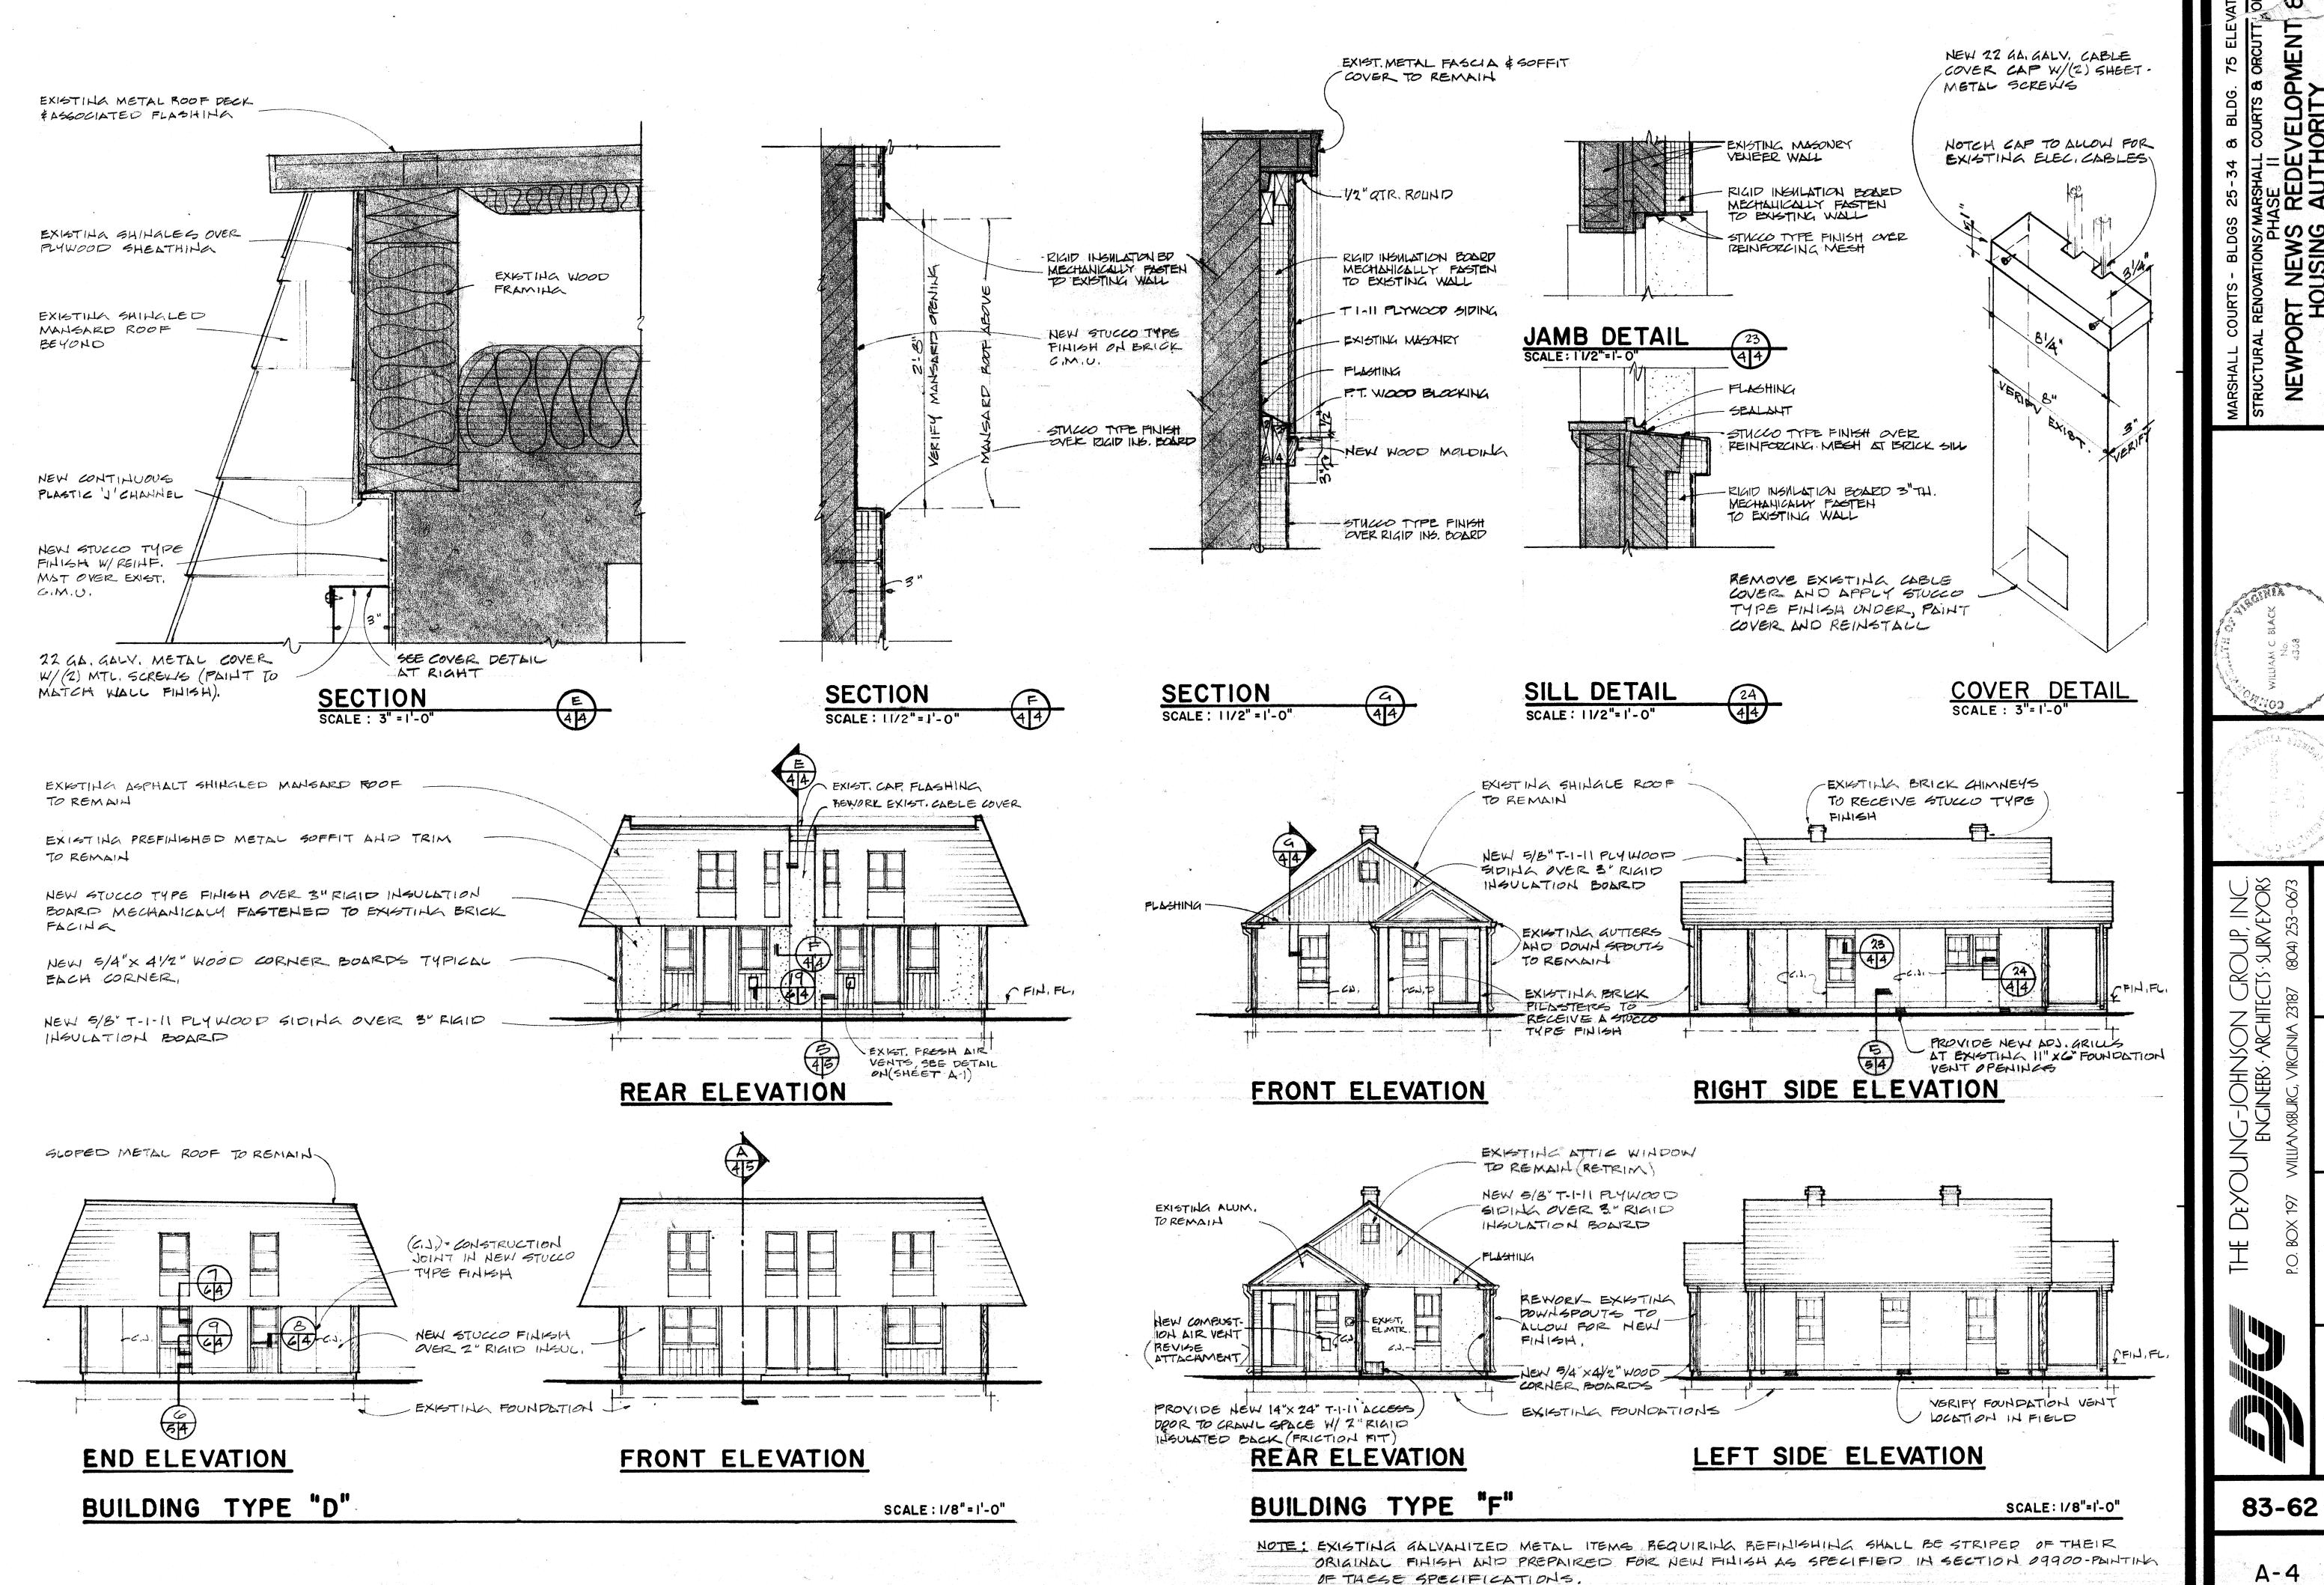

A-410 OF 27

REDEVELOPA NUTHORITY


ORT NEWS HOUSING

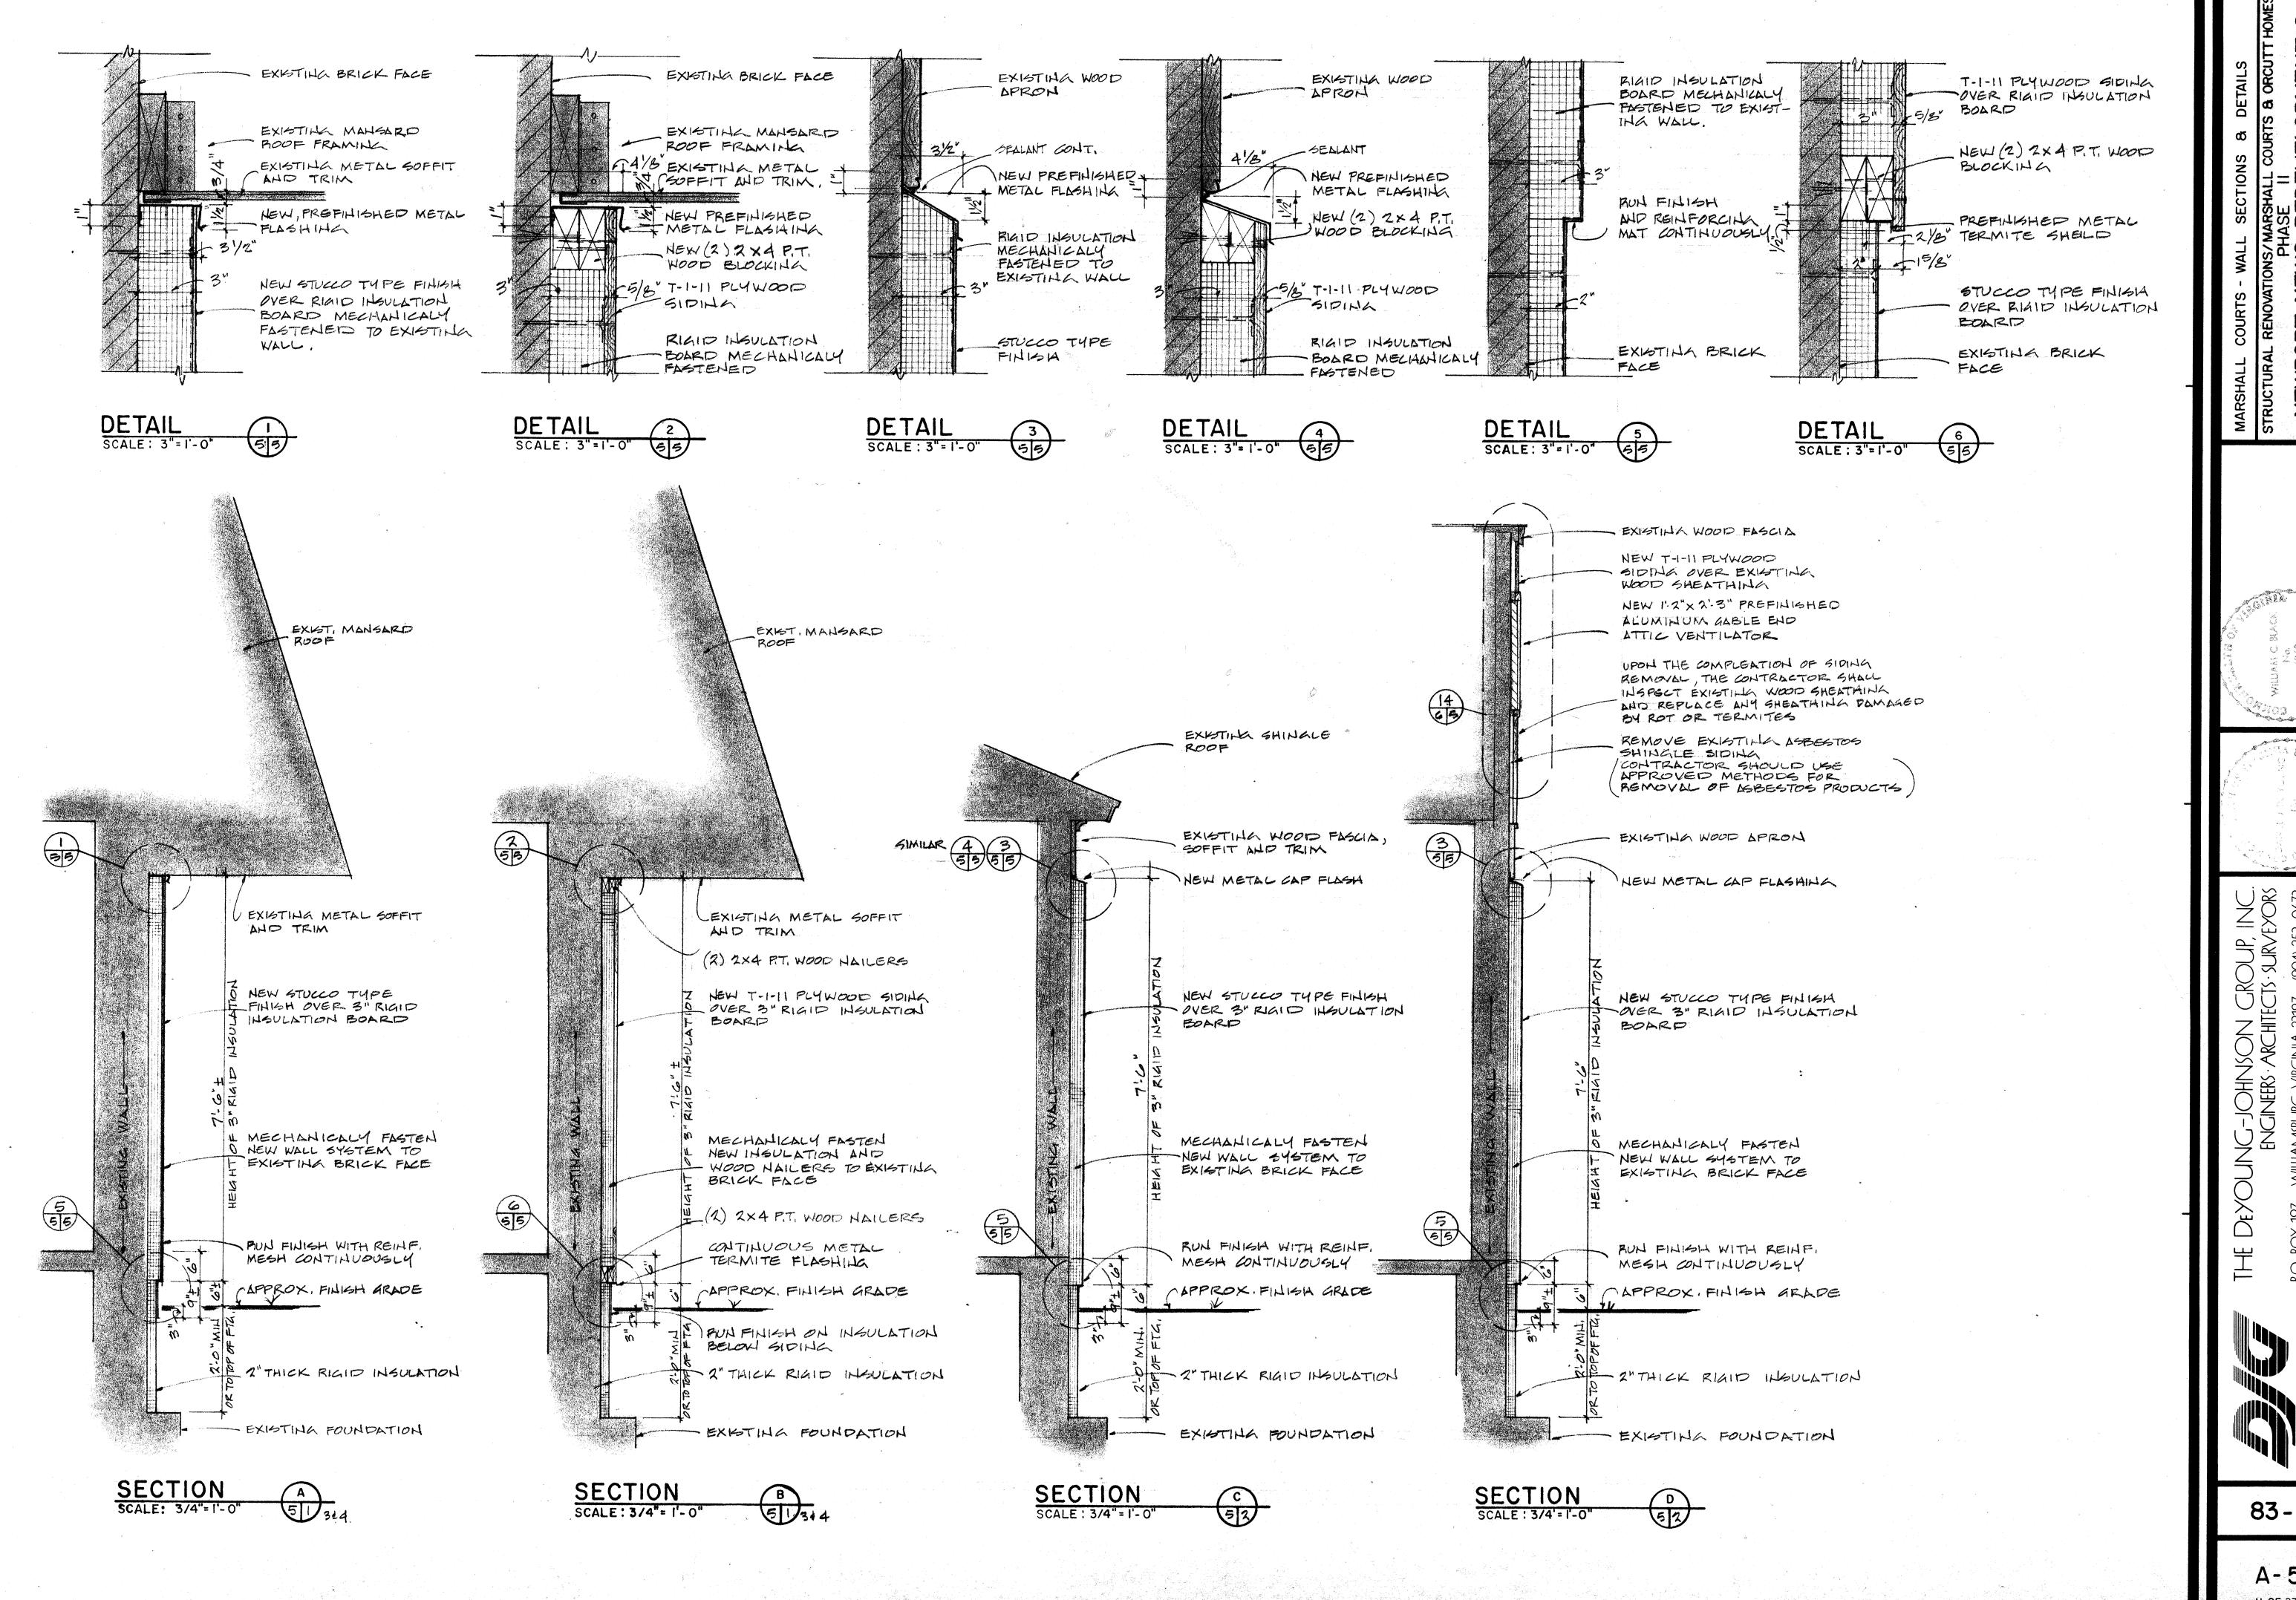



DEVELOR

83-62

11 OF 27

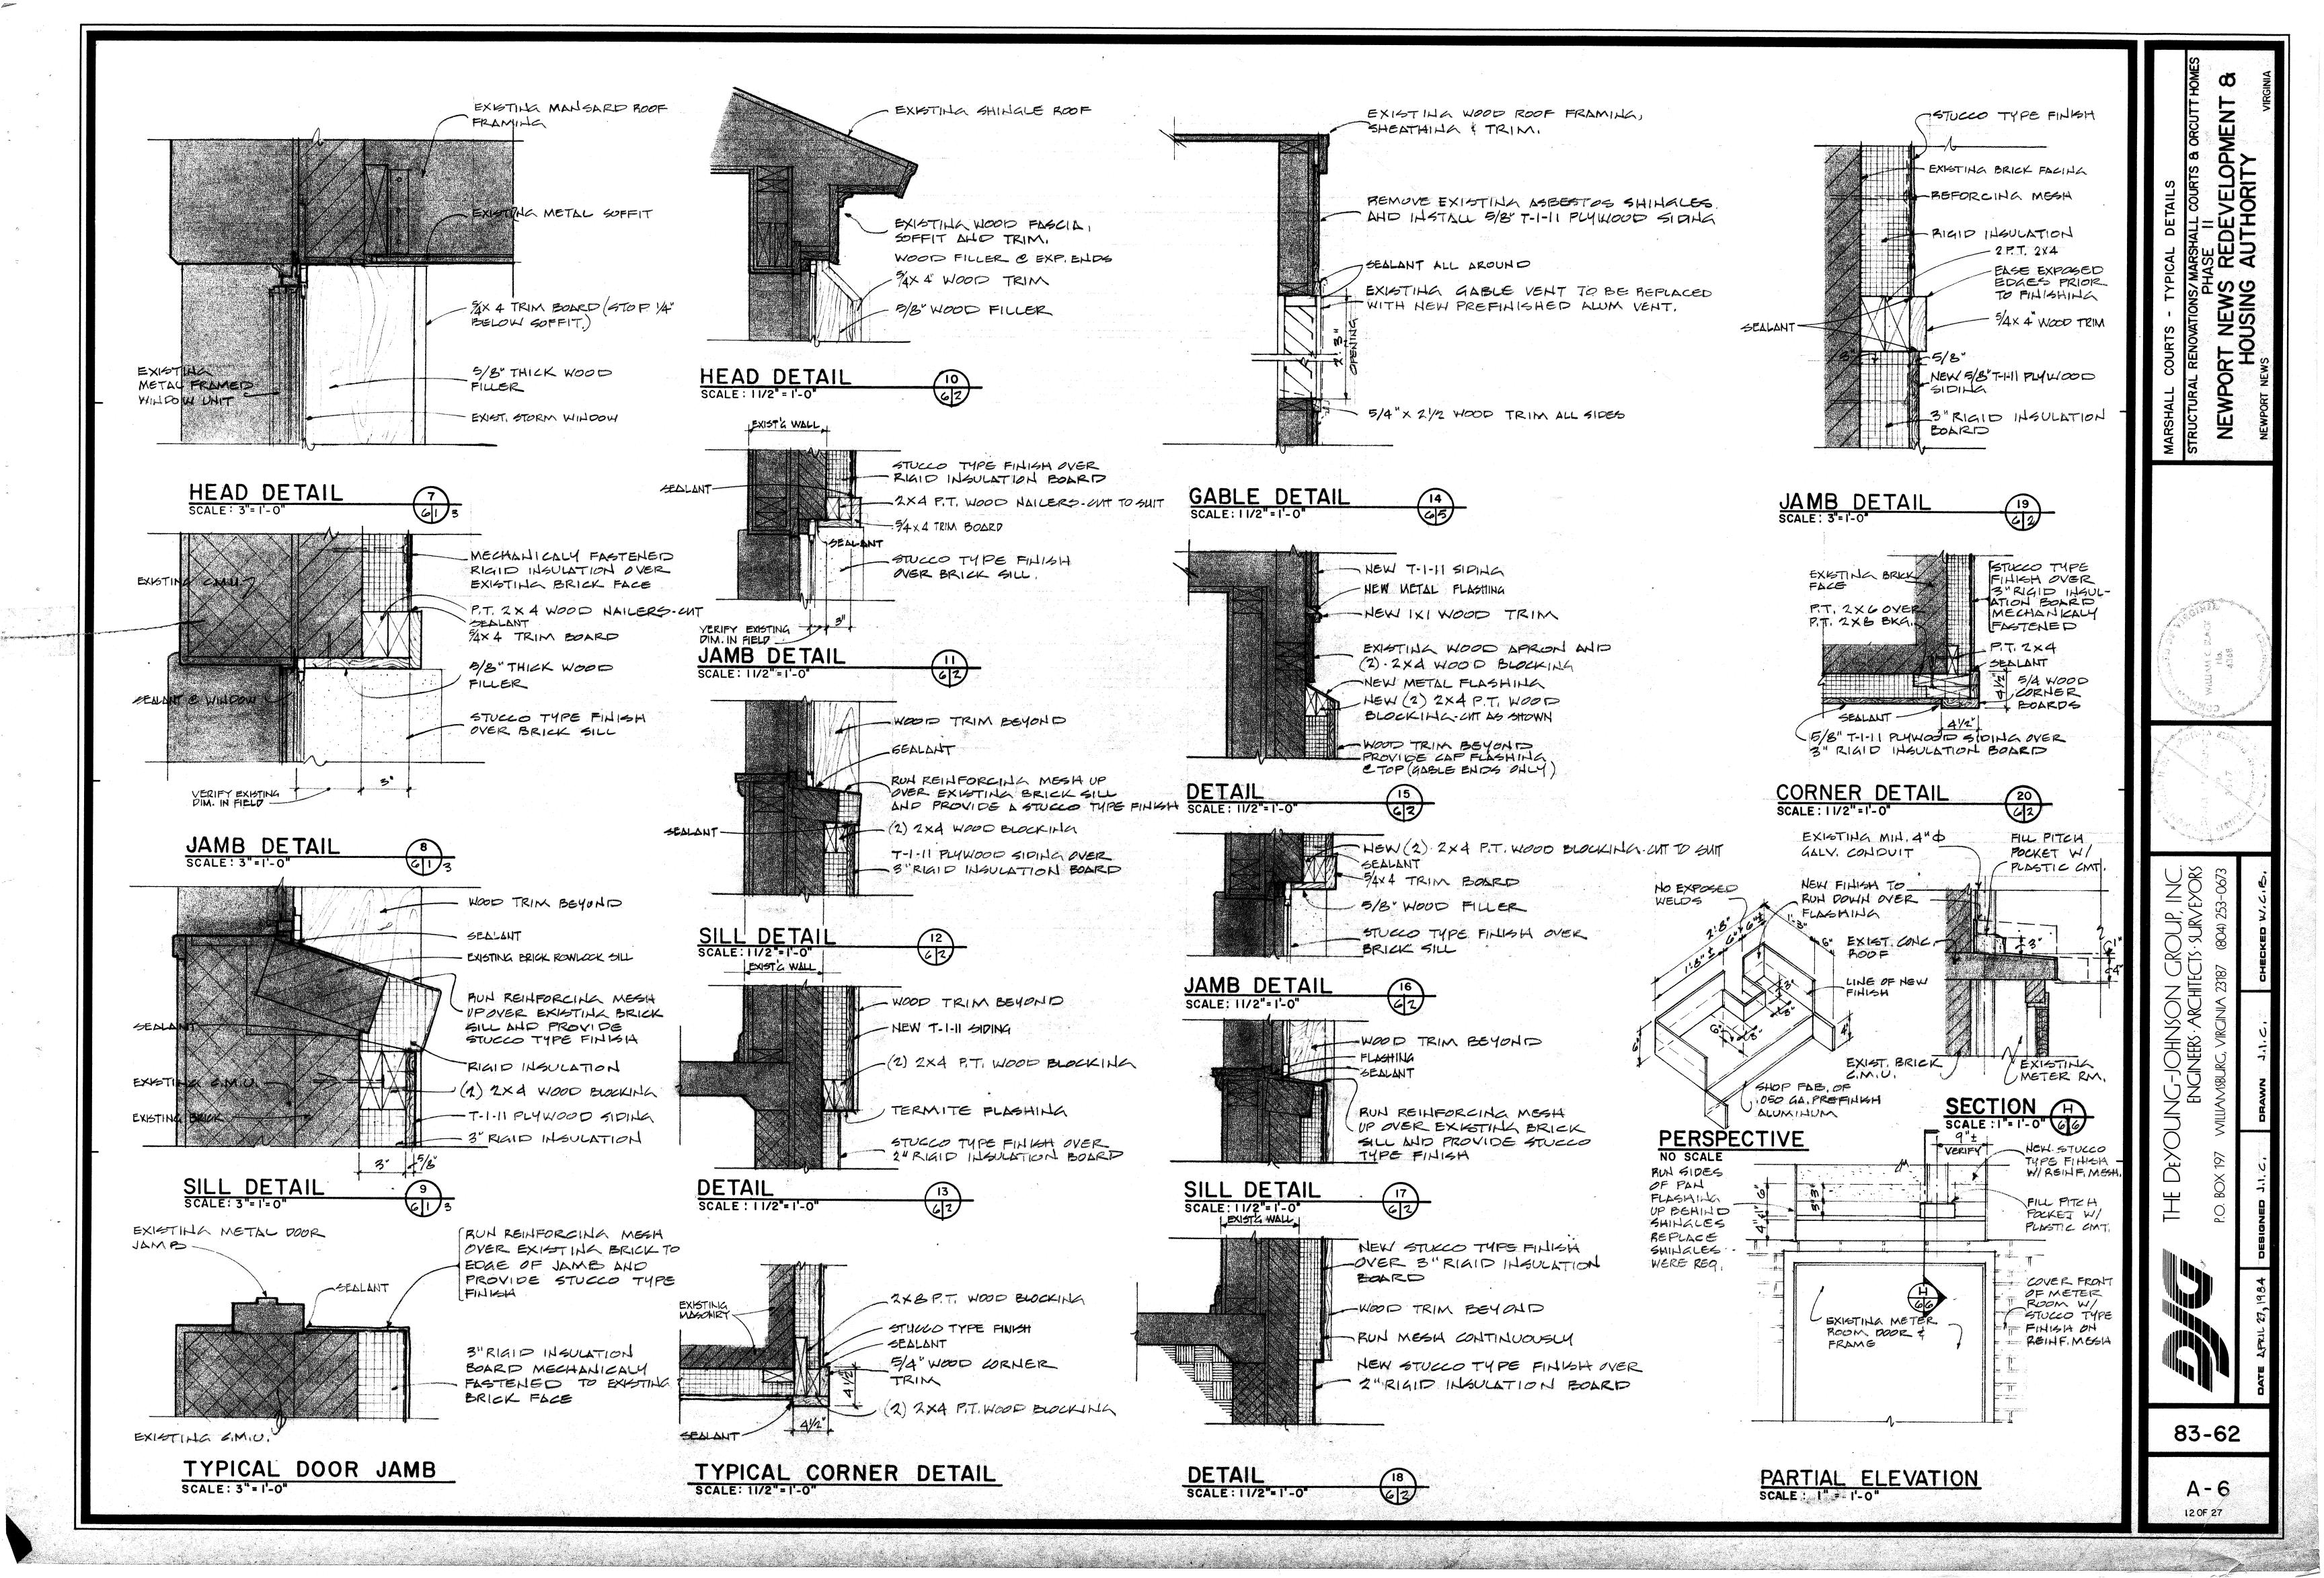

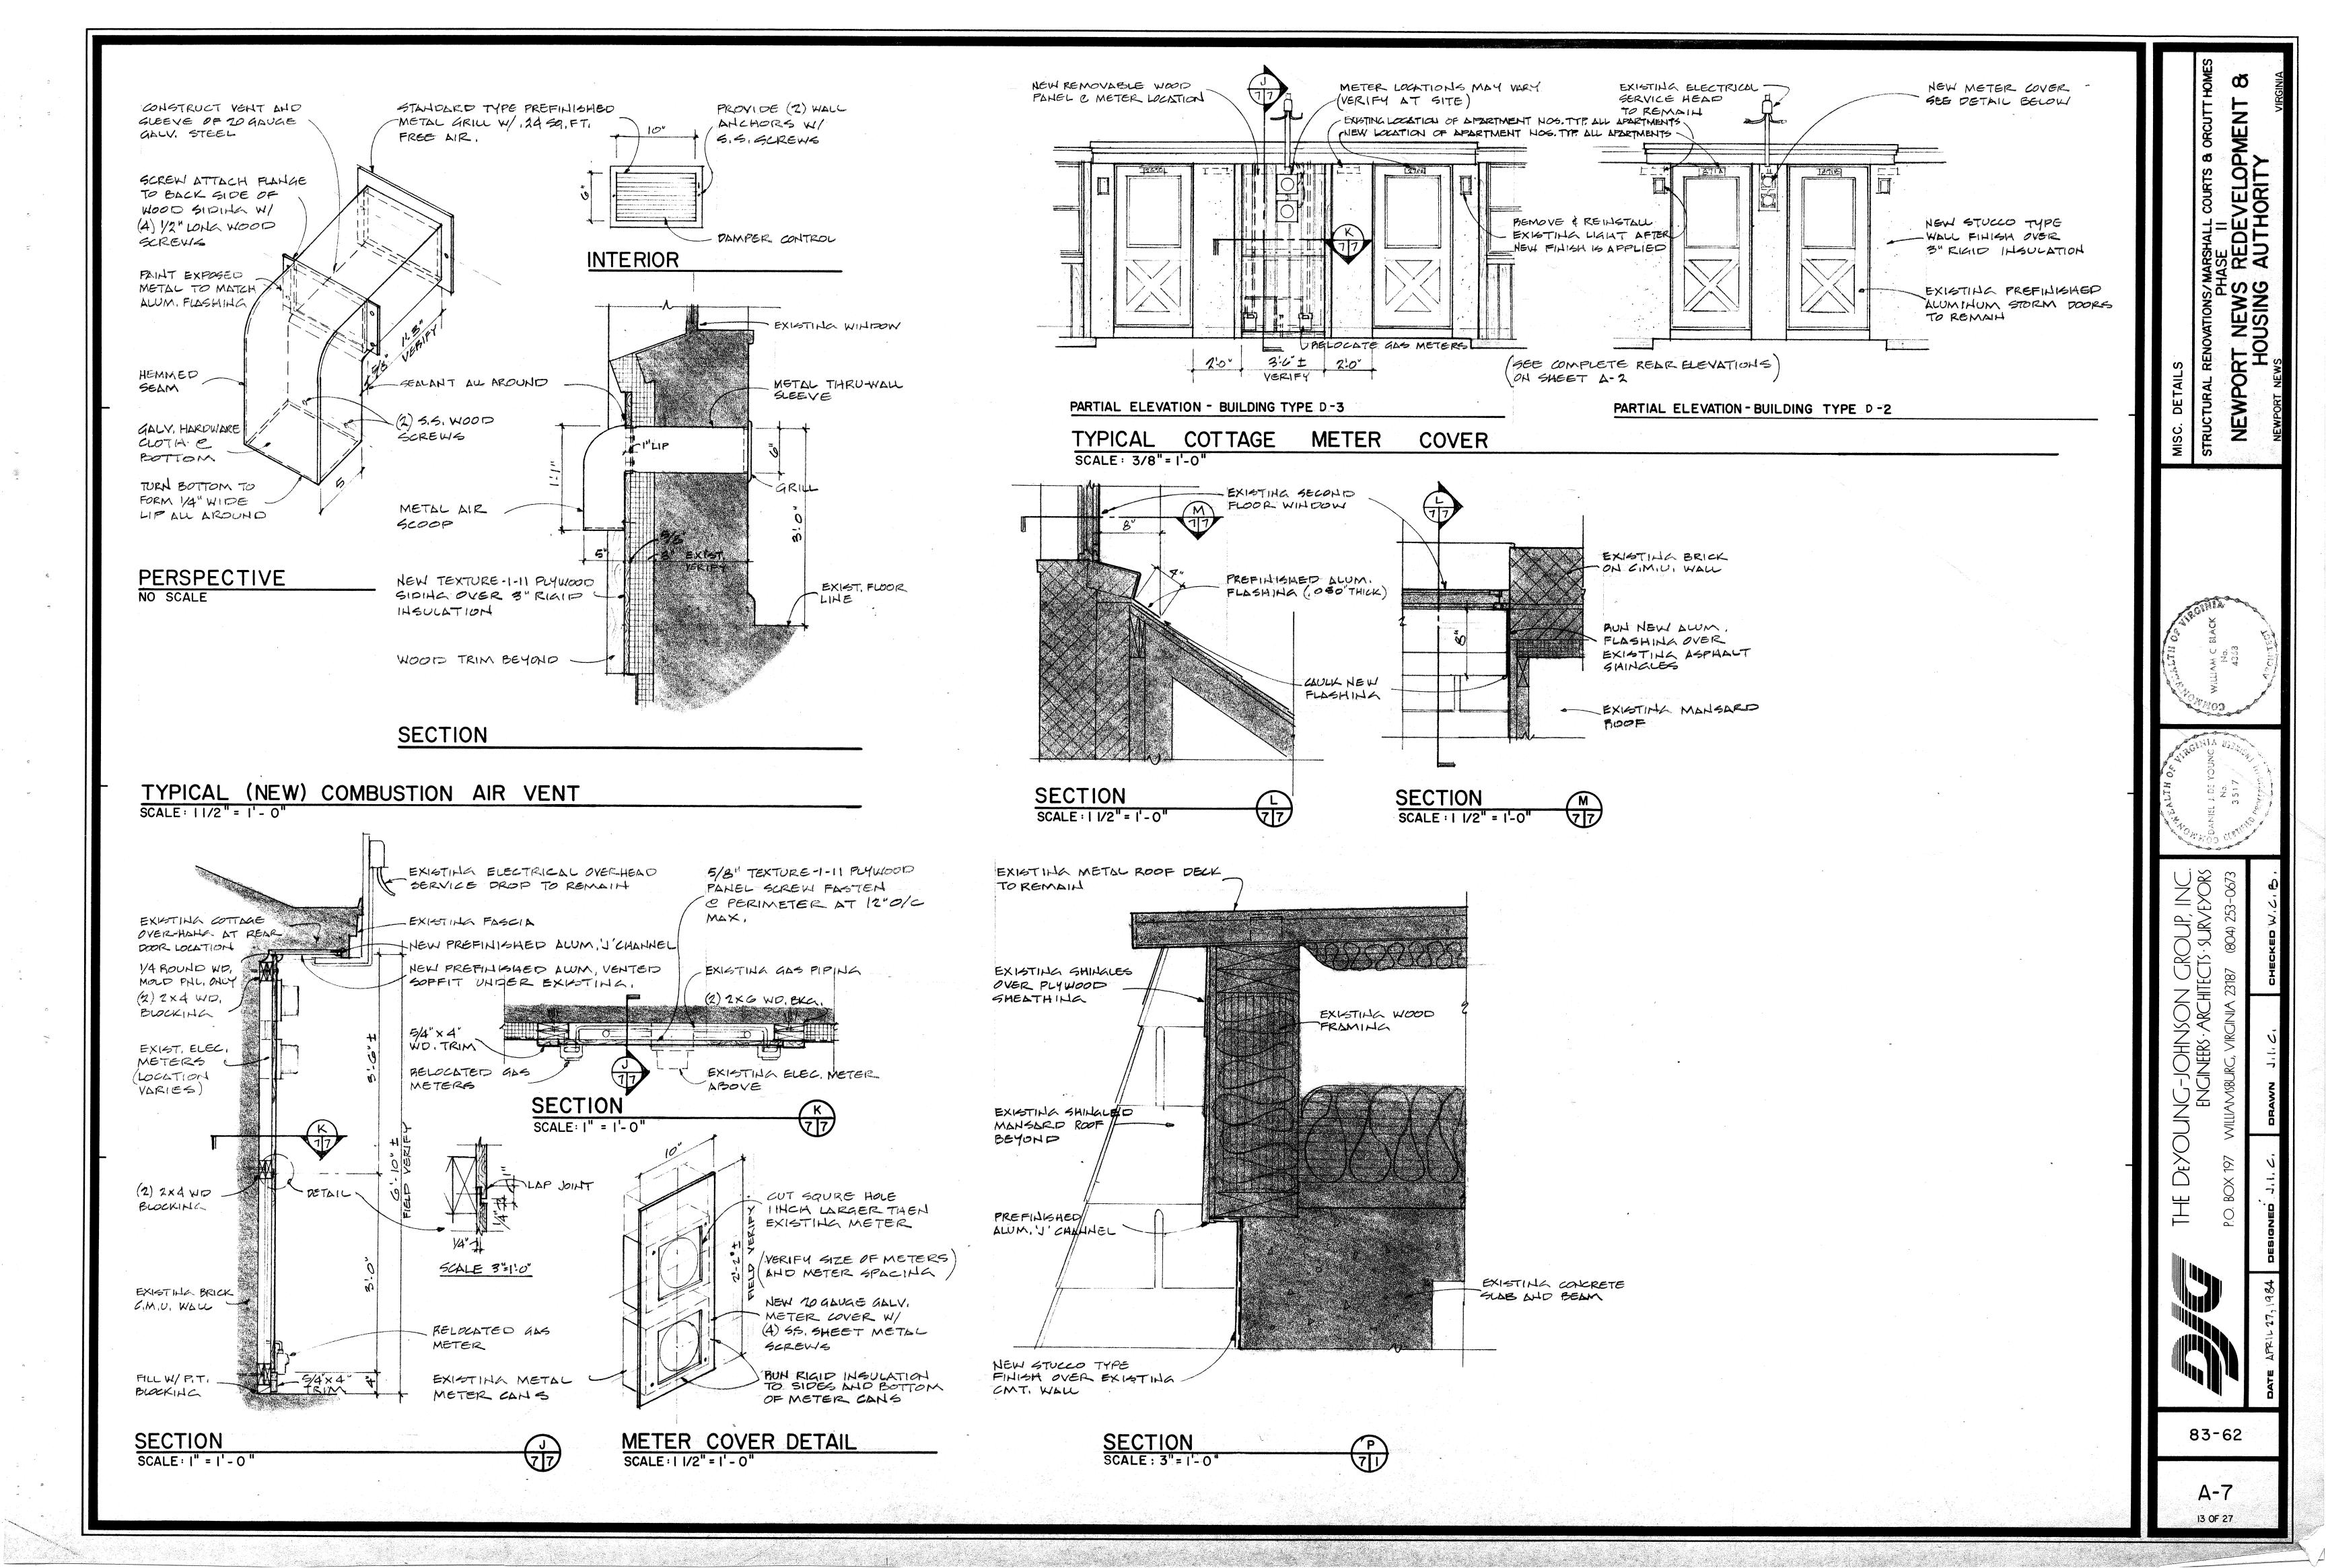

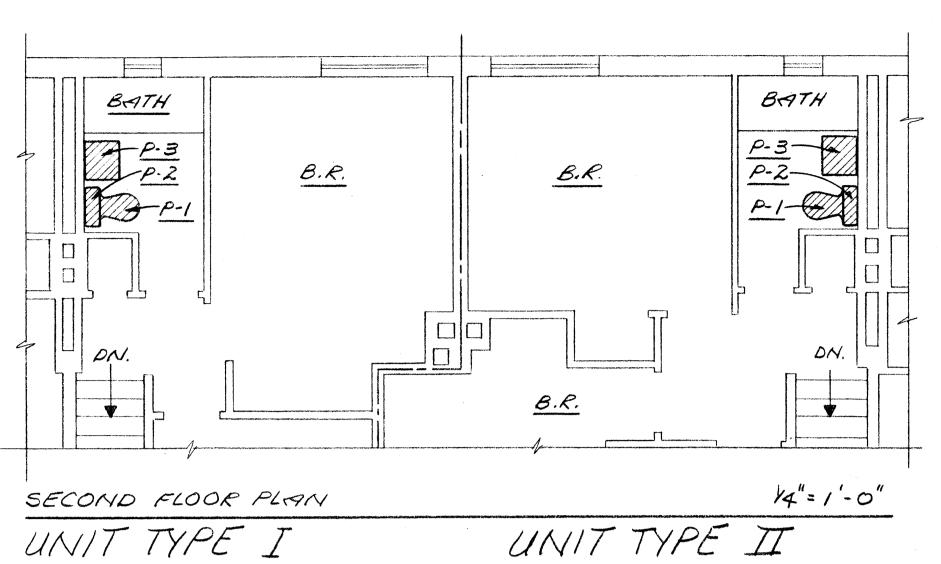


9 AS SHOWN 9 OPPOSITE HAND

9 AS SHOWN 9 OPPOSITE HAND

Vi.	PLUMBING FIXTURE SCHEDULE						
P#	FIXTURE	MANUFACTURER#	REMARKS				
P-/	WATER CLOSET BOWL	MANSFIELD #126	SUPPLY = BRASS CRAFT # R-1512 DL SEAT = BEMIS # 500TT WHITE				
P-2	WATER CLOSET TANK						
P-3	LAVATORY	MANSFIELD #1917C	FAUCETS = KOHLER # 7403T SUPPLY = BRASS CRAFT # R-1512 A P-TRAP = BRASS CRAFT # PVC 5001				

### MOTES:


- 1. PROVIDE NEW WAX SEAL FOR NEW WATER CLOSETS.
- 2. NEW WATER CLOSETS & LAVATORIES SHALL BE PLACED IN SAME LOCATION AS EXISTING.
- 3. ALL NEW PIPES SHALL MATCH EXISTING PIPES IN DIAMETER.

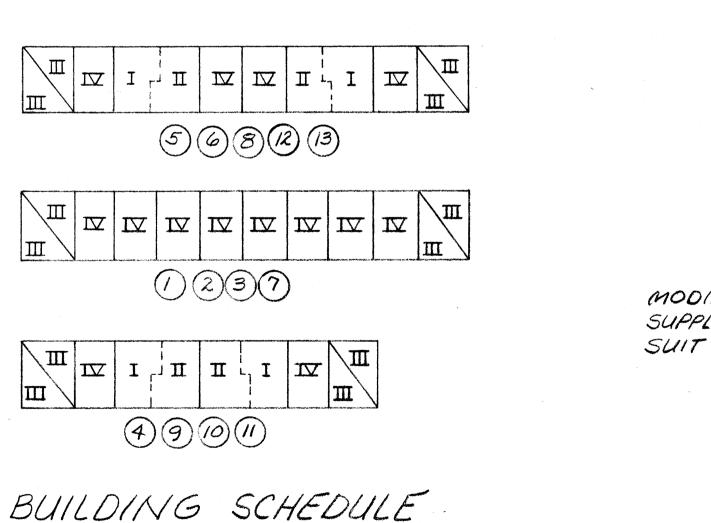



TOTAL APARTMENTS = 148

FOR BUILDING LOCATIONS SEE


ORCUTT HOMES SITE PLANS.

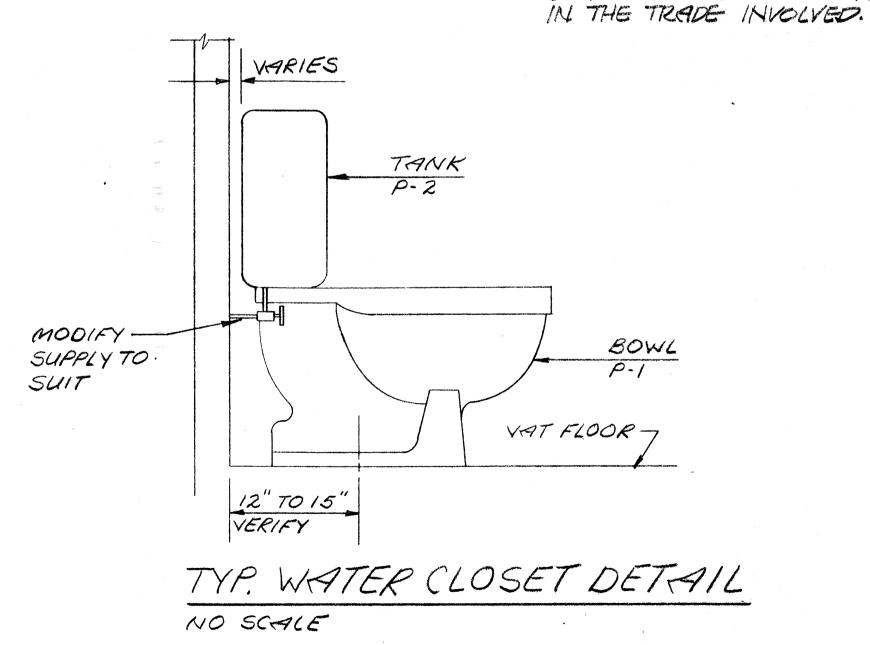

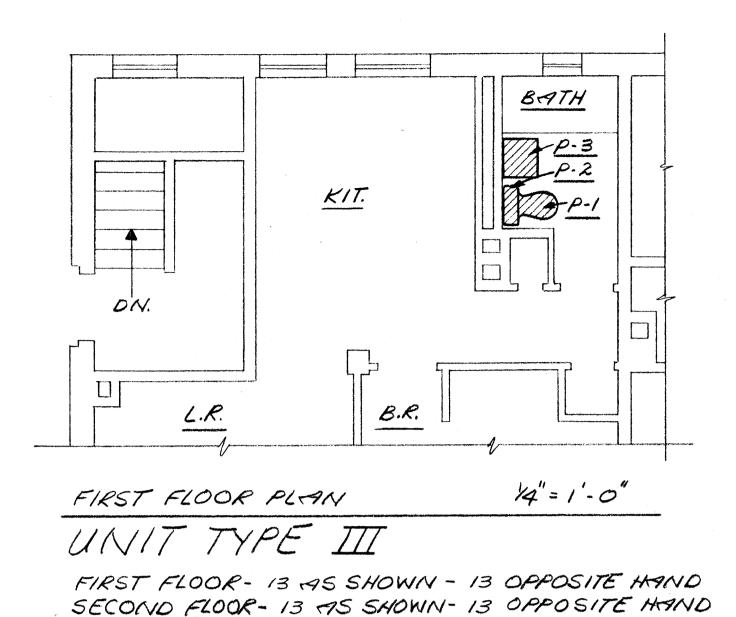


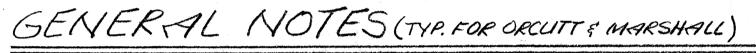

- 1. REMOVE LAVATORIES & WATER CLOSETS. PROVIDE NEW TANKS, BOWLS & LAVATORIES WITH NEW TRIM IN THE SAME LOCATION. MODIFY SUPPLY PIPING TO SUIT NEW FIXTURES. PROVIDE CUT-OFFS TO EACH FIXTURE AND PROVIDE NEW PLASTIC P-TRAPS ON LAVATORIES.
- 2. SEE SPECIFICATIONS FOR WATER CLOSET FLOOR FLANGE ALLOWANCE.
- 3. ALLOW 2 SF OF VINYL FLOOR PATCH IN ALL BATHS. TILE MUST BE SET SO WATER CLOSET IS INSTALLED OVER TILE TO MATCH EXISTING. SEE NOTE 7.
- 4. ALLOW 3 SF OF PLASTER / MASONRY | GWB WALL PATCH. SEE NOTE 7.
  5. PAINT WALL AREA BEHIND FIXTURES 4'-0" HIGH FROM SIDE WALL
- TO TUB SURROUND EDGE WITH TWO COATS STANDARD
  WHITE SEMI GLOSS LATEX. SEG NOTE 7.
- 6. FOR LOCATION OF BUILDINGS, GAS METERS AND HOSE BIBBS SEE MARSHALL COURTS SITE PLANS.
- 7. CUTTING, PATCHING & PAINTING SHALL BE PROVIDED UNDER SPEC. SECTION 01045 AND DIVISION 9. WORKMEN SHALL BE SKILLED

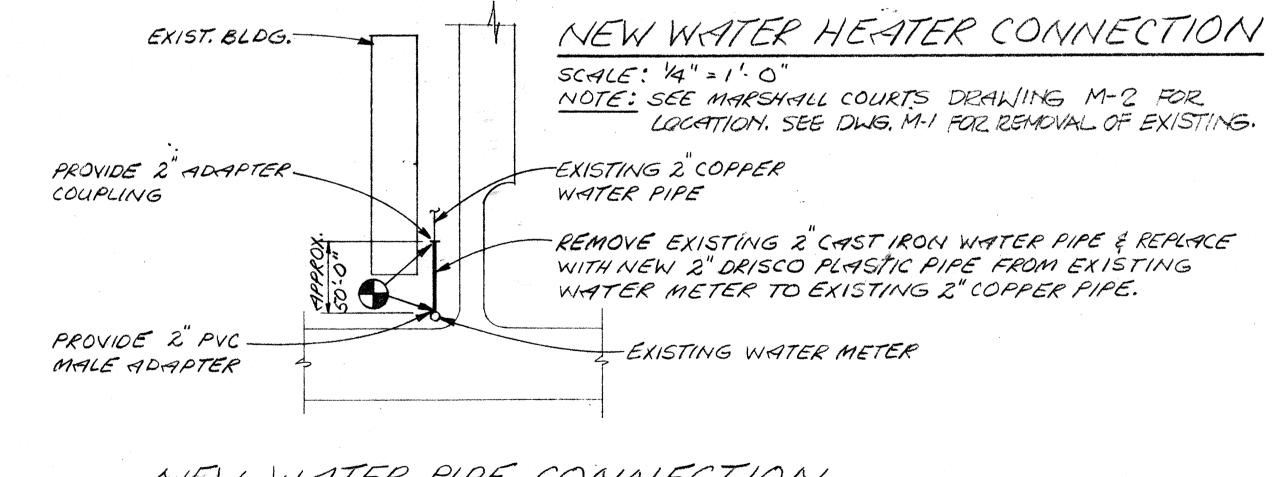


NEW WATER PIPE CONNECTION SCALE: 1"=60' (TYPICAL FOR BUILDING () THRY (A)) SEE MARSHALL COURTS SITE PLANS.

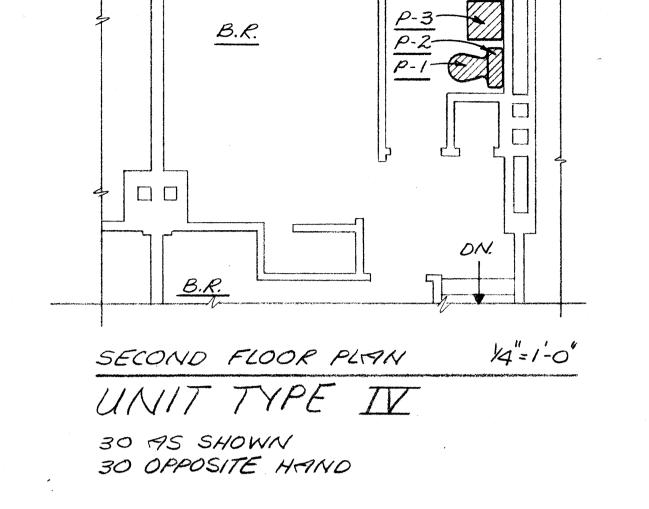




BATH

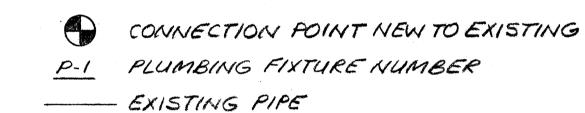


- NEW PIPE

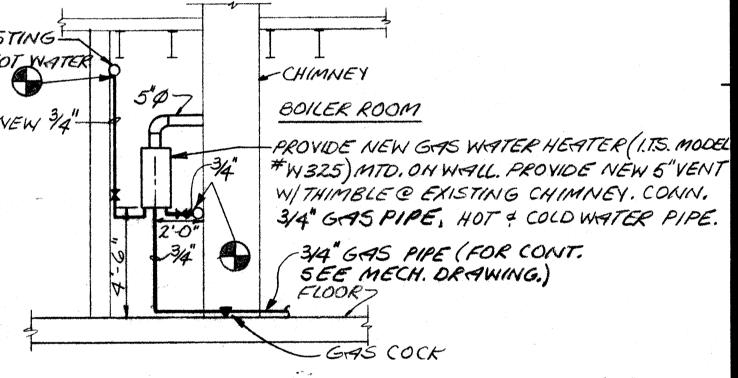



DEYOUNG-JOHNSON GRO


83-62

| 19 *∘* of 27

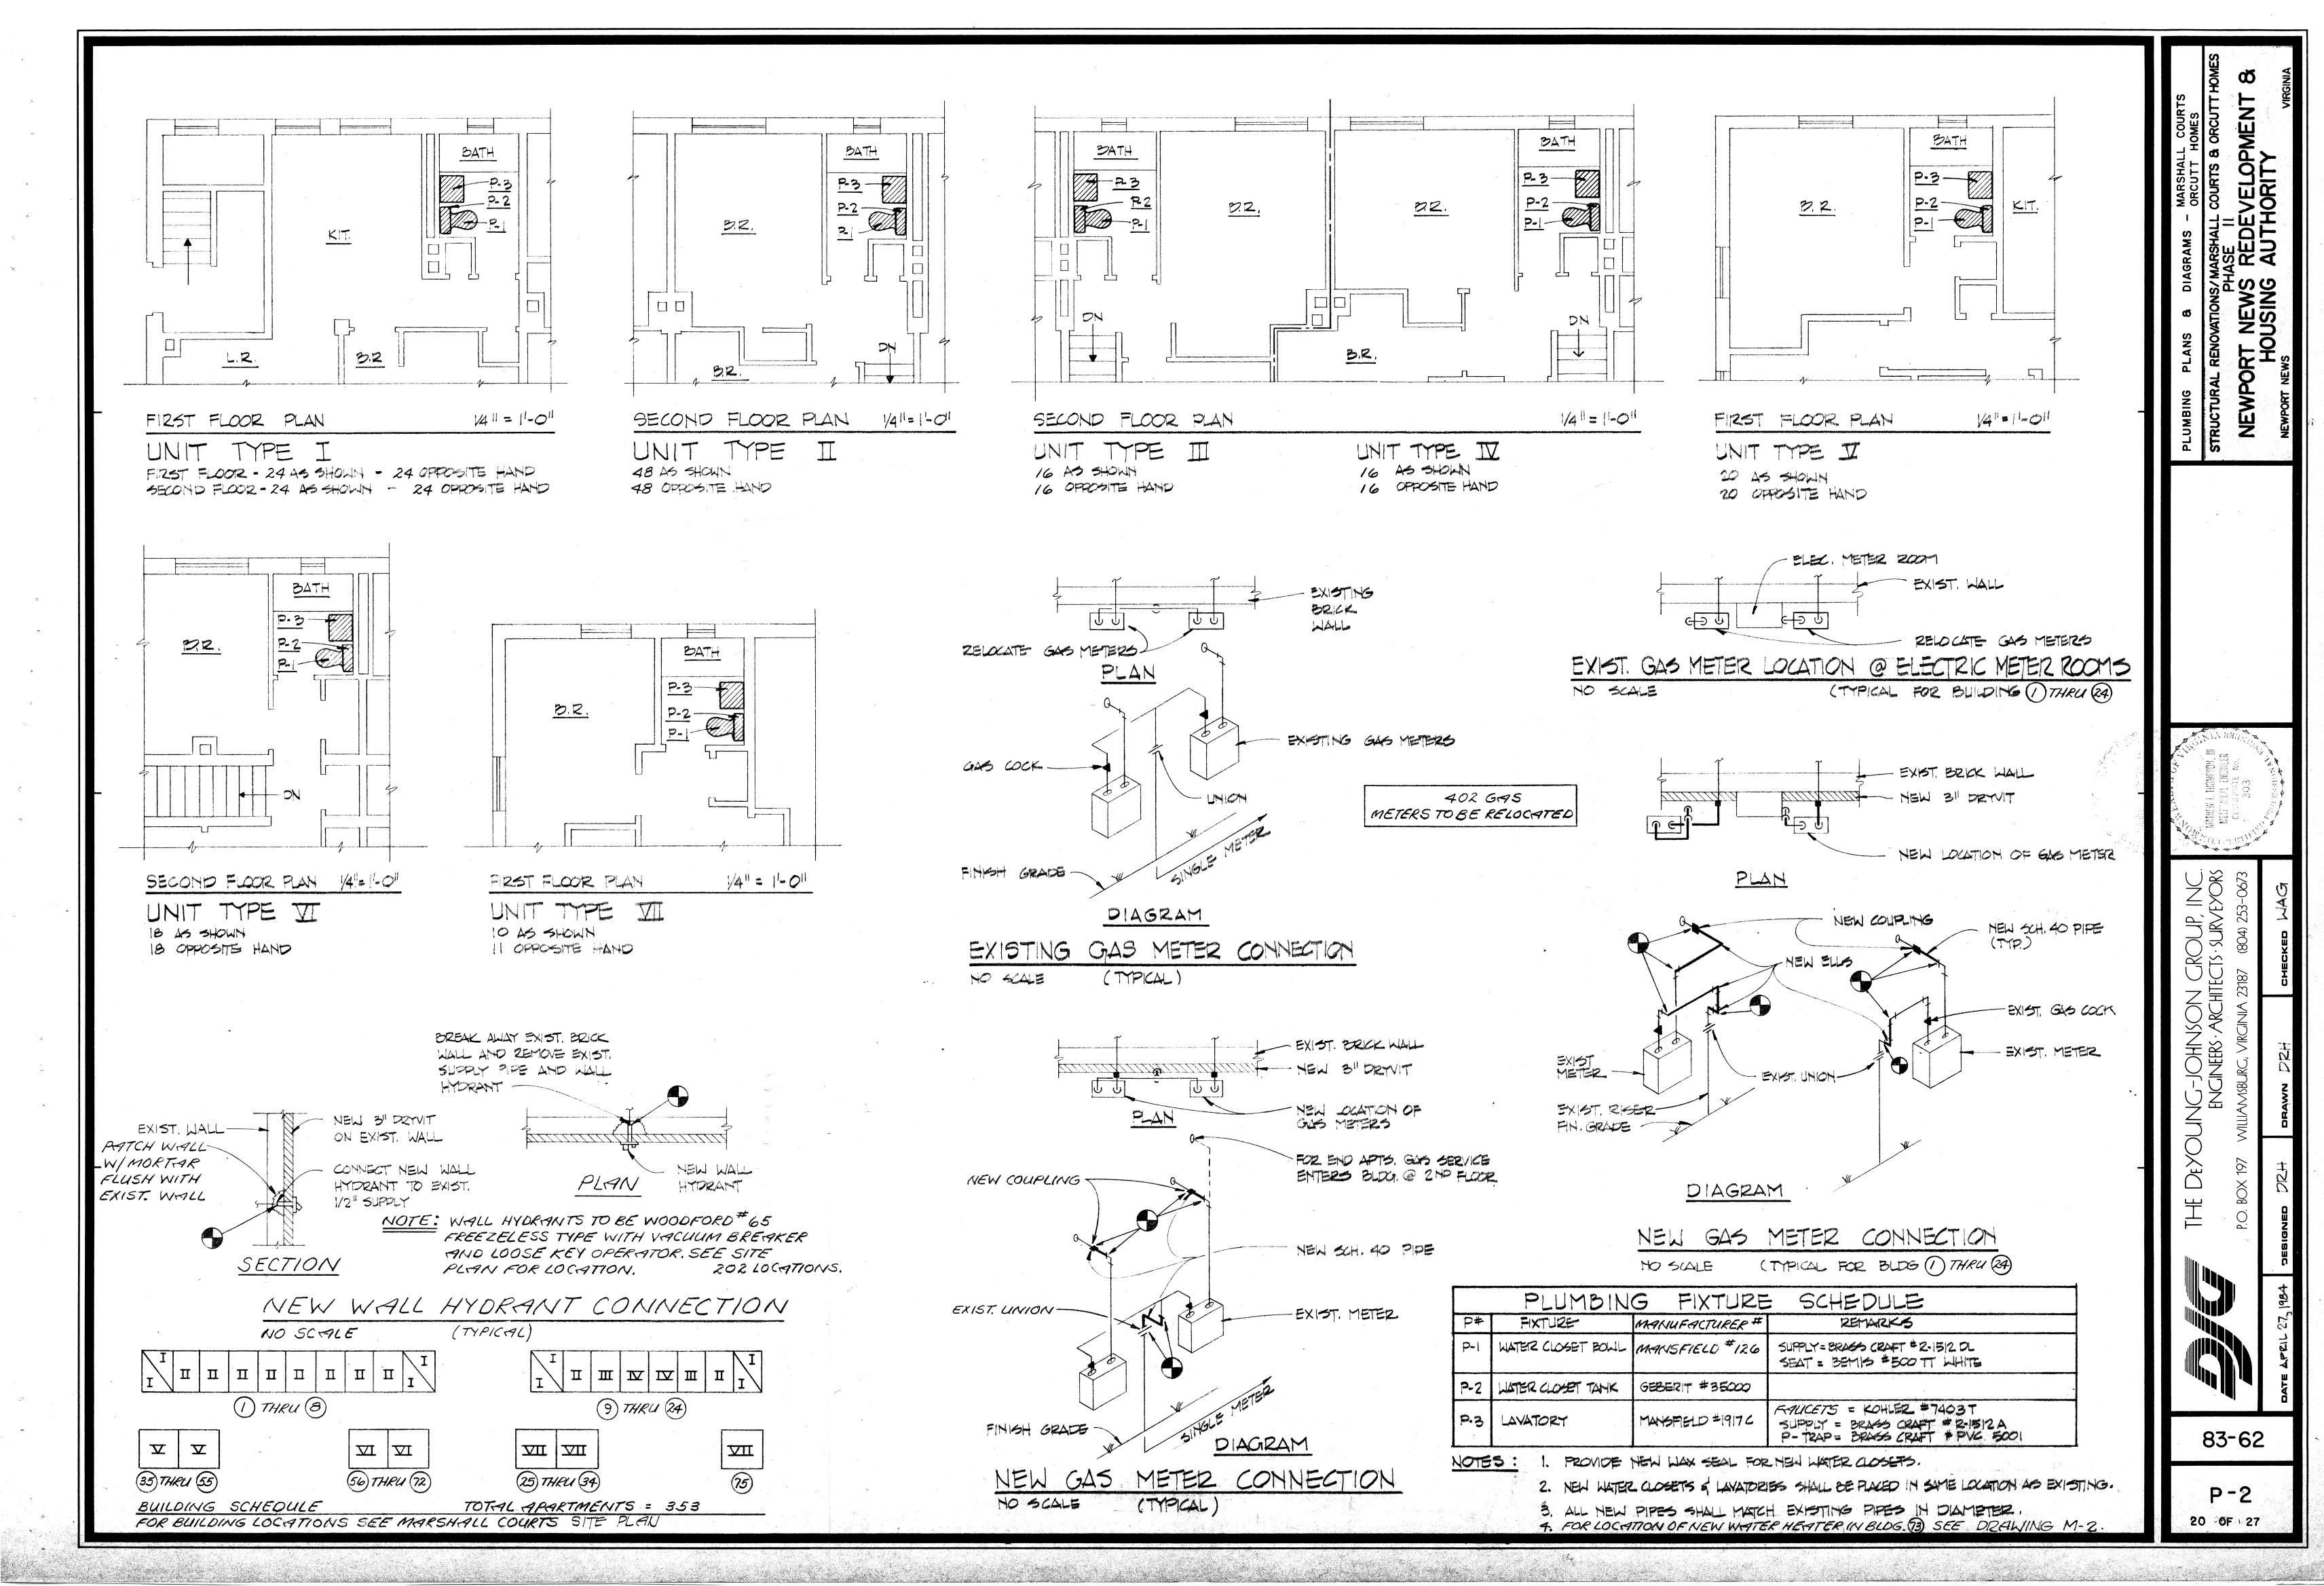

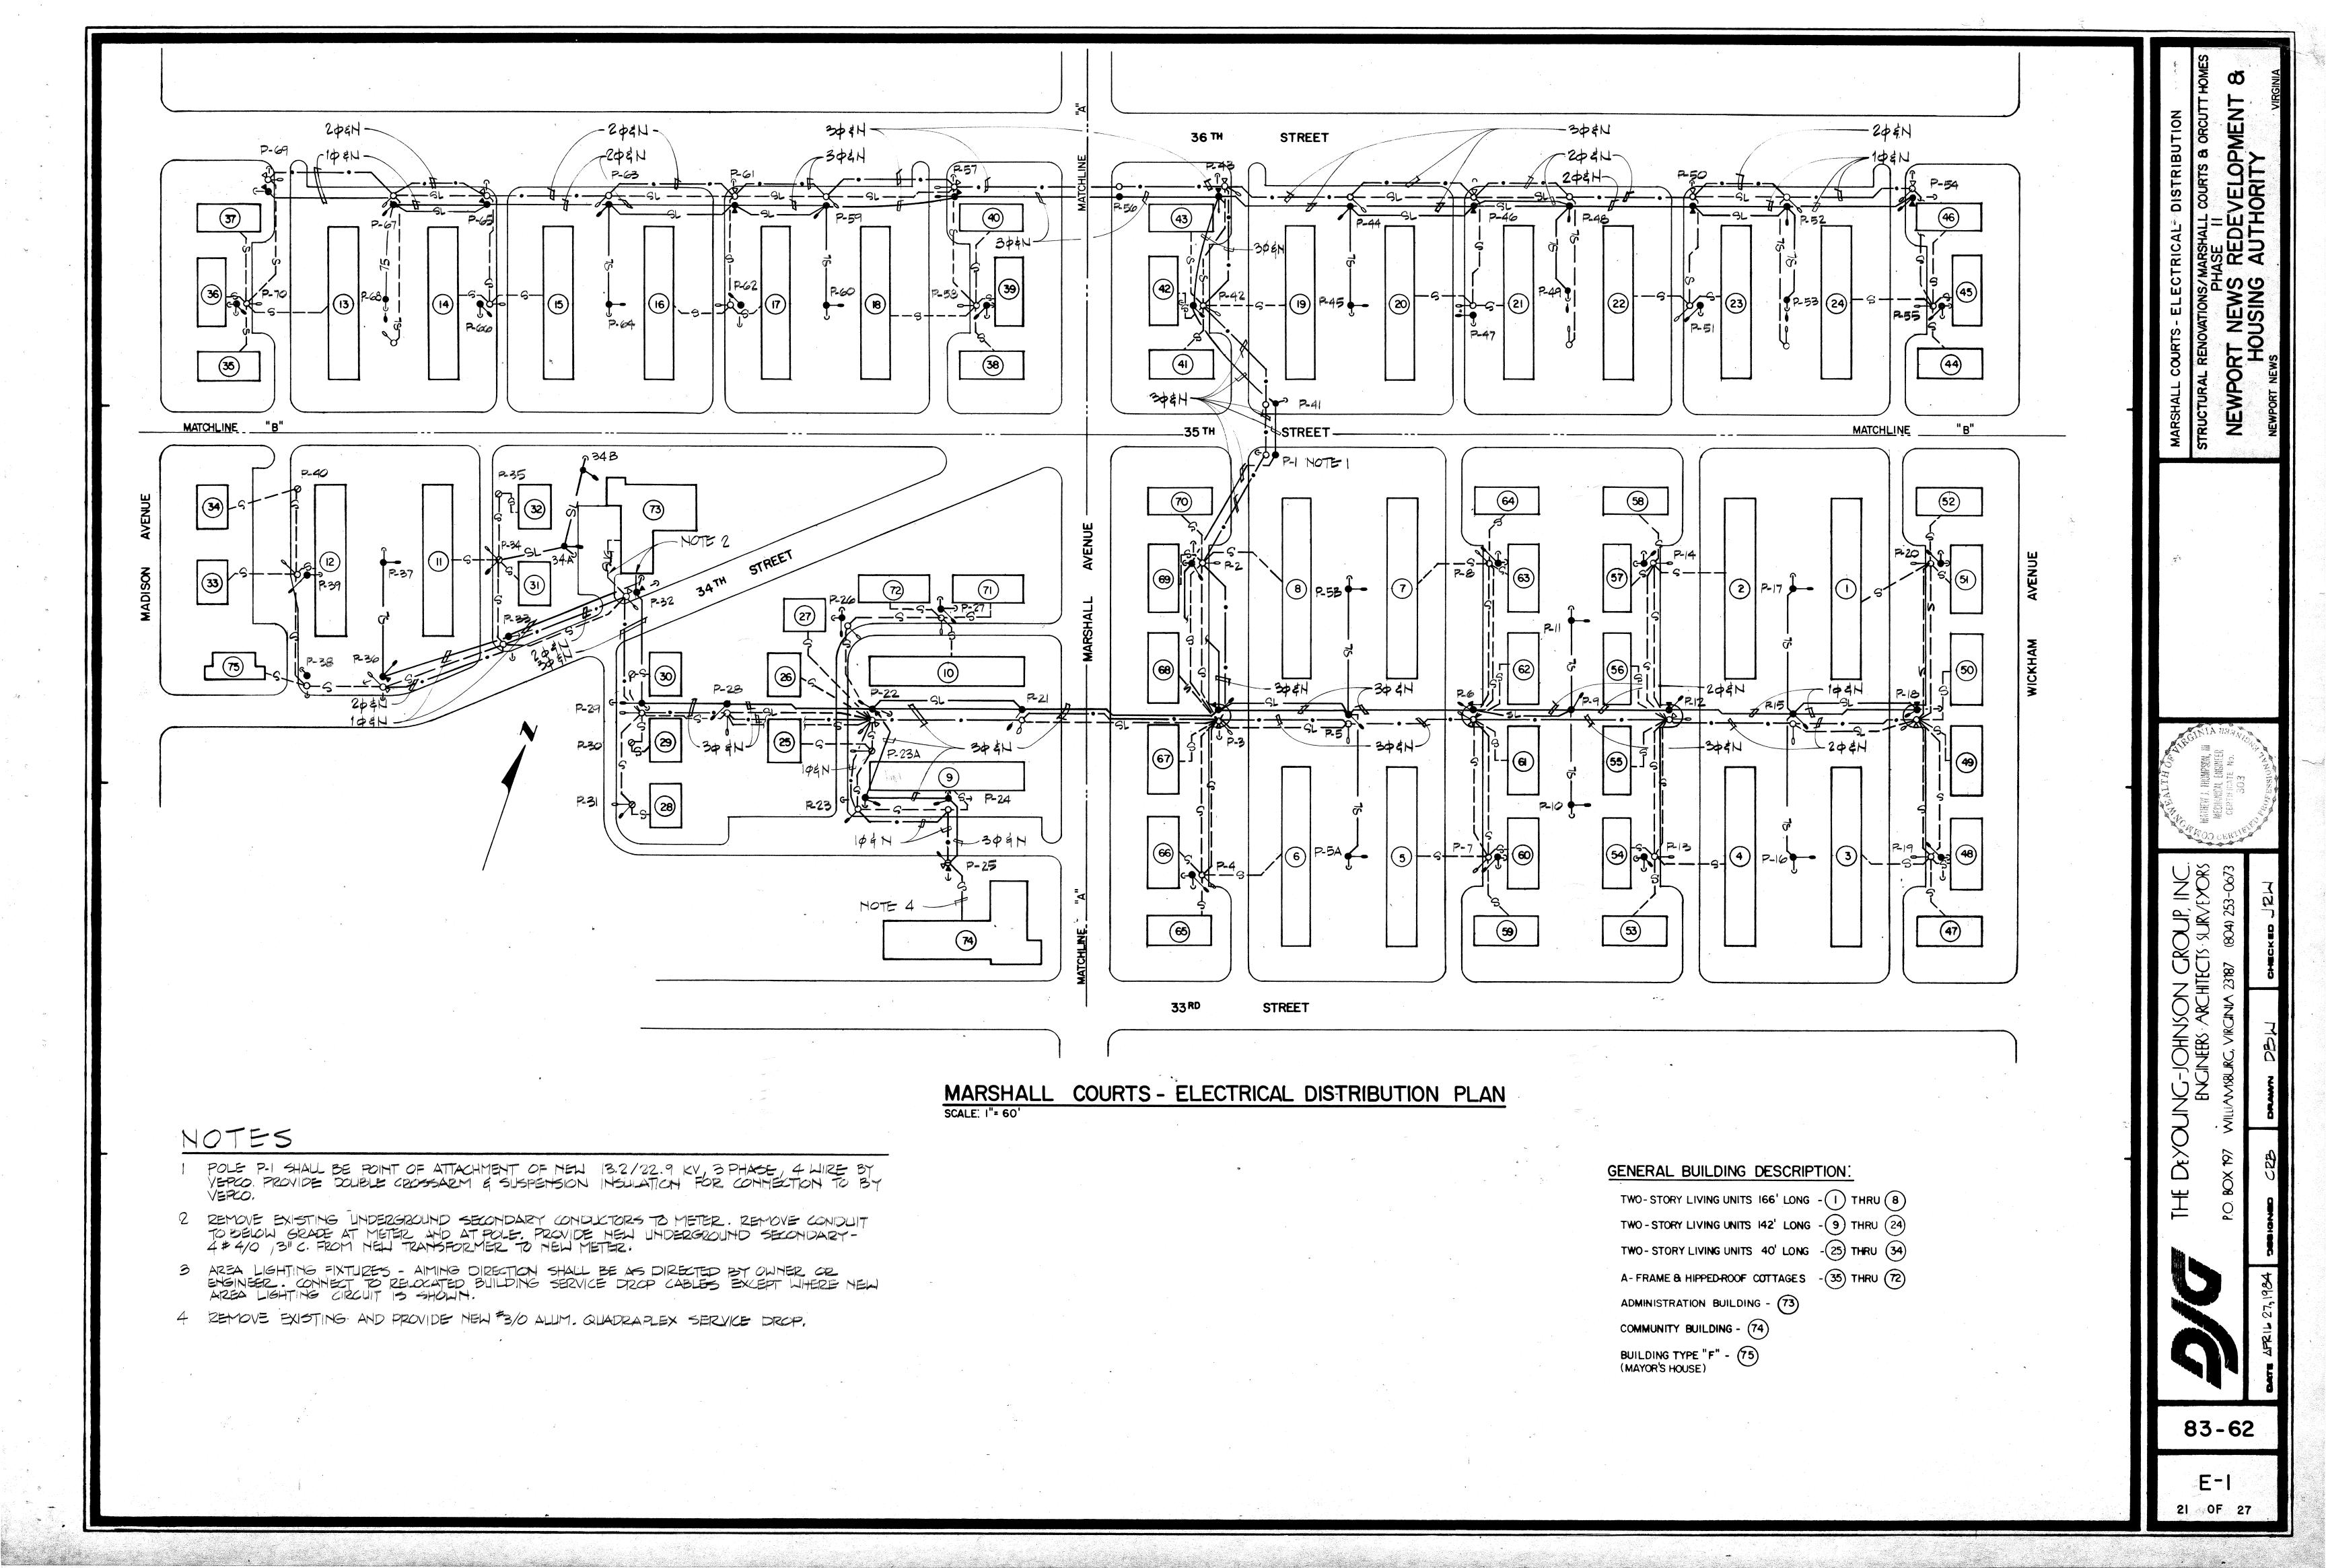

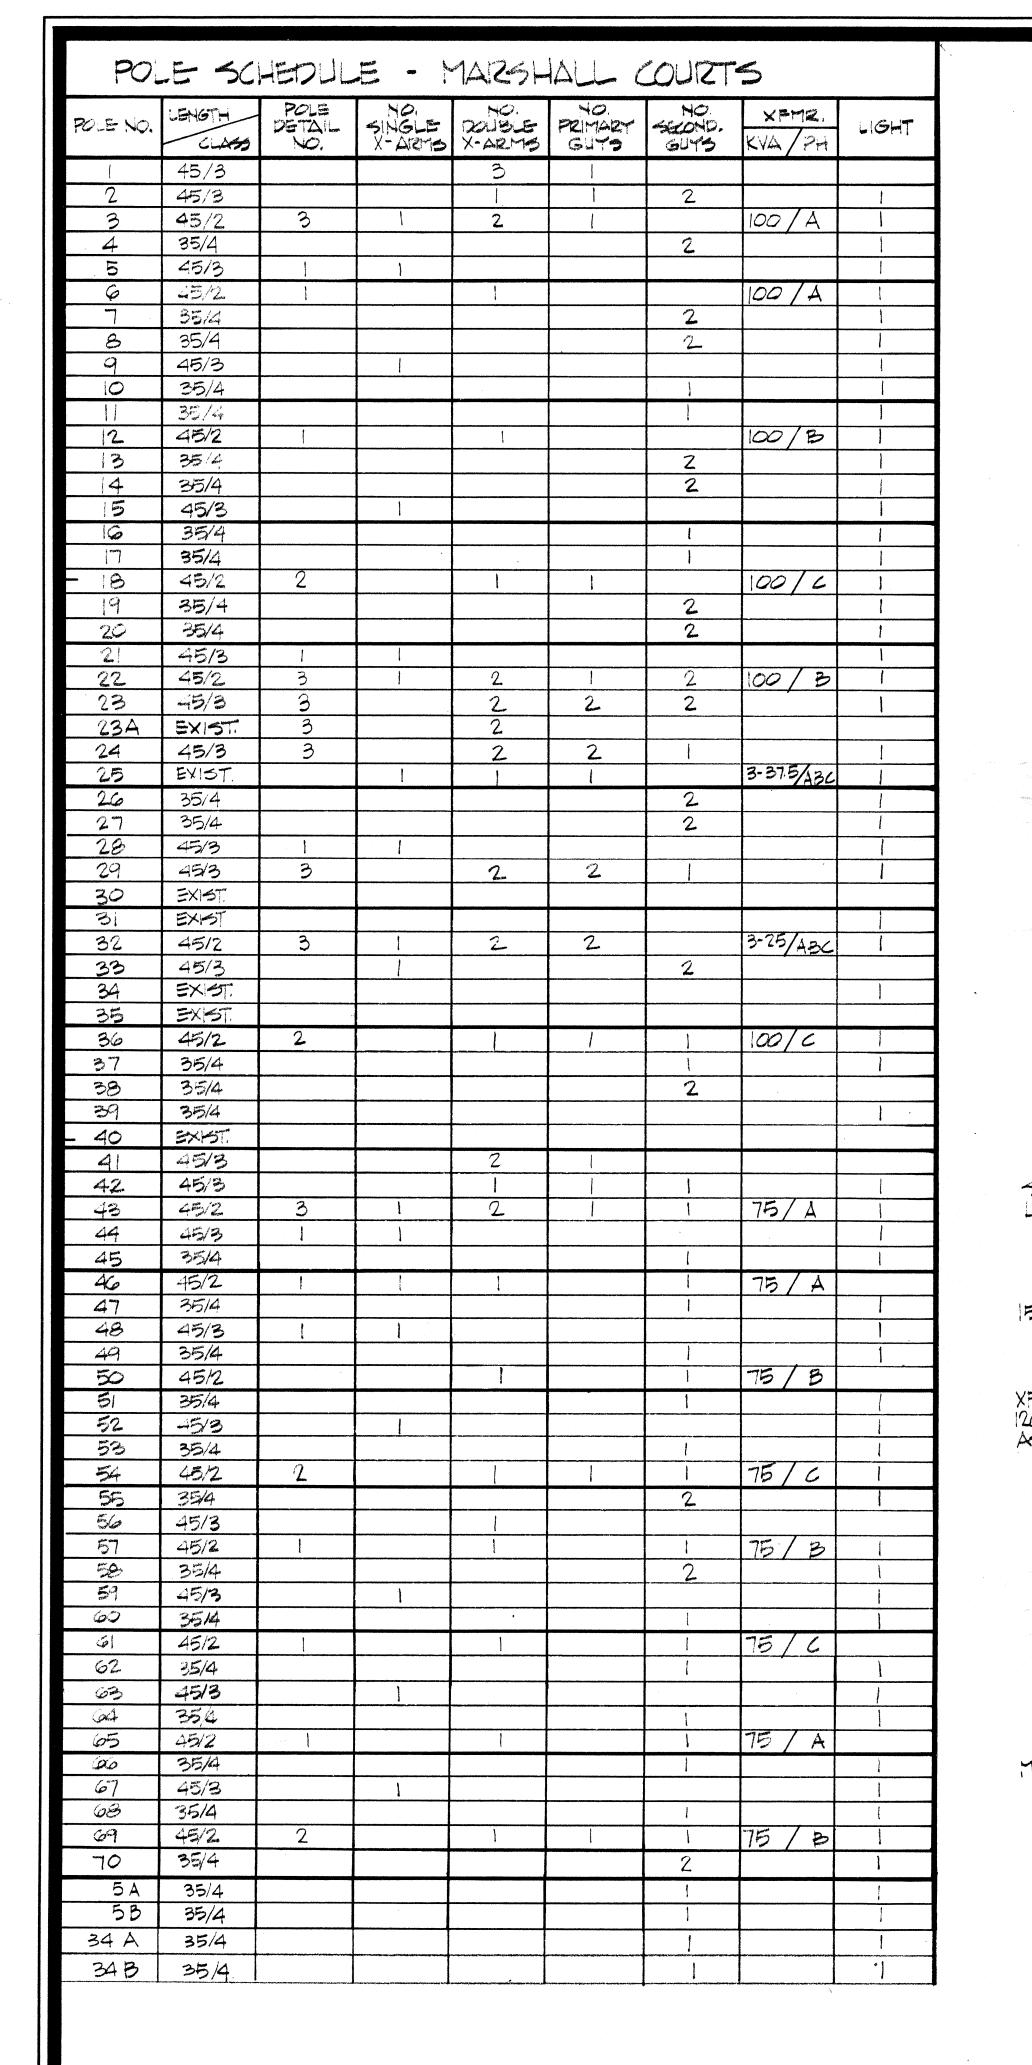


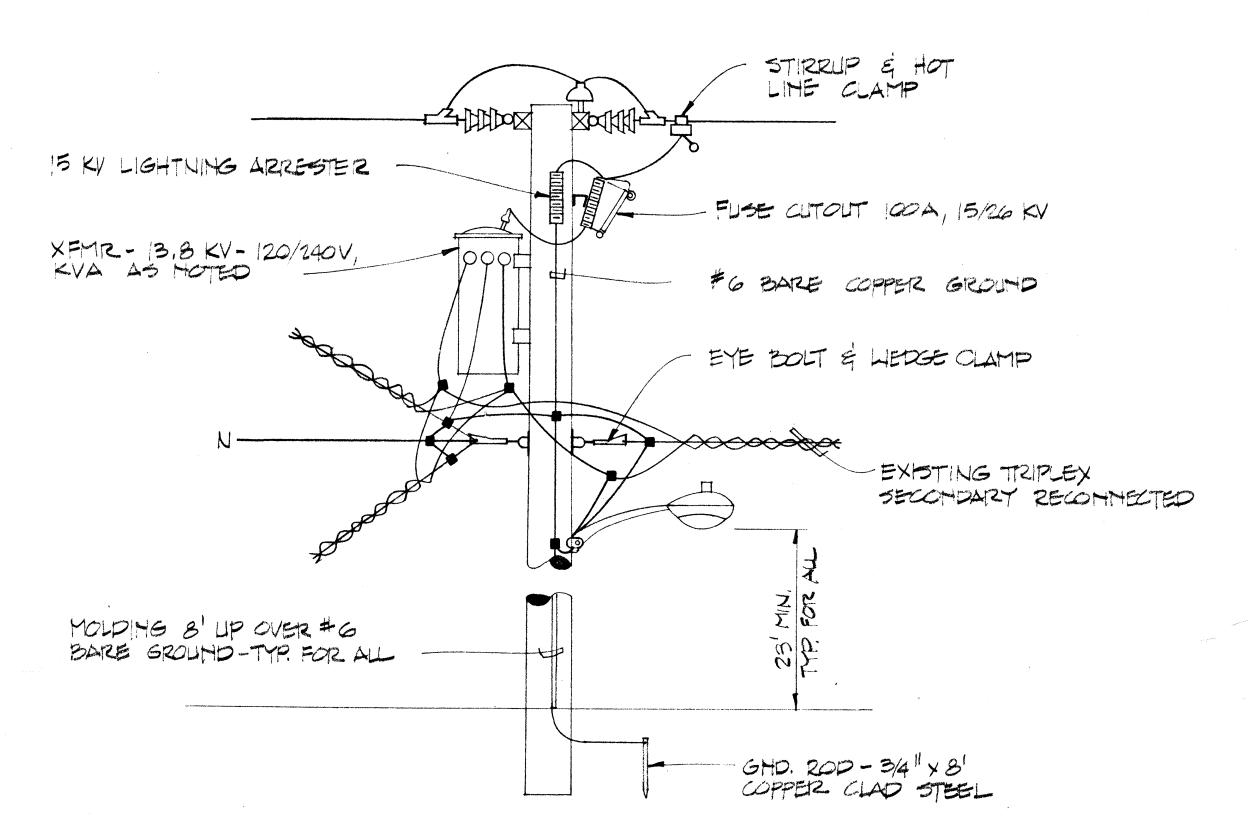

POLE DETAIL NO. 1

NO SCALE

NOTE: POLE PETALS TO HOTSHOLL SPECIFIC PETALLS FOR ALL SITUATIONS EMCOUNTERED.
PETALS ARE TO GIVE A GENERAL INDICATION
OF THE TYPE OF CONSTRUCTION REQUIRED.

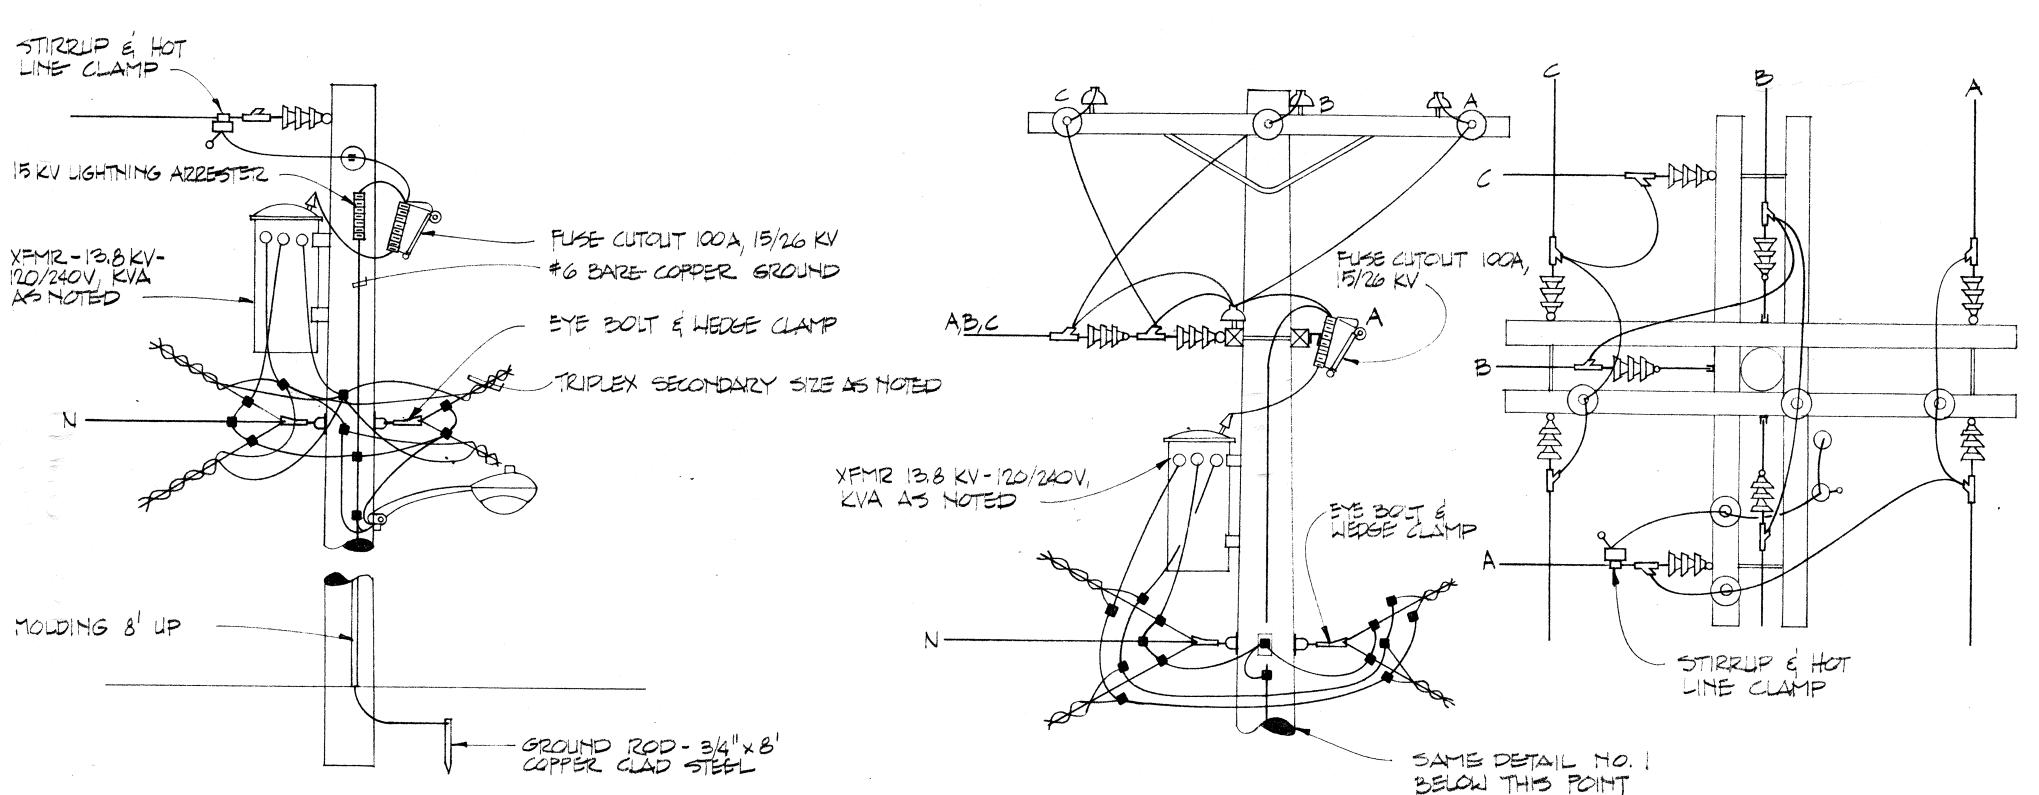

POLE DETAIL NO. 2 NO SCALE

DETAIL SCALE

LEGEND - ELECTRICAL DISTRIBUTION

- EXISTING 3450/5975 VOLT DISTRIBUTION- REMOVE --- 5--- EXISTING ALUM, TRIPLEX - DISCONNECT FROM EXIST. TRANSFORMER & CONNECT TO HEW TRANSFORMER

-- SL-- SXISTING 2-1 COND AREA LIGHTING CIRCUIT-REMOVE

NEW 13.2/22.9 KV DISTIZIBUTION - #2 ACOR

NEW AREA LIGHTING CIRCUIT- #6 AL DUPLEX

EXIST HE WOOD POLE - REMOVE

EXISTING WOOD POLE- TO REMAN

NEW WASD POLE - SEE POLE SCHEDULE FOR HOMENCLATURE & EQUIPMENT

EXISTING 3450-120/240 VOLT TRANSFORMER-REMOVE

NEW 13.2 KV-120/240 VOLT TRANSFORMER

EXISTING AREA LIGHT - REMOVE

HEW AREA LIGHTING FIXTURE - 150 W HIGH PREMIOURE WOULD - SEE HOTE 3, SHEET E-1.


NEW OUT & ANCHOR


REDEVELOPMENT AUTHORITY

NEWPORT NEWS
HOUSING
NEWPORT NEWS

83-62

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- 1. ALL MATERIALS AND CONSTRUCTION METHODS SHALL CONFORM TO THE CURRENT STANDARDS AND SPECIFICATIONS OF THE CITY OF NEWPORT NEWS DEPARTMENT OF ENGINEERING AND PUBLIC UTILITIES, AND THE
- THE CONTRACTOR SHALL CALL "HISS UTILITIES OF TIDEWATER" AT 1-800-552-7001 48 HOURS PRIOR TO BEGINNING ANY EXCAVATION.

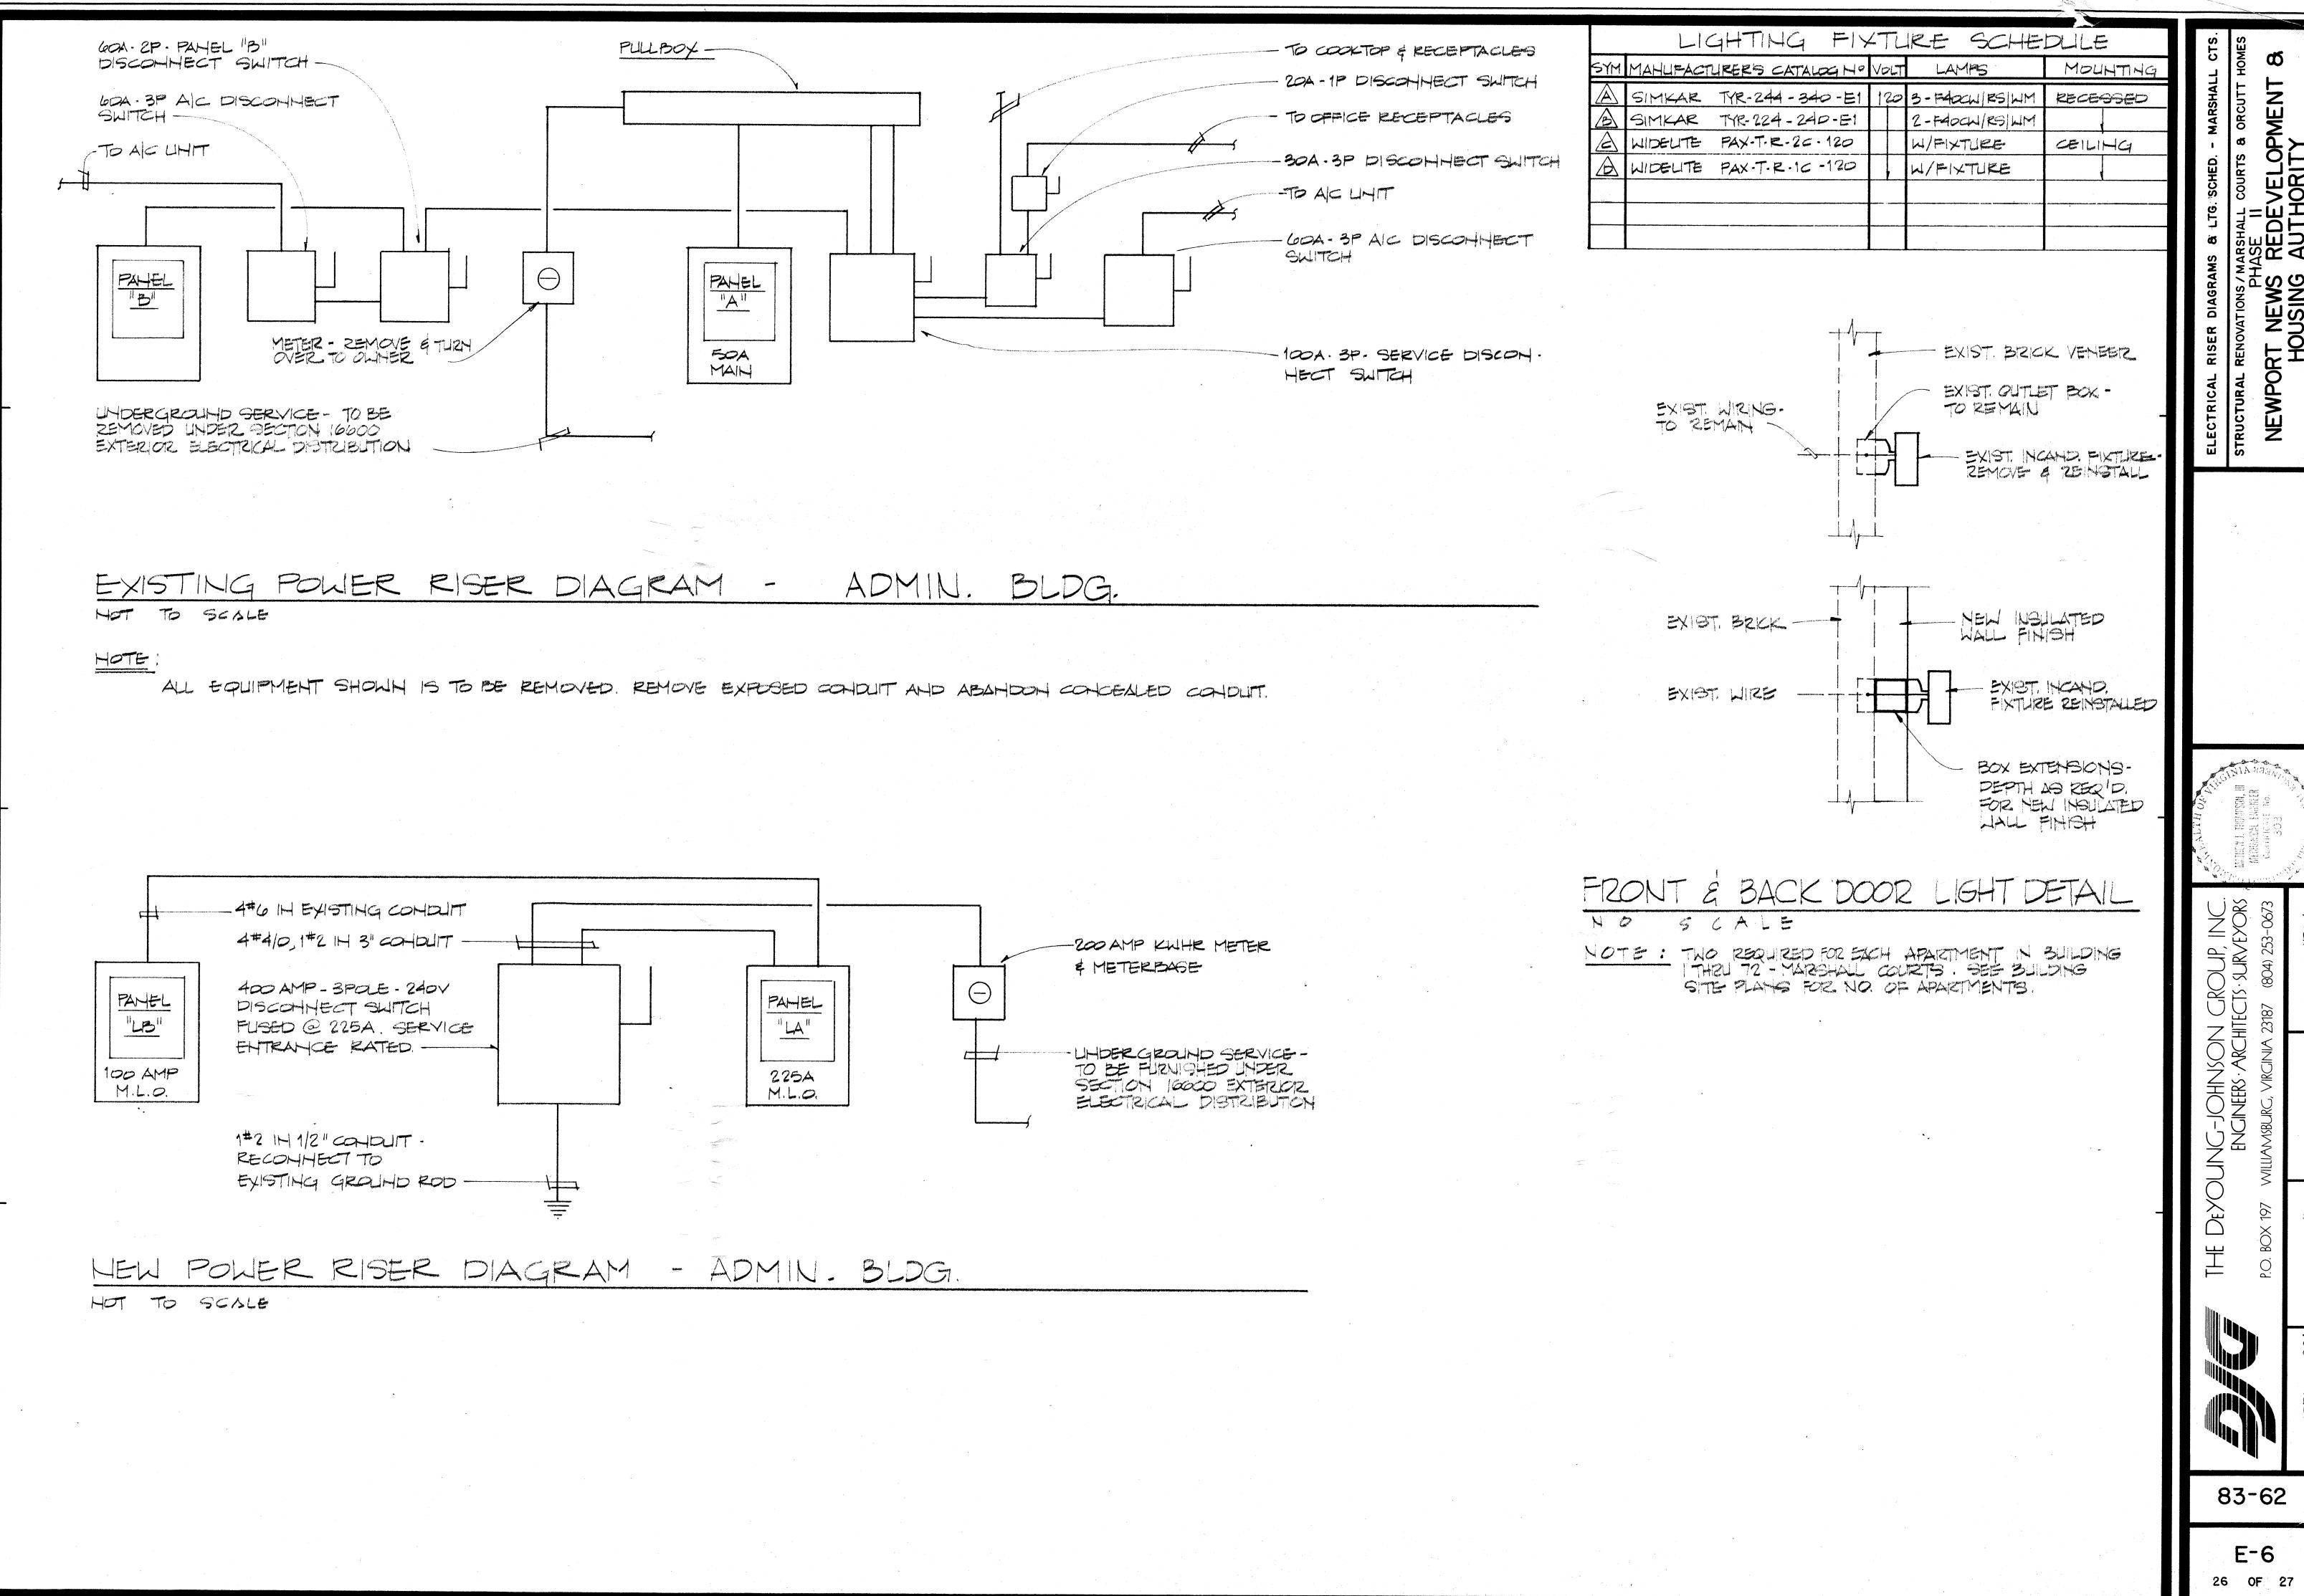VIRGINIA DEPARTMENT OF TRANSPORTATION.

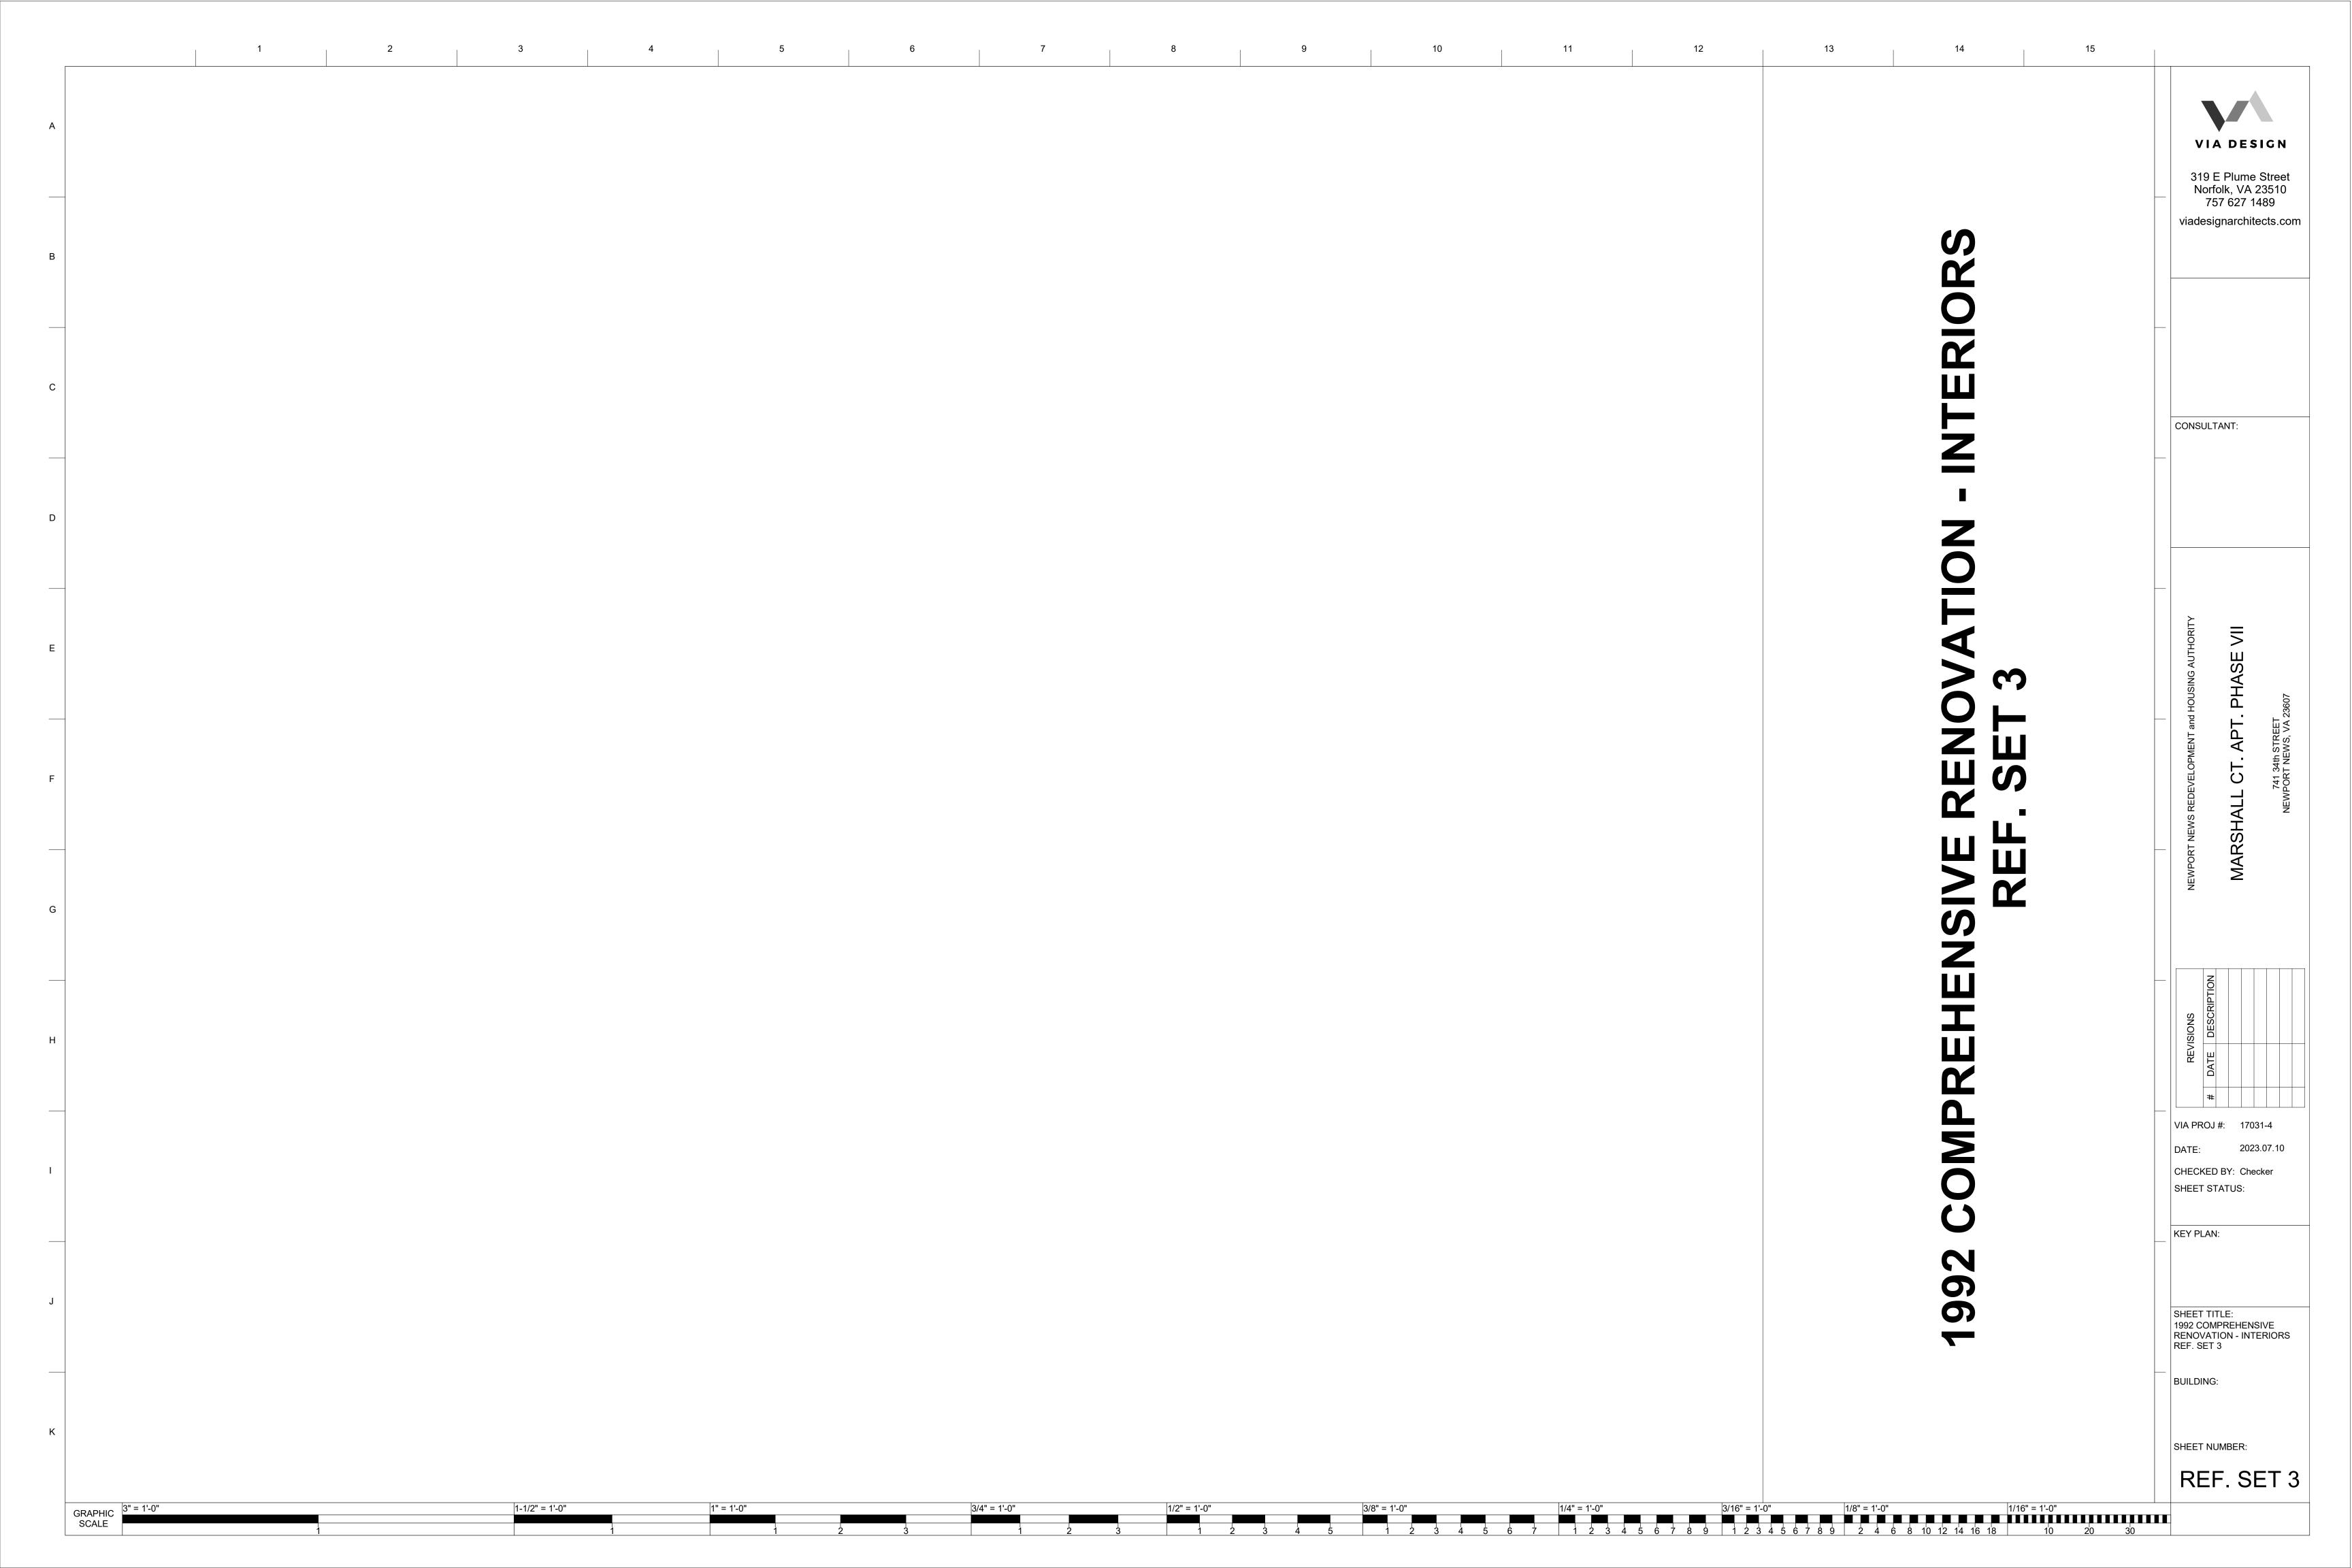- 3. PRIOR TO ANY EXCAVATION OR CONSTRUCTION, THE CONTRACTOR SHALL UNCOVER ALL UTILITIES WHICH ARE SHOWN ON THE PLANS OR WHICH HAVE BEEN MARKED BY MISS UTILITIES AS BEING IN THE AREA OF EXCAVATION OR CONSTRUCTION. THE CONTRACTOR SHALL TAKE VERTICAL AND HORIZONTAL MEASUREMENTS ADEQUATE TO DETERMINE IF ANY CONFLICT WILL OCCUR. IF ANY POTENTIAL CONFLICT IS FOUND, THE CONTRACTOR SHALL NOTIFY THE SITE ENGINEER PRIOR TO BEGINNING ANY EXCAVATION OR CONSTRUCTION. THE CONTRACTOR SHALL BE RESPONSIBLE FOR REPAIRING AT HIS EXPENSE ALL EXISTING UTILITIES DAMAGED DURING CONSTRUCTION. THE CONTRACTOR SHALL BE RESPONSIBLE FOR REMOVING AND RE-INSTALLING AT HIS EXPENSE ANY UTILITY WHICH MUST BE RELOCATED BECAUSE OF A CONFLICT WHICH WAS NOT REPORTED TO THE SITE ENGINEER PRIOR TO THE BEGINNING OF ANY
- 4. THE CONTRACTOR SHALL NOTIFY ALL UTILITY COMPANIES 24 HOURS IN ADVANCE OF ANY EXCAVATION IN PROXIMITY OF THEIR UTILITIES.
- 5. PRIOR TO CONSTRUCTION WITHIN ANY EXISTING PUBLIC RIGHT-OF-WAY, THE CONTRACTOR SHALL OBTAIN A PERMIT FROM THE CITY OF NEWPORT
- 6. THE CONTRACTOR SHALL BE RESPONSIBLE FOR REPLACING WITH MATCHING MATERIALS ANY DRIVEWAYS, WALKS, CURBS, ETC., THAT MUST BE CUT OR ARE DAMAGED DURING CONSTRUCTION.
- 7. THE CONTRACTOR SHALL PROVIDE TEMPORARY DRAINAGE AND EROSION PROTECTION DURING CONSTRUCTION AS DIRECTED BY THE OWNER OR THE CITY OF NEWPORT NEWS, VIRGINIA.
- 8. THE CONTRACTOR WILL USE ONLY APPROVED MATERIAL IN THE BACKFILL OF UTILITY TRENCHES.
- 9. ALL UTILITY TRENCHES SHALL BE COMPACTED AND BACKFILLED TO WITHIN 0.2' OF FINAL SUBGRADE ELEVATION AND GRADED TO DRAIN. EXCESS MATERIAL SHALL BE REMOVED AT THE CONTRACTOR'S EXPENSE. ALL FINISHED SLOPES IN UTILITY EASEMENTS OR IN RIGHTS OF-WAY NOT SUBJECT TO PAVING SHALL BE TOPSOILED AND SEEDED IN


- 10. A LAND DISTURBING PERMIT IS REQUIRED.
- 11. FOR SIGN CONDITIONS FOR SITE, CONTACT THE DEPARTMENT OF CODES COMPLIANCE AT 247-8871.
- 12. TREES TO BE PROTECTED IN ACCORDANCE WITH VIRGINIA EROSION
- CONTROL STANDARDS.

  13. ALL UTILITIES SHALL BE PLACED UNDERGROUND IN ACCORDANCE WITH THE CITY OF NEWPORT NEWS UNDERGROUND UTILITY ORDINANCE.
- THE CITY OF NEWPORT NEWS UNDERGROUND UTILITY ORDINANCE.

  14. DUCTILE IRON SANITARY SEWER SHALL BE USED EXCLUSIVELY WHEN
- 15. EXTERIOR LIGHTING MUST PROVIDE A MINIMUM ILLUMINATION LEVEL OF 0.25 LUMENS PER SQUARE FOOT OF PARKING LOT & DRIVING AREA.

COVER OVER THE SANITARY SEWER IS LESS THAN 36 INCHES OR GREATER

- 16. ALL LIGHTING SHALL BE DIRECTED INWARD ON SITE.
- 17. ELEVATIONS AS SHOWN HEREON ARE BASED ON U.S. NATIONAL OCEAN SURVEY DATUM (FORMERLY U.S.C. & G.S. DATUM): MEAN SEA LEVEL = 0.00.
- 18. ALL DIMENSIONS ARE TO FACE OF CURB.
- SEE ARCHITECTURAL BUILDING PLANS FOR DIMENSIONS OF BUILDING.
   THE CONTRACTOR SHALL CALL THE CITY OF NEWPORT NEWS CONSTRUCTION INSPECTION DEPARTMENT AT 249-5700 TO INSPECT THE SITE BEFORE
- 21. WITHIN GREEN AREAS, ALL EXISTING TREES OF AT LEAST 5" CALIPER (MEASURED 6" ABOVE GRADE) SHALL BE RETAINED.
- 22. ON-SITE EXTERIOR CONCRETE IS TO BE A MINIMUM OF 3500 PSI WITH 5%-7% AIR ENTRAINMENT.
- 23. STRAW BALES WILL BE PLACED AROUND ALL STORM DRAINAGE INLETS AND MAINTAINED THROUGHOUT THE CONSTRUCTION PERIOD.
- 24. THE SITE CONSTRUCTION ENTRANCE(S) WILL HAVE VIRGINIA DEPARTMENT OF TRANSPORTATION NO. 1 STONE (6° DEPTH X 50' LONG).
- 25. ALL DENUDED AREAS OF THE SITE WILL BE TOPSOILED AND SEEDED IN ACCORDANCE WITH THE VIRGINIA EROSION AND SEDIMENT CONTROL

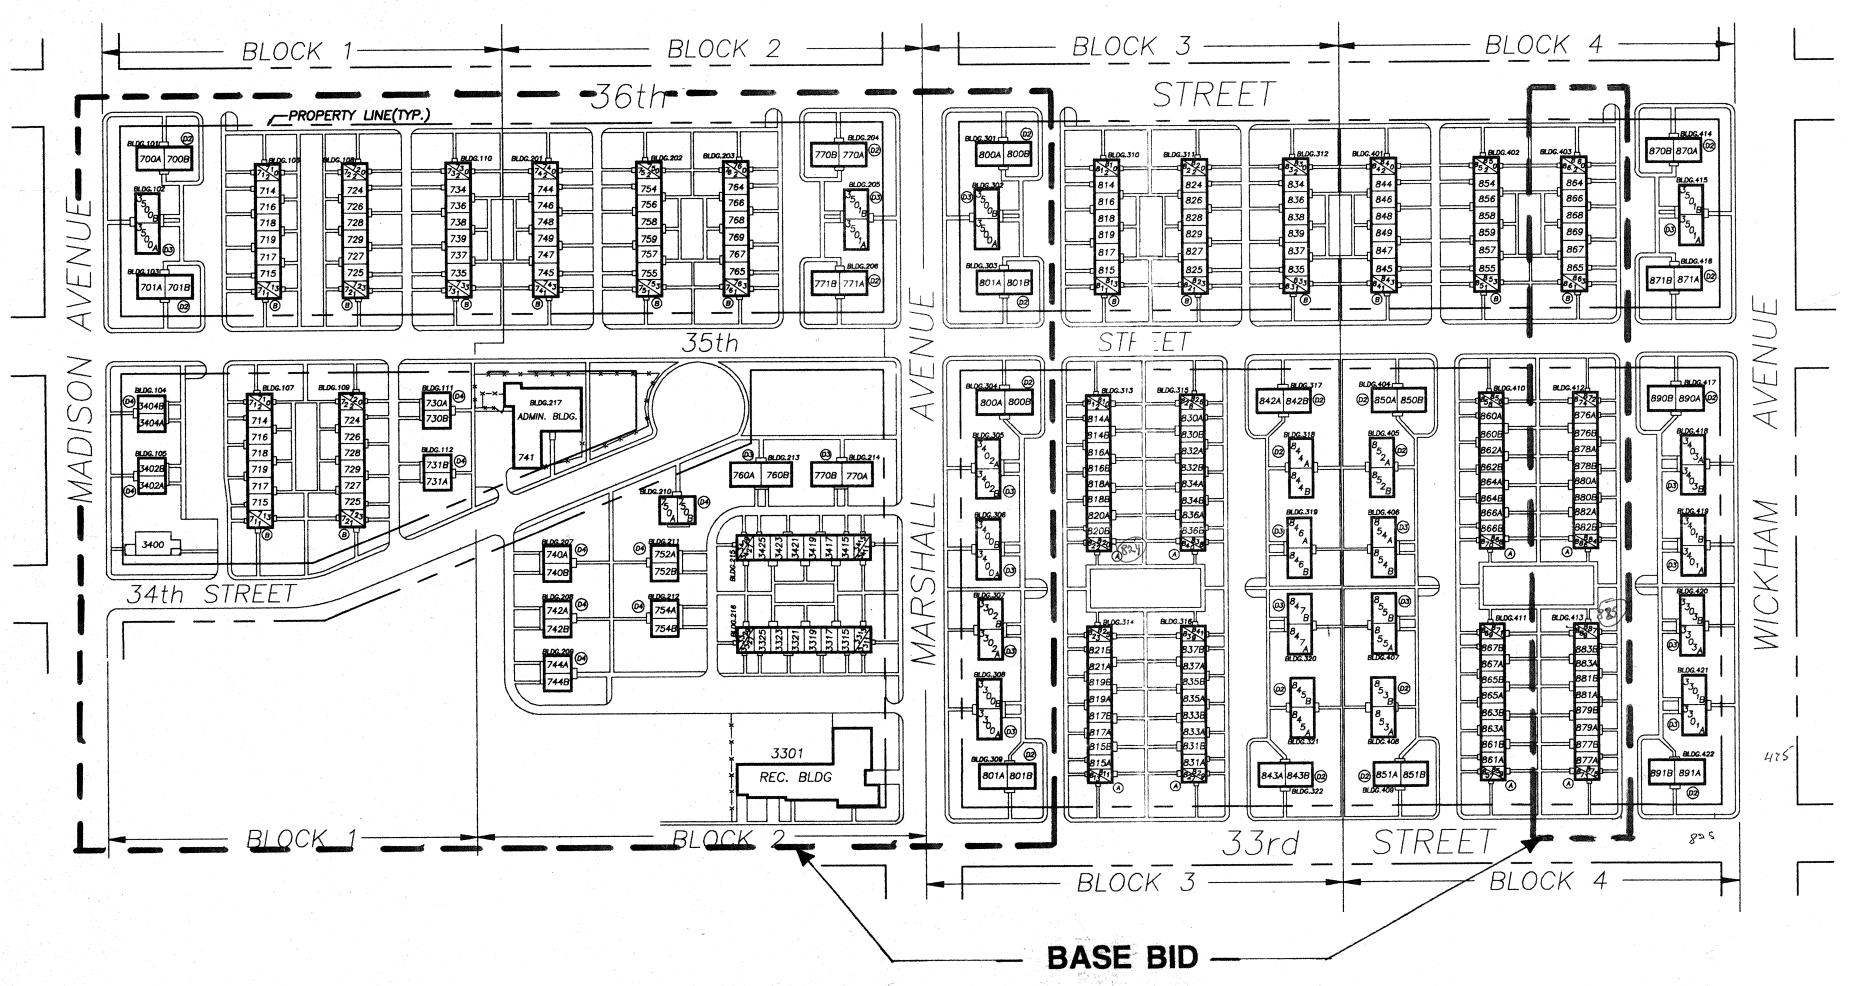

NOTE: BASE BID INCLUDES ALL WORK WITHIN AREASBOUNDED BY HEAVY DASHED LINE

### NOTES:

- 1. DO NOT USE THESE PLANS FOR SCALING DIMENSIONS.
- 2. TALBOT AND ASSOCIATES HAS NOT PERFORMED A BOUNDARY SURVEY FOR THIS PROJECT. PROPERTY LINES, R/W LINES, AND EXISTING FEATURES SHOWN HEREON ARE COMPILED AND ESTIMATED FROM AVAILABLE NNRHA DRAWINGS.
- 3. PROVIDE CONCRETE PADS & CHAIN LINK FENCE ENCLOSURES FOR NEW A.C. CONDENSER EQUIP.


DIDO TVDE DO		VOL DZ
BLDG. TYPE D2	BLDG. T	YPE US
770A 770B (36th ST.)		
770A 770B (35th ST.)	3300A	3300B
771A 771B	3302A	3302B
800A 800B	3400A	3400B
801A 801B	3402A	3402B
	3501A	3501B

SEE DETAIL 7/C-7 & MECHANICAL DRAWINGS FOR EXACT SIZE & LOCATION.

SITE KEY PLAN

EXISTING CONDITIONS


SCALE 1"=100'

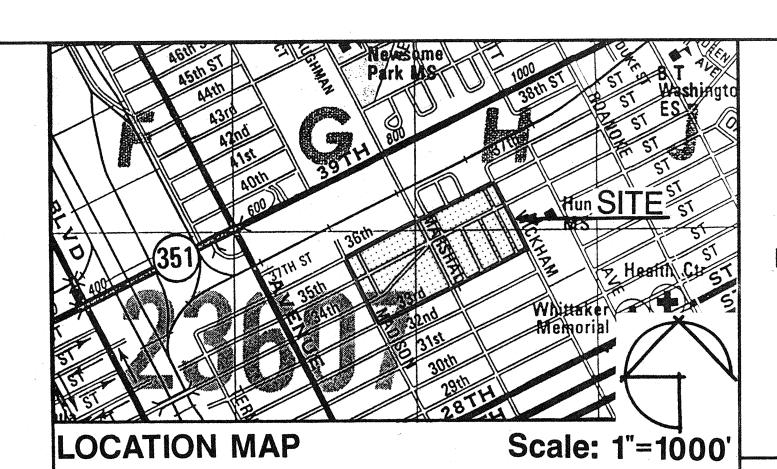



SCHEDULE OF CONTENTS								
В	BUILDI	NGS	DWELLING UNITS					
TYPE	NUMBER	CONTENTS	1 BDRM. 2 BDRM. 3 BDRM			4 BDRM.	TOTAL D.U.'S	
Α	8	4 D.U. 1BR. 8 D.U. 2BR.	32	64	·		96	
В	16	4 D.U. 1BR. 4 D.U. 2BR. 2 D.U. 3BR.	64	64	32		160	
D2	20	2 D.U. 2BR.		40			40	
D3	18	2 D.U. 3BR.	***************************************		36		36	
D4	10	2 D.U. 4BR.			and and a second control of the second contr	20	20	
F	1	1 D.U. 2BR.		1				
	73	TOTALS	96	169	68	20	353	
	PERCENT 27.2 47.9 19.3 5.6 100							
C SERVICE-RECREATION & ADMINSTRATION BLDG.								
AVERAGE NUMBER ROOMS PER DWELLING UNIT  AREA OF SITE WITHIN PROPERTY LINES  AREA COVERED BY DWELLING BUILDINGS  PERCENTAGE OF SITE AREA COVERED BY BUILDINGS  19.6%						Augusta planta a de parte de la companya de la comp		


AREA OF SITE WITHIN PROPERTY LINES
AREA COVERED BY DWELLING BUILDINGS
PERCENTAGE OF SITE AREA COVERED BY BUILDINGS


N.T.S.

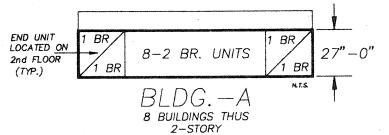


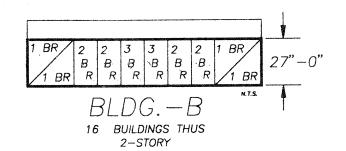

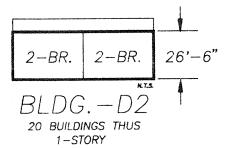

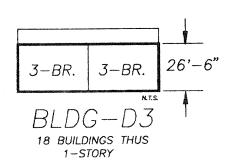

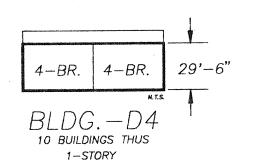

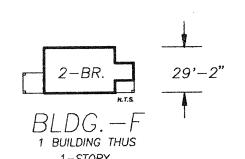

THE TOTAL NUMBER OF DWELLING UNITS TO BE RENOVATED AS PART OF THE BASE BID IS



COMPREHENSIVE RENOVATION OF VA 3-2 MARSHALL COURTS



Designed: J.E.M.

Drawn: A.P.F.Jr.

Checked: W.B.B.

Scale: N.T.S.

Date: JANUARY 31, 1992


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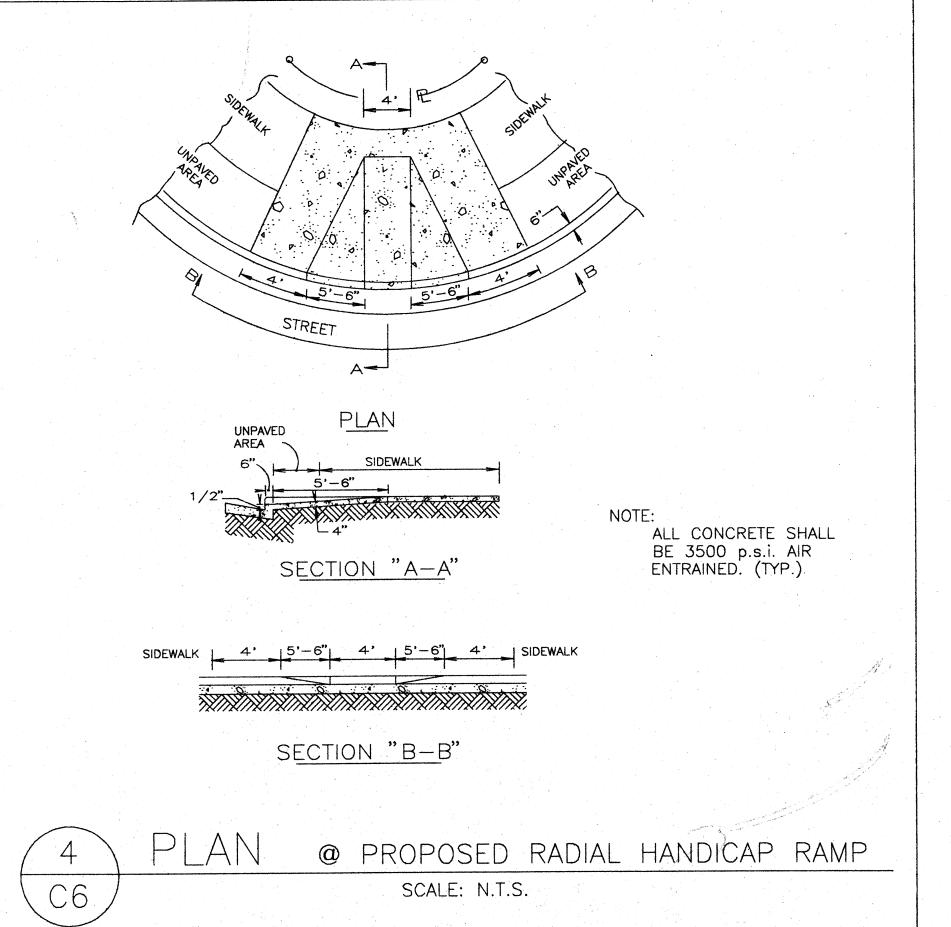
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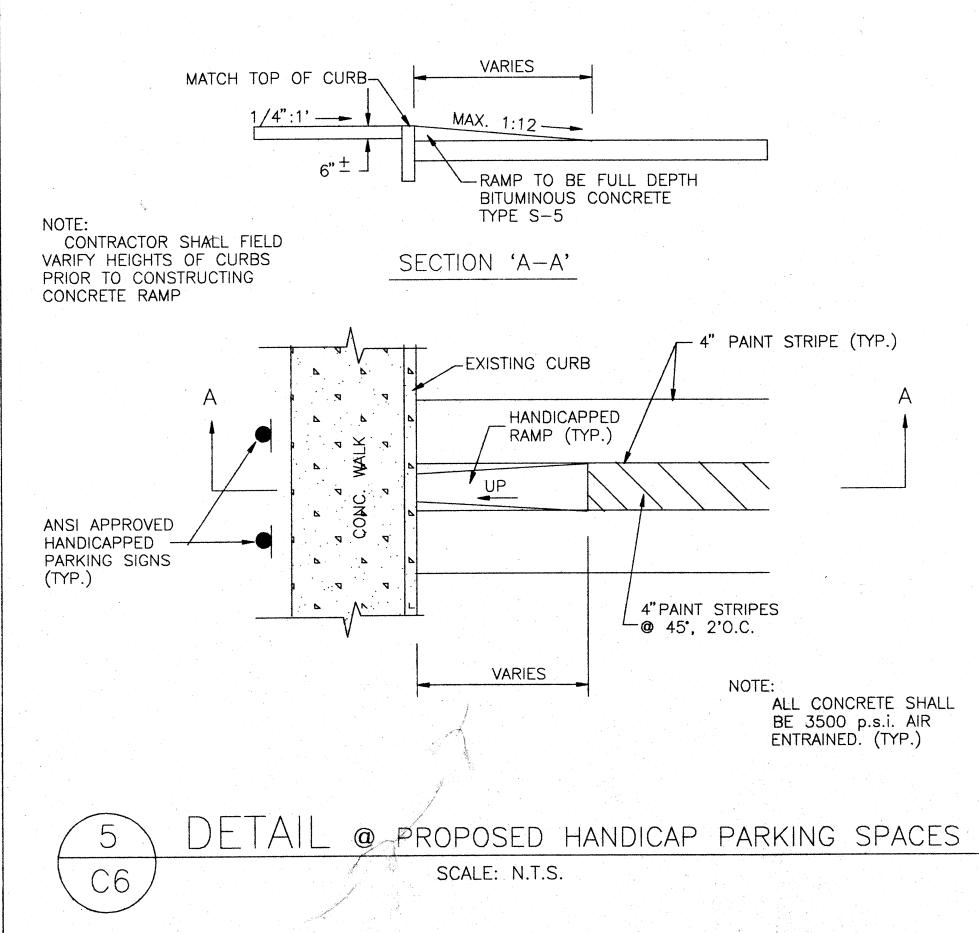
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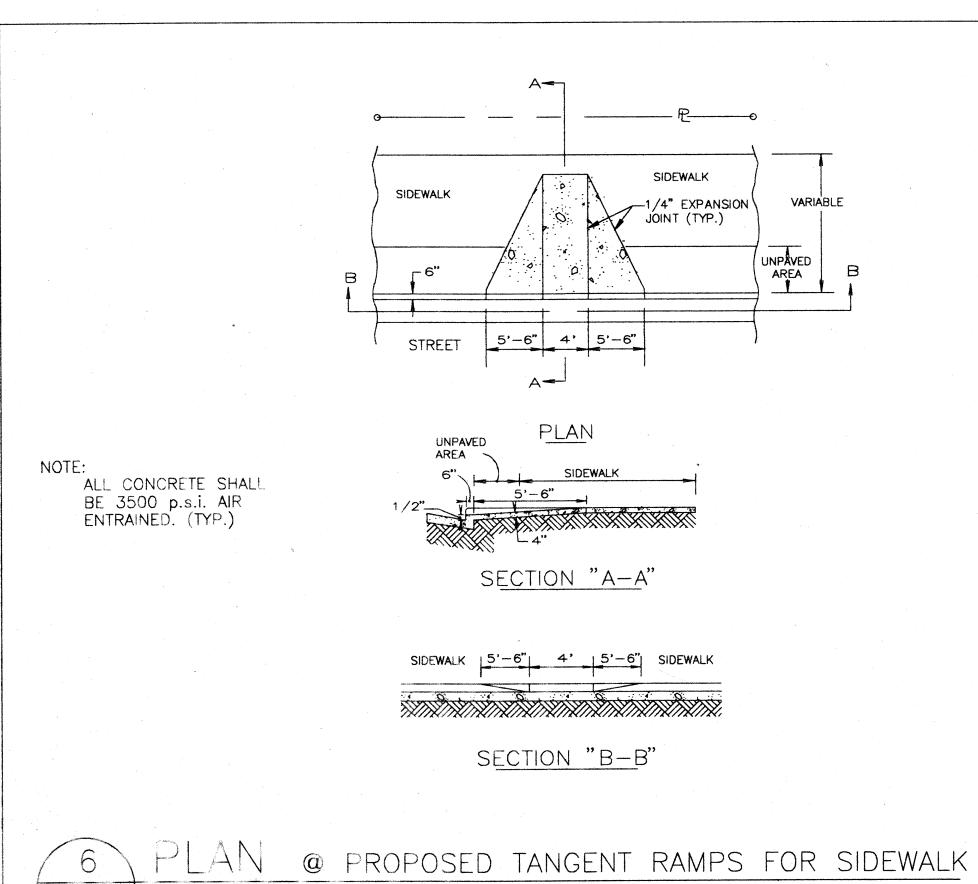
C-1




NOTE: DETAILS 1 THEY 3 - NOT USED





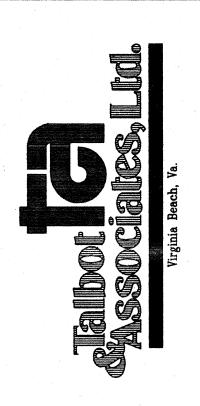

SCALE: N.T.S.

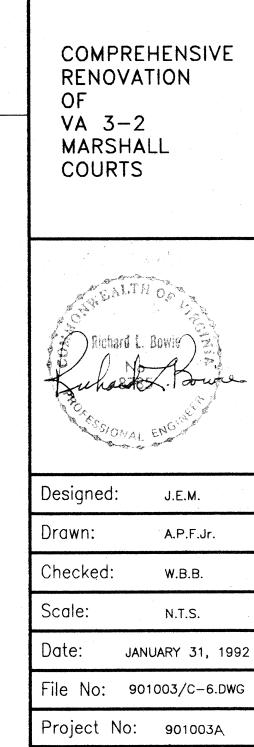



DETAIL SHEET

C-6

Sheets


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1ST FL. - UNIT 2BR/B & 3BR/A

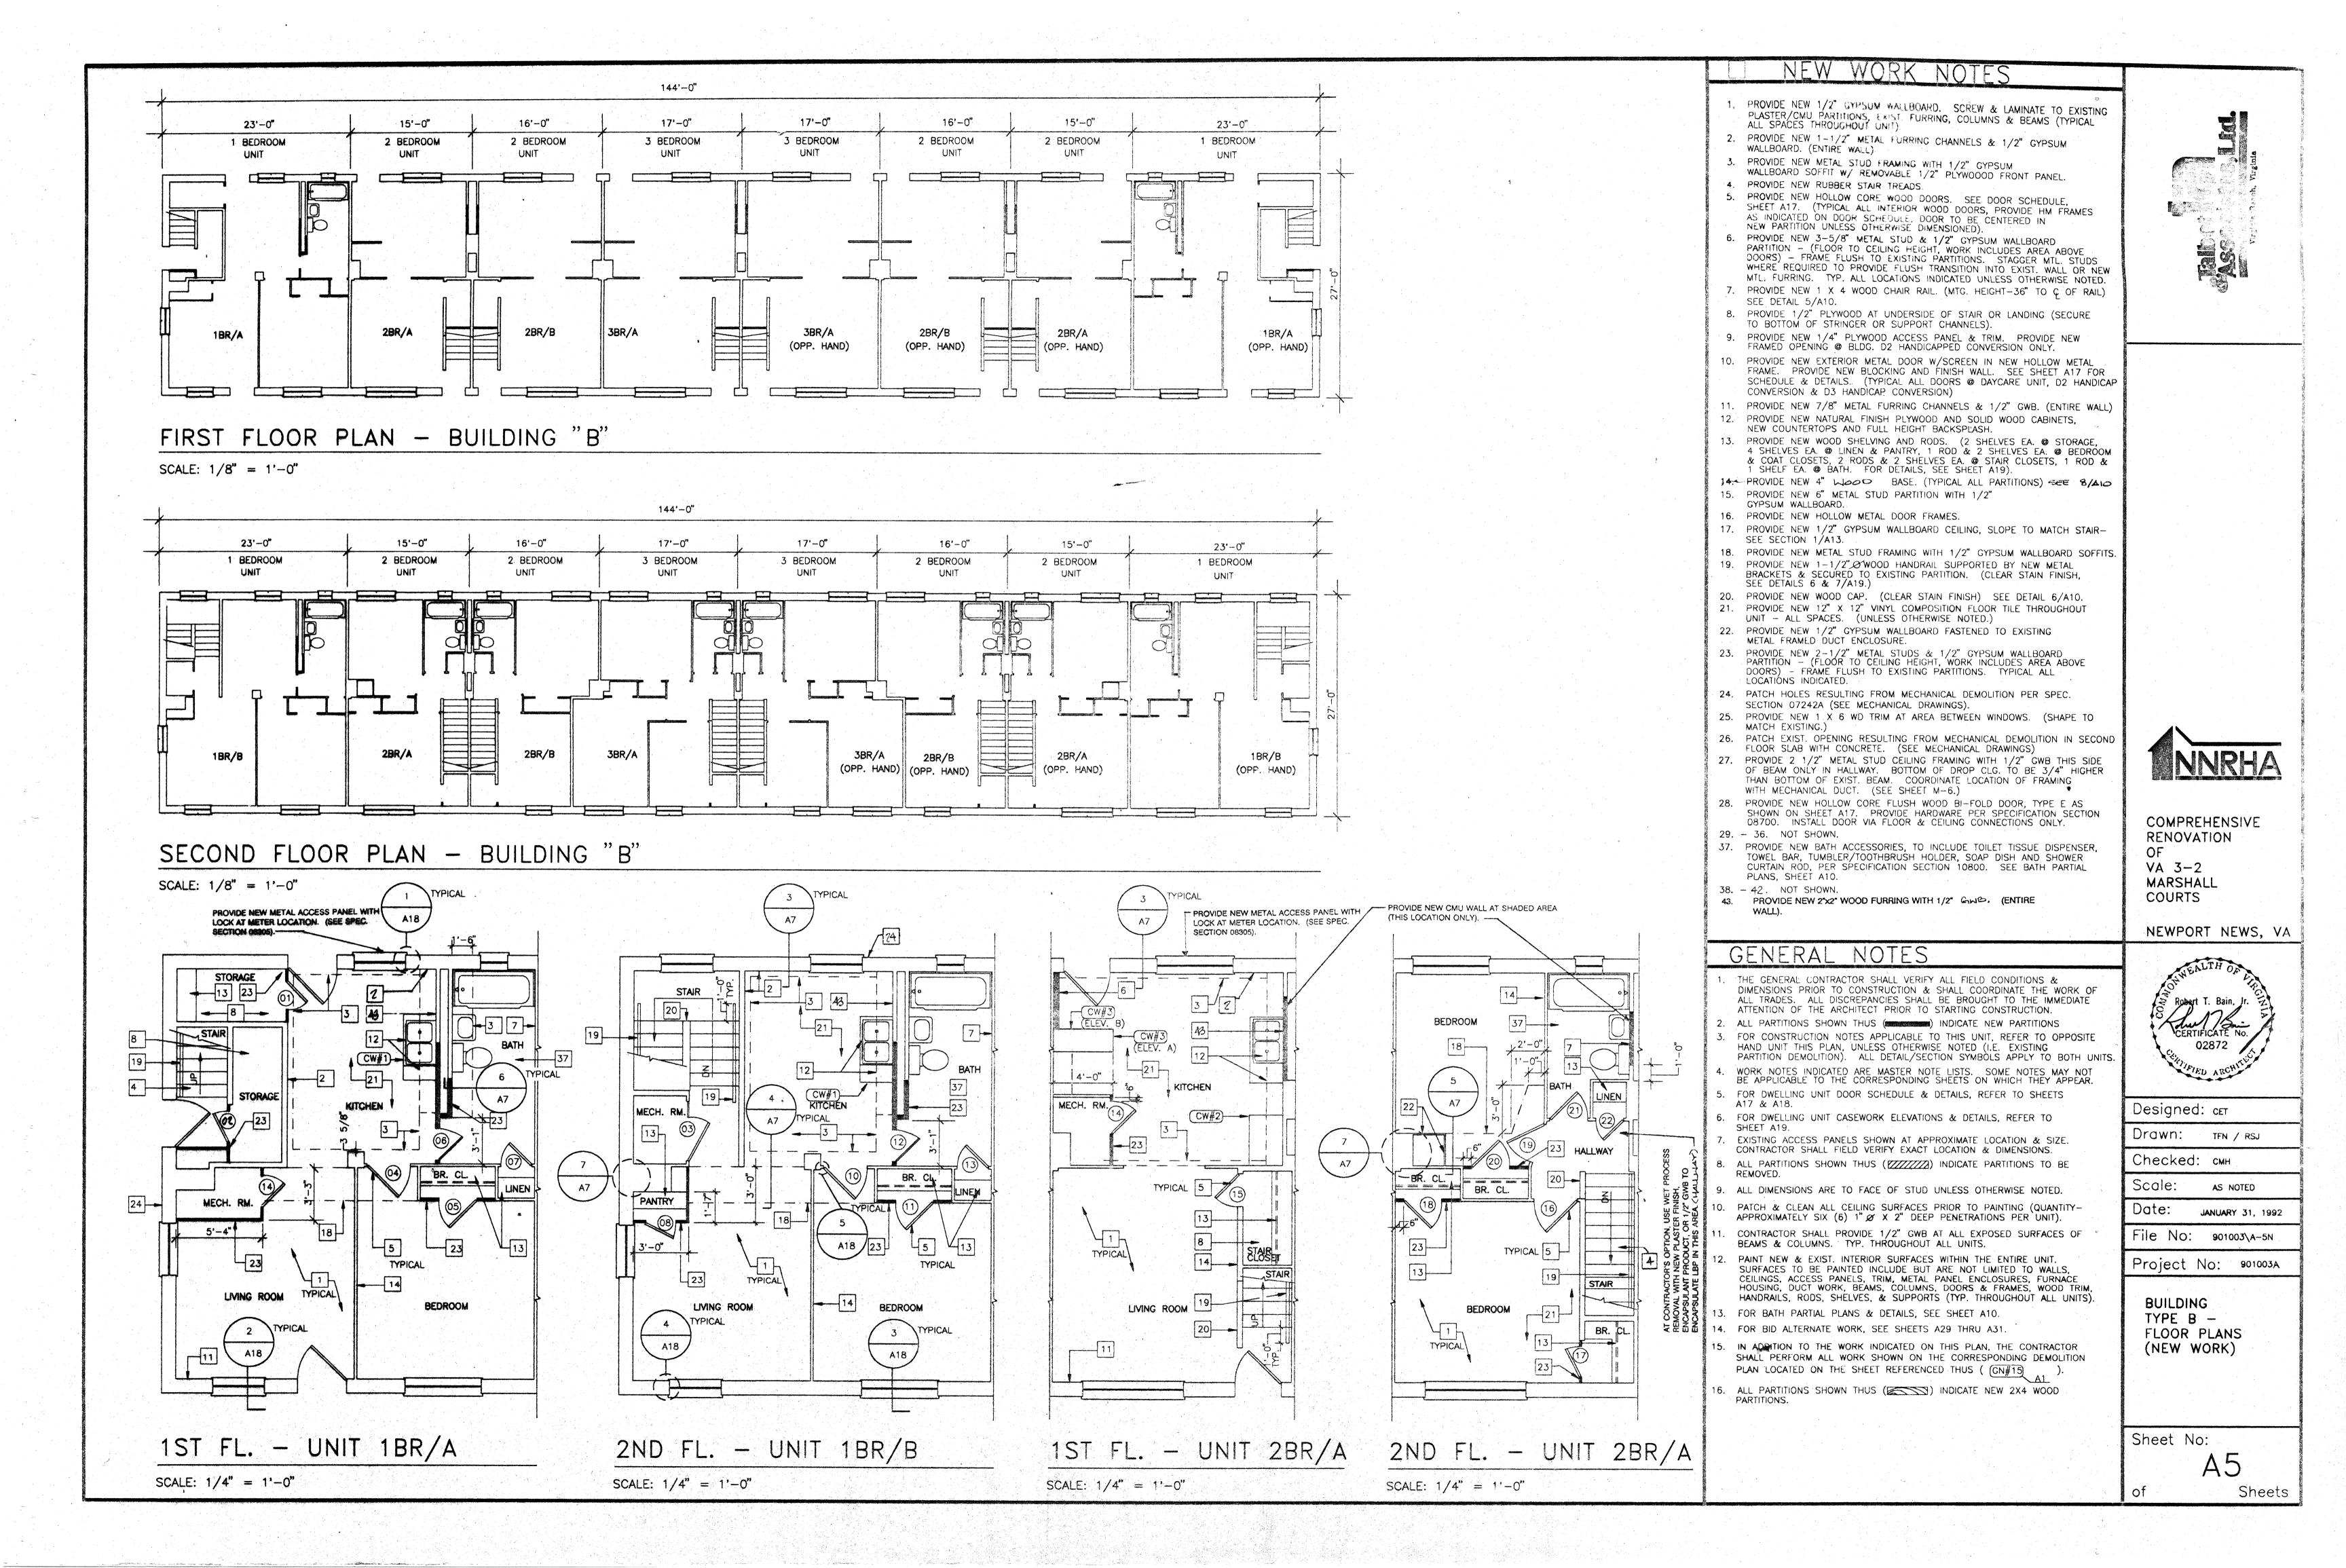SCALE: 1/4" = 1'-0"

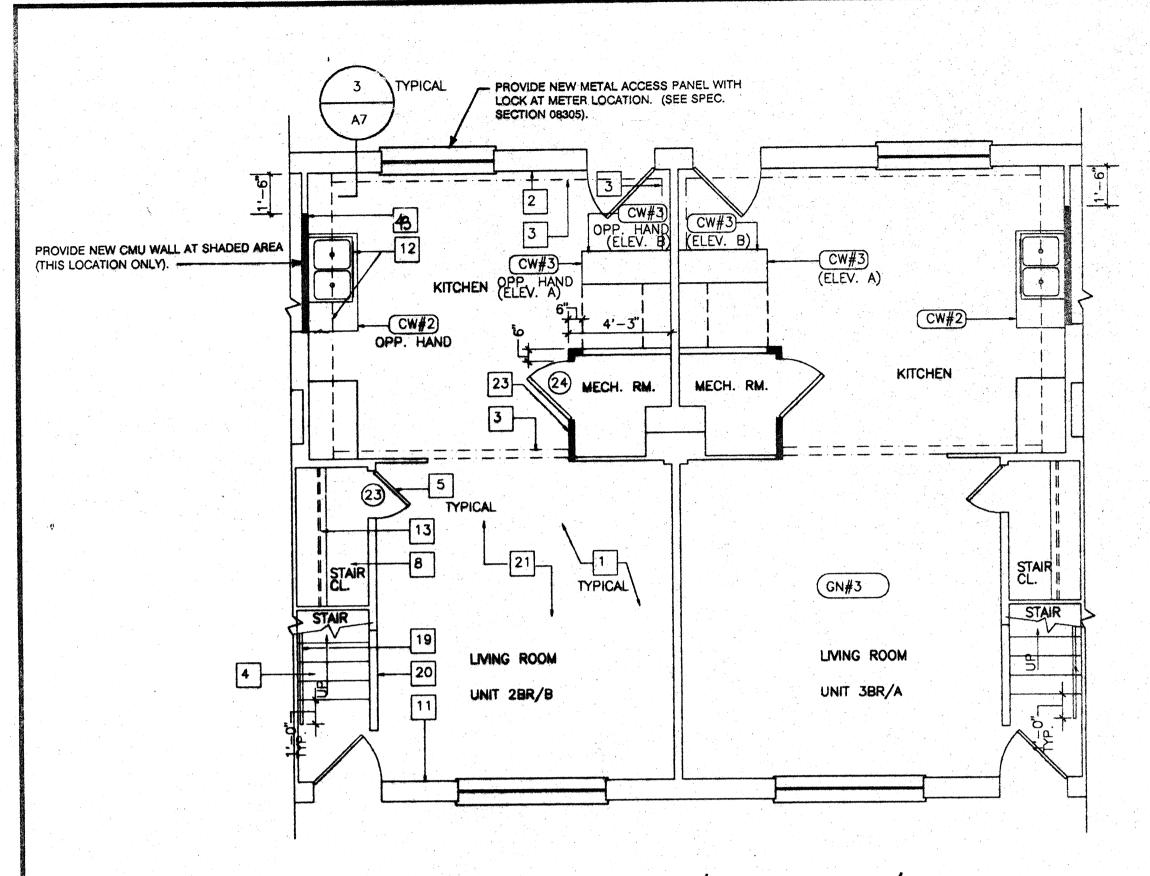

### NEW WORK NOTES


- 1. PROVIDE NEW 1/2" GYPSUM WALLBOARD. SCREW & LAMINATE TO EXISTING PLASTER/CMU PARTITIONS, EXIST. FURRING, COLUMNS & BEAMS (TYPICAL ALL SPACES THROUGHOUT UNIT).
- 2. PROVIDE NEW 1-1/2" METAL FURRING CHANNELS & 1/2" GYPSUM
- WALLBOARD. (ENTIRE WALL)
- 3. PROVIDE NEW METAL STUD FRAMING WITH 1/2" GYPSUM WALLBOARD SOFFIT W/ REMOVABLE 1/2" PLYWOOOD FRONT PANEL.
- 4. PROVIDE NEW RUBBER STAIR TREADS.
- 5. PROVIDE NEW HOLLOW CORE WOOD DOORS. SEE DOOR SCHEDULE, SHEET A17. (TYPICAL ALL INTERIOR WOOD DOORS, PROVIDE HM FRAMES AS INDICATED ON DOOR SCHEDULE, DOOR TO BE CENTERED IN NEW PARTITION UNLESS OTHERWISE DIMENSIONED).
- 6. PROVIDE NEW 3-5/8" METAL STUD & 1/2" GYPSUM WALLBOARD PARTITION - (FLOOR TO CEILING HEIGHT, WORK INCLUDES AREA ABOVE DOORS) - FRAME FLUSH TO EXISTING PARTITIONS. STAGGER MTL. STUDS WHERE REQUIRED TO PROVIDE FLUSH TRANSITION INTO EXIST. WALL OR NEW MTL. FURRING. TYP. ALL LOCATIONS INDICATED UNLESS OTHERWISE NOTED.
- 7. PROVIDE NEW 1 X 4 WOOD CHAIR RAIL (MTG. HEIGHT-36" TO C OF RAIL) SEE DETAIL 5/A10.
- 8. PROVIDE 1/2" PLYWOOD AT UNDERSIDE OF STAIR OR LANDING (SECURE TO BOTTOM OF STRINGER OR SUPPORT CHANNELS).
- 9. PROVIDE NEW 1/4" PLYWOOD ACCESS PANEL & TRIM. PROVIDE NEW FRAMED OPENING @ BLDG. D2 HANDICAPPED CONVERSION ONLY.
- 10. PROVIDE NEW EXTERIOR METAL DOOR W/SCREEN IN NEW HOLLOW METAL FRAME. PROVIDE NEW BLOCKING AND FINISH WALL. SEE SHEET A17 FOR SCHEDULE & DETAILS. (TYPICAL ALL DOORS @ DAYCARE UNIT, D2 HANDICAP CONVERSION & D3 HANDICAP CONVERSION)
- 11. PROVIDE NEW 7/8" METAL FURRING CHANNELS & 1/2" GWB. (ENTIRE WALL)
- 12. PROVIDE NEW NATURAL FINISH PLYWOOD AND SOLID WOOD CABINETS, NEW COUNTERTOPS AND FULL HEIGHT BACKSPLASH.
- 13. PROVIDE NEW WOOD SHELVING AND RODS. (2 SHELVES EA. @ STORAGE, 4 SHELVES EA. @ LINEN & PANTRY, 1 ROD & 2 SHELVES EA. @ BEDROOM & COAT CLOSETS, 2 RODS & 2 SHELVES EA. @ STAIR CLOSETS, 1 ROD & 1 SHELF EA. @ BATH. FOR DETAILS, SEE SHEET A19).
- 14. PROVIDE NEW 4" WOOD BASE. (TYPICAL ALL PARTITIONS) SEE 8/410
- 15. PROVIDE NEW 6" METAL STUD PARTITION WITH 1/2"
- GYPSUM WALLBOARD.

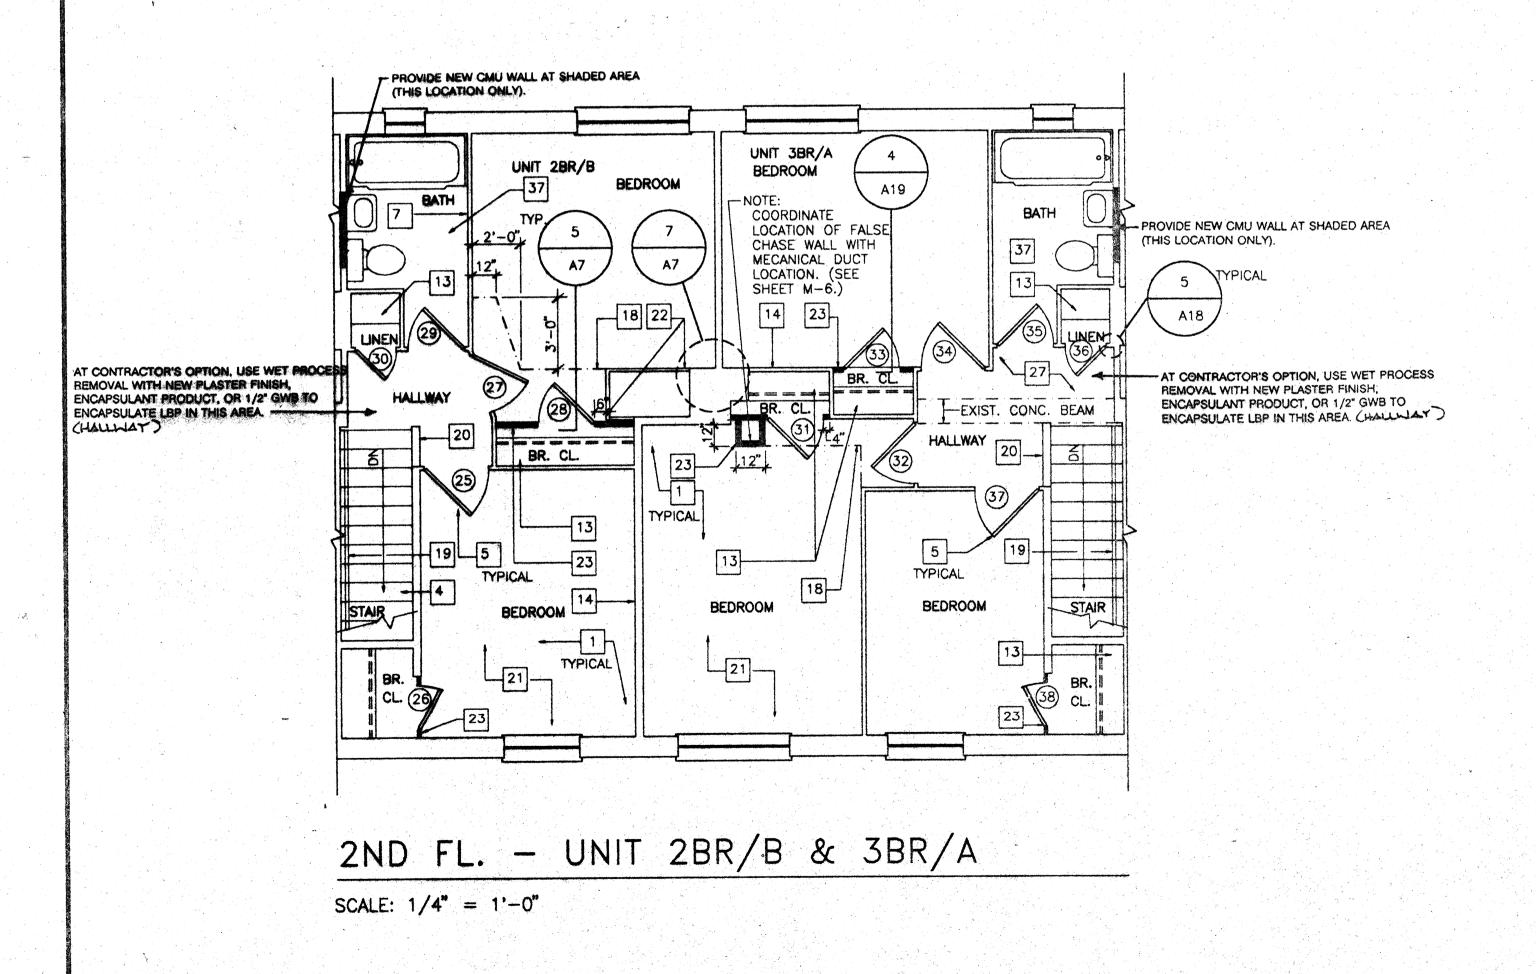SEE DETAILS 6 & 7/A19.)

- 16. PROVIDE NEW HOLLOW METAL DOOR FRAMES.
- 17. PROVIDE NEW 1/2" GYPSUM WALLBOARD CEILING, SLOPE TO MATCH STAIR-SEE SECTION 1/A13.
- 18. PROVIDE NEW METAL STUD FRAMING WITH 1/2" GYPSUM WALLBOARD SOFFITS. 19. PROVIDE NEW 1-1/2" WOOD HANDRAIL SUPPORTED BY NEW METAL BRACKETS & SECURED TO EXISTING PARTITION. (CLEAR STAIN FINISH,
- 20. PROVIDE NEW WOOD CAP. (CLEAR STAIN FINISH) SEE DETAIL 6/A10. 21. PROVIDE NEW 12" X 12" VINYL COMPOSITION FLOOR TILE THROUGHOUT
- UNIT ALL SPACES. (UNLESS OTHERWISE NOTED.)
- 22. PROVIDE NEW 1/2" GYPSUM WALLBOARD FASTENED TO EXISTING METAL FRAMED DUCT ENCLOSURE.
- 23. PROVIDE NEW 2-1/2" METAL STUDS & 1/2" GYPSUM WALLBOARD PARTITION (FLOOR TO CEILING HEIGHT, WORK INCLUDES AREA ABOVE DOORS) - FRAME FLUSH TO EXISTING PARTITIONS. TYPICAL ALL LOCATIONS INDICATED.
- 24. PATCH HOLES RESULTING FROM MECHANICAL DEMOLITION PER SPEC.
- SECTION 07242A (SEE MECHANICAL DRAWINGS).
- 25. PROVIDE NEW 1 X 6 WD TRIM AT AREA BETWEEN WINDOWS. (SHAPE TO
- MATCH EXISTING.) 26. PATCH EXIST. OPENING RESULTING FROM MECHANICAL DEMOLITION IN SECOND
- FLOOR SLAB WITH CONCRETE. (SEE MECHANICAL DRAWINGS) 27. PROVIDE 2 1/2" METAL STUD CEILING FRAMING WITH 1/2" GWB THIS SIDE OF BEAM ONLY IN HALLWAY. BOTTOM OF DROP CLG. TO BE 3/4" HIGHER
- THAN BOTTOM OF EXIST. BEAM. COORDINATE LOCATION OF FRAMING WITH MECHANICAL DUCT. (SEE SHEET M-6.) 28. PROVIDE NEW HOLLOW CORE FLUSH WOOD BI-FOLD DOOR, TYPE E AS
- SHOWN ON SHEET A17. PROVIDE HARDWARE PER SPECIFICATION SECTION 08700. INSTALL DOOR VIA FLOOR & CEILING CONNECTIONS ONLY. 29. - 36. NOT SHOWN.
- 37. PROVIDE NEW BATH ACCESSORIES, TO INCLUDE TOILET TISSUE DISPENSER, TOWEL BAR, TUMBLER/TOOTHBRUSH HOLDER, SOAP DISH AND SHOWER CURTAIN ROD, PER SPECIFICATION SECTION 10800. SEE BATH PARTIAL PLANS, SHEET A10.
- 38. 42. NOT SHOWN. PROVIDE NEW 2"X2" WOOD FURRING WITH 1/2" GHE. (ENTIRE

A17 & A18.

- 1. THE GENERAL CONTRACTOR SHALL VERIFY ALL FIELD CONDITIONS & DIMENSIONS PRIOR TO CONSTRUCTION & SHALL COORDINATE THE WORK OF ALL TRADES. ALL DISCREPANCIES SHALL BE BROUGHT TO THE IMMEDIATE ATTENTION OF THE ARCHITECT PRIOR TO STARTING CONSTRUCTION.
- 2. ALL PARTITIONS SHOWN THUS ( ) INDICATE NEW PARTITIONS
- 3. FOR CONSTRUCTION NOTES APPLICABLE TO THIS UNIT, REFER TO OPPOSITE HAND UNIT THIS PLAN, UNLESS OTHERWISE NOTED (I.E. EXISTING PARTITION DEMOLITION). ALL DETAIL/SECTION SYMBOLS APPLY TO BOTH UNITS
- WORK NOTES INDICATED ARE MASTER NOTE LISTS. SOME NOTES MAY NOT BE APPLICABLE TO THE CORRESPONDING SHEETS ON WHICH THEY APPEAR.
- 5. FOR DWELLING UNIT DOOR SCHEDULE & DETAILS, REFER TO SHEETS
- 6. FOR DWELLING UNIT CASEWORK ELEVATIONS & DETAILS, REFER TO
- 7. EXISTING ACCESS PANELS SHOWN AT APPROXIMATE LOCATION & SIZE. CONTRACTOR SHALL FIELD VERIFY EXACT LOCATION & DIMENSIONS.
- 9. ALL DIMENSIONS ARE TO FACE OF STUD UNLESS OTHERWISE NOTED.
- 10. PATCH & CLEAN ALL CEILING SURFACES PRIOR TO PAINTING (QUANTITY-APPROXIMATELY SIX (6) 1" Ø X 2" DEEP PENETRATIONS PER UNIT).
- 11. CONTRACTOR SHALL PROVIDE 1/2" GWB AT ALL EXPOSED SURFACES OF BEAMS & COLUMNS. TYP. THROUGHOUT ALL UNITS.
- 12. PAINT NEW & EXIST. INTERIOR SURFACES WITHIN THE ENTIRE UNIT. SURFACES TO BE PAINTED INCLUDE BUT ARE NOT LIMITED TO WALLS. CEILINGS, ACCESS PANELS, TRIM, METAL PANEL ENCLOSURES, FURNACE HOUSING, DUCT WORK, BEAMS, COLUMNS, DOORS & FRAMES, WOOD TRIM, HANDRAILS, RODS, SHELVES, & SUPPORTS (TYP. THROUGHOUT ALL UNITS).
- 13. FOR BATH PARTIAL PLANS & DETAILS, SEE SHEET A10.
- 14. FOR BID ALTERNATE WORK, SEE SHEETS A29 THRU A31.
- 15. IN ADDITION TO THE WORK INDICATED ON THIS PLAN, THE CONTRACTOR SHALL PERFORM ALL WORK SHOWN ON THE CORRESPONDING DEMOLITION PLAN LOCATED ON THE SHEET REFERENCED THUS ( GN#15) A1
- 16. ALL PARTITIONS SHOWN THUS ( ) INDICATE NEW 2X4 WOOD

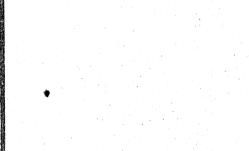


COMPREHENSIVE RENOVATION

VA 3-2

COURTS

MARSHALL

NEWPORT NEWS, VA

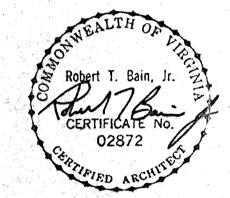

Designed: cer

Drawn: TFN / RSJ

Checked: CMH

Date:

Scale: AS NOTED


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JANUARY 31, 1992

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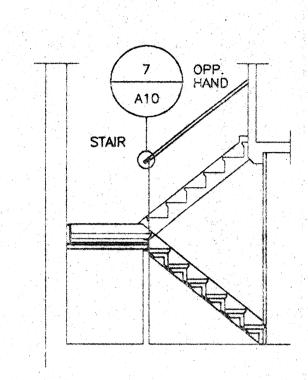
BUILDING TYPE B -FLOOR PLANS (NEW WORK)

Sheet No:



TYPICAL 2-STORY UNIT SECTION - BLDGS. A&B

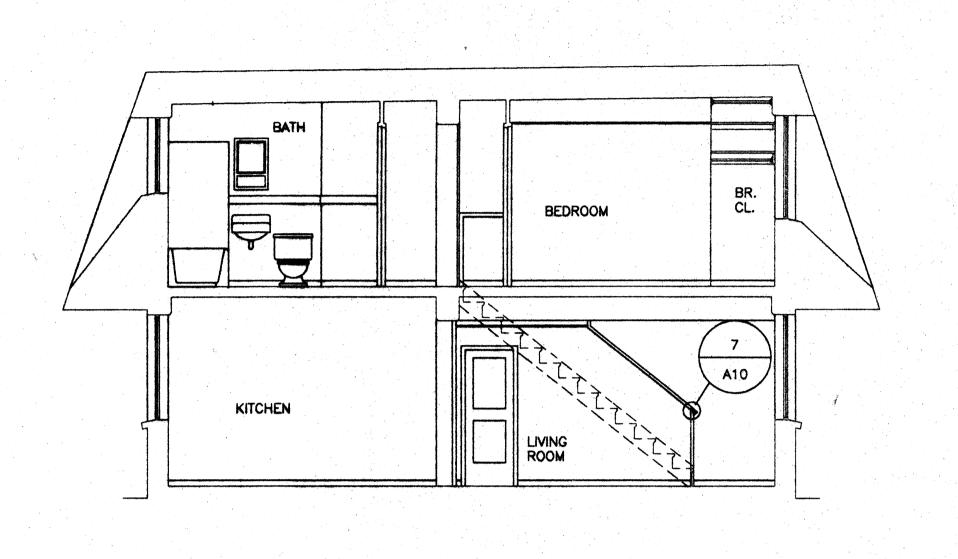A7  $\int SCALE: 1/4" = 1'-0"$ 



STAIR SECTION -1BR. - BLDGS. A&B SCALE: 1/4" = 1'-0"

WORK NOTE

06200L

(09250E

### GENERAL NOTES

- THE GENERAL CONTRACTOR SHALL VERIFY ALL FIELD CONDITIONS & DIMENSIONS PRIOR TO CONSTRUCTION & SHALL COORDINATE THE WORK OF ALL TRADES, ALL DISCREPANCIES SHALL BE BROUGHT TO THE IMMEDIATE ATTENTION OF THE ARCHITECT PRIOR TO STARTING CONSTRUCTION.
- 2. ALL PARTITIONS SHOWN THUS ( ) INDICATE NEW PARTITIONS 3. FOR CONSTRUCTION NOTES APPLICABLE TO THIS UNIT. REFER TO OPPOSITE HAND UNIT THIS PLAN, UNLESS OTHERWISE NOTED (I.E. EXISTING PARTITION DEMOLITION). ALL DETAIL/SECTION SYMBOLS APPLY TO BOTH UNITS.
- 4. WORK NOTES INDICATED ARE MASTER NOTE LISTS. SOME NOTES MAY NOT BE APPLICABLE TO THE CORRESPONDING SHEETS ON WHICH THEY APPEAR.
- 5. FOR DWELLING UNIT DOOR SCHEDULE & DETAILS, REFER TO SHEETS A17 & A18.
- 6. FOR DWELLING UNIT CASEWORK ELEVATIONS & DETAILS, REFER TO SHEET A19.
- 7. EXISTING ACCESS PANELS SHOWN AT APPROXIMATE LOCATION & SIZE. CONTRACTOR SHALL FIELD VERIFY EXACT LOCATION & DIMENSIONS.
- 9. ALL DIMENSIONS ARE TO FACE OF STUD UNLESS OTHERWISE NOTED.
- 10. PATCH & CLEAN ALL CEILING SURFACES PRIOR TO PAINTING (QUANTITY-APPROXIMATELY SIX (6) 1" & X 2" DEEP PENETRATIONS PER UNIT).
- 11. CONTRACTOR SHALL PROVIDE 1/2" GWB AT ALL EXPOSED SURFACES OF BEAMS & COLUMNS. TYP. THROUGHOUT ALL UNITS.
- 12. PAINT NEW & EXIST. INTERIOR SURFACES WITHIN THE ENTIRE UNIT. SURFACES TO BE PAINTED INCLUDE BUT ARE NOT LIMITED TO WALLS, CEILINGS, ACCESS PANELS, TRIM, METAL PANEL ENCLOSURES, FURNACE HOUSING, DUCT WORK, BEAMS, COLUMNS, DOORS & FRAMES, WOOD TRIM. HANDRAILS, RODS, SHELVES, & SUPPORTS (TYP. THROUGHOUT ALL UNITS).
- 13. FOR BATH PARTIAL PLANS & DETAILS, SEE SHEET A10.
- 14. FOR BID ALTERNATE WORK, SEE SHEETS A29 THRU A31.
- 15. IN ADDITION TO THE WORK INDICATED ON THIS PLAN, THE CONTRACTOR SHALL PERFORM ALL WORK SHOWN ON THE CORRESPONDING DEMOLITION PLAN LOCATED ON THE SHEET REFERENCED THUS ( GN#15) A1
- 16. ALL PARTITIONS SHOWN THUS ( ) INDICATE NEW 2X4 WOOD
- IT. SEE SHEET A13 FOR TYPICAL GWB/SEAL INSTALLATION DETAILS.

### MATERIAL KEY LEGEND

2: SITEWORK

02200A COMPACTED FILL B POROUS FILL (4") C EARTH BACKFILL 02520A CONCRETE WALK-SEE SITE PLAN SHEET B EXPANSION JOINT MATERIAL

03310A CONCRETE FOOTING OR SLAB REINFORCING BARS (#3) VERTICAL AT CORNERS REINFORCING BARS (#3) HORIZONTAL REINFORCING BARS (#4) 6" O.C. EACH WAY

EXPANSION JOINT
STEEL DOWEL SET IN GROUT
CONCRETE STOOP W/THICKENED SLAB AT COLUMN 4: MASONRY 04200A CMU (4")

EXPANSION BOLT THRU BOLT-1/4" THREADED ROD 5: METALS

05120A STEEL ANGLE STEEL PLATE
STEEL PIPE COLUMN (3" DIA.)
STEEL PLATE (3" X 4 1/2" X 3/4")
ANCHOR BOLTS (3/8" DIA.) BASE PLATE (6" X 7" X 3/8") W/ 2 (1/2") J-BARS ROD, THREADED (1/2" DIA.) STEEL BEAM (W 10 X 22)

STEEL PLATE (4" X 6" X 3/4") STEEL PLATE (5" X 8" X 3/4") K STEEL BOLT, NUT & WASHER (5/8" DIA.)

M EROSION RESISTANT ANCHORING CEMENT N GROUT (PORTLAND CEMENT)

6: WOOD AND PLASTICS
06100A WOOD BEAM (2"X8") DOUBLE W/THRU BOLTS 1'-0" O.C.
B WOOD BEAM (2"X12") DOUBLE WOOD JOIST (2"X8") WOOD LEDGER (2"X8") WOOD PARTITION (2"X4")

1"X6" COLLAR BOARD BUILT-UP 2"X4" WOOD POST JOIST HANGER FOR 4" THICK JOIST JOIST HGR.-2" THICK JOIST WOOD CANT

K WOOD BLOCKING EXTERIOR PLYWOOD SHEATHING 06200A WOOD KNEE WALL CAP WOOD STAIR HANDRAIL HANDRAIL MOUNTING BRACKET CLOSET ROD AND SUPPORTS

NOT USED PLYWOOD SHELVES (3/4") M.D.O. G PLYWOOD VERTICAL SUPPORT (3/4") M.D.O. H PLYWOOD SOFFIT FACE (1/2") M.D.O. WOOD LEDGER (1"X3") WOOD CHAIR RAIL (1"X4") PLYWOOD ATTIC ACCESS DOOR (3/4") M.D.O. PAN HEAD SCREW W/WASHER (3/16"X3/4")

WOOD VENEER STRIP PLYWOOD (3/4") NOT USED P WOOD TRIM (1 X CUT TO FIT)
06402A PLASTIC LAMINATE ON 3/4" PARTICLE BOARD
B BASE CABINET

WALL CABINET VENEER PLYWOOD SOLID WOOD BLOCKING SOLID WOOD FACE FRAME

7: THERMAL AND MOISTURE PROTECTION 07242A EXTERIOR FINISH SYSTEM/STUCCO EXTERIOR FINISH SYSTEM/SMOOTH COAT

EXTERIOR FINISH SYSTEM/BRICK 07460A ALUMINUM FASCIA VINYL SOFFIT W/ "J" TRIM @ PERIMETER

ALUMINUM BREAK METAL TRIM 07530A SINGLE PLY MEMBRANE MEMBRANE FLASHING METAL GUTTER & DOWNSPOUT E.P.D.M. RUBBER PIPE FLASHING W/ALUM. RING

BASE (ATTACH W/ SST FASTENERS)
ADJUSTABLE SST CLAMP
GALVANIZED SHEET MTL. COVER W/ MTL. CLEAT G SCUPPER

07900A SEALANT EXPANSION JOINT

DOORS AND WINDOWS 08110A STEEL DOOR FRAME B WALL ANCHORS (3 PER JAMB)
C STEEL DOOR - SEE DOOR SCHEDULE
08211A WOOD DOOR - SEE DOOR SCHEDULE

08390A SCREEN DOOR & FRAME
08520A ALUMINUM WINDOW (EQ. TO SERIES 400-U.S. ALUM. CO.)
08710A ALUMINUM THRESHOLD CABINET HINGE

NOT USED CABINET MAGNETIC CATCH LOCK ASSEMBLY & STRIKE G EXPANSION ANCHOR

9: FINISHES 9: FINISHES
09250A GYPSUM WALLBOARD (1/2") MOISTURE RESISTANT
B GYPSUM WALLBOARD (1/2") STANDARD
C METAL HAT-FURRING (7/8") 16" O.C. MAX.
D METAL FURRING (1 1/2") 16" O.C. MAX
E EDGE TRIM, "J" MOLD
F METAL STUD (2 1/2") 24" O.C. MAX
G METAL STUD (3 5/8") 24" O.C. MAX.
H GYPSUM WALLBOARD (1/2") TYPE "X" FIRE CODE

09512A ACOUSTICAL CEILING SYSTEM-SEE FINISH SCHEDULE 09650A VINYL COMPOSITION TILE (3/32"X12"X12") HOT USED

RESILIENT EDGE STRIP SPECIALTIES
SOA TOILET PARTITIONS 10160A TOILET PARTITION 10200A LOUVER, METAL 10800A SOAP DISH

TOILET TISSUE HOLDER TUMBLER & TOOTHBRUSH HOLDER TOWEL BAR GRAB BAR SHOWER CURTAIN ROD

TILT MIRROR W/ SST FRAME (18" X 30") MIRROR W/ SST FRAME (18" X 30") PAPER TOWEL DISPENSER TOILET TISSUE DISPENSER K SANITARY NAPKIN DISPOSAL WALL ASH URN


15: MECHANICAL 15800A VENT PIPE (SEE MECH. DWGS) 15840A SHEET METAL DUCT (SEE MECH. DWGS)



COMPREHENSIVE RENOVATION OF VA 3-2MARSHALL

COURTS

NEWPORT NEWS, VA

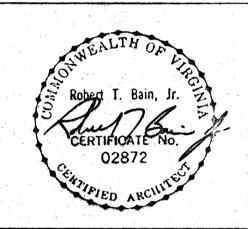

Designed: CET Drawn: TEN / RSJ

Checked: CMH

Scale: AS NOTED Date: JANUARY 31, 1992


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BUILDING TYPES A & B -BUILDING SECTIONS & DETAILS

Sheet No:

A


Sheets

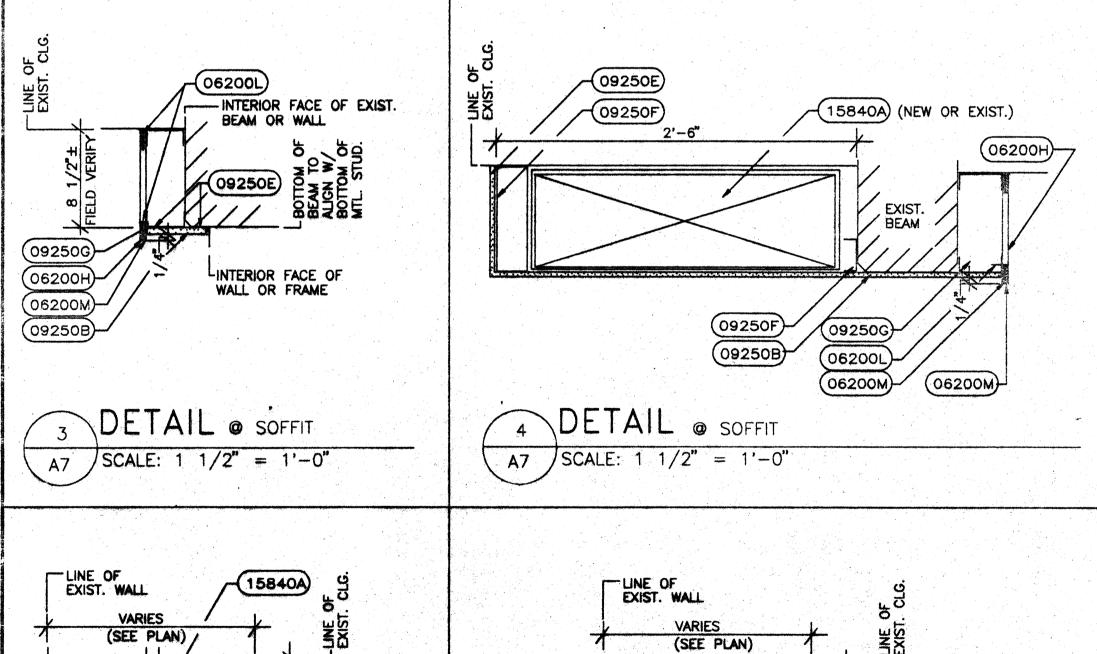


09250E)

DETAIL & SOFFIT

A7 SCALE:  $1 \frac{1}{2}$  = 1'-0'

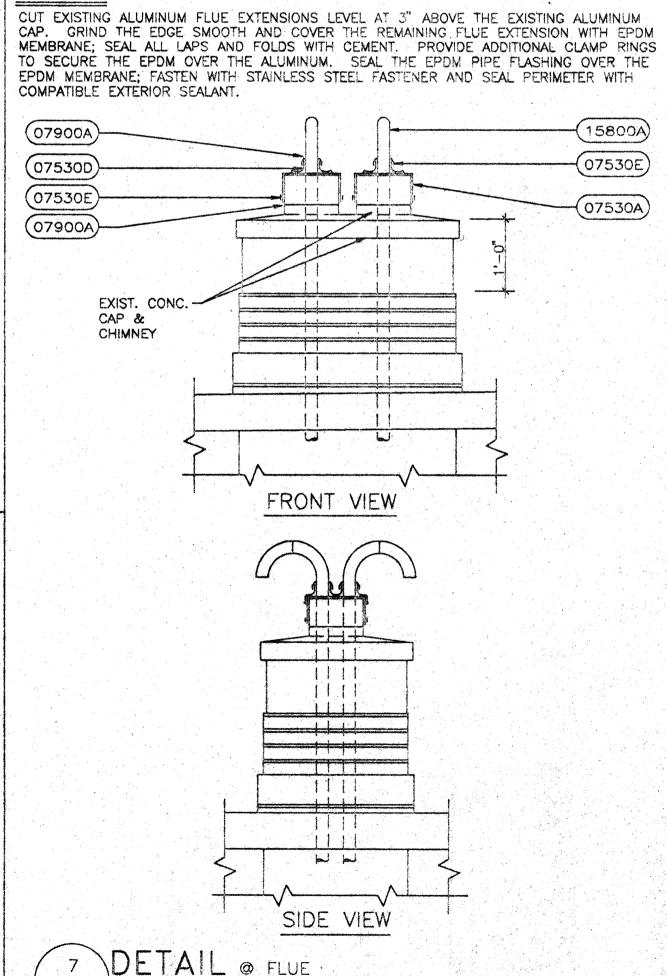

SCALE:  $1 \ 1/2'' = 1'-0'$ 

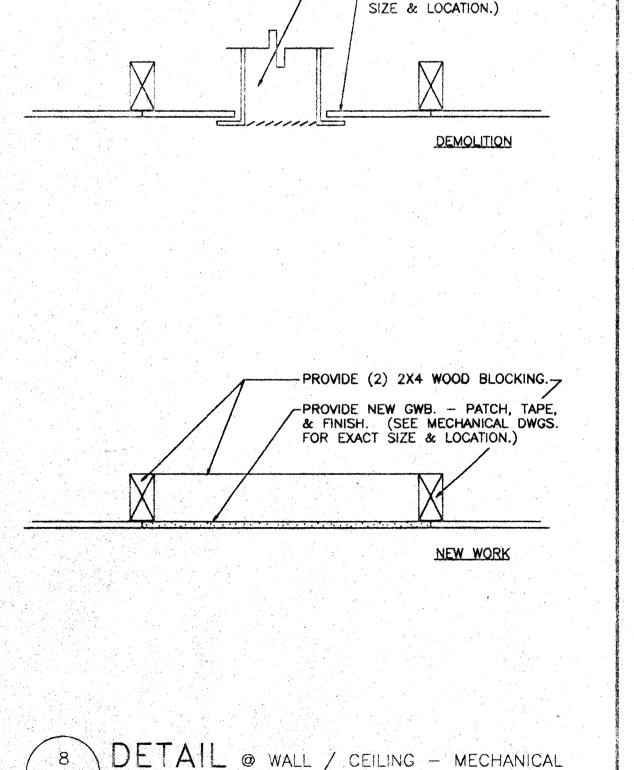



-REMOVE SUPPLY/RETURN PER

REMOVE EXISTING GWB. (SEE


MECHANICAL DWGS. FOR EXACT

MECHANICAL DRAWINGS.

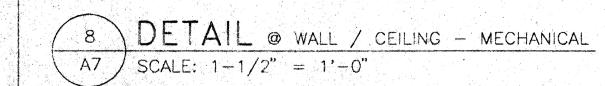

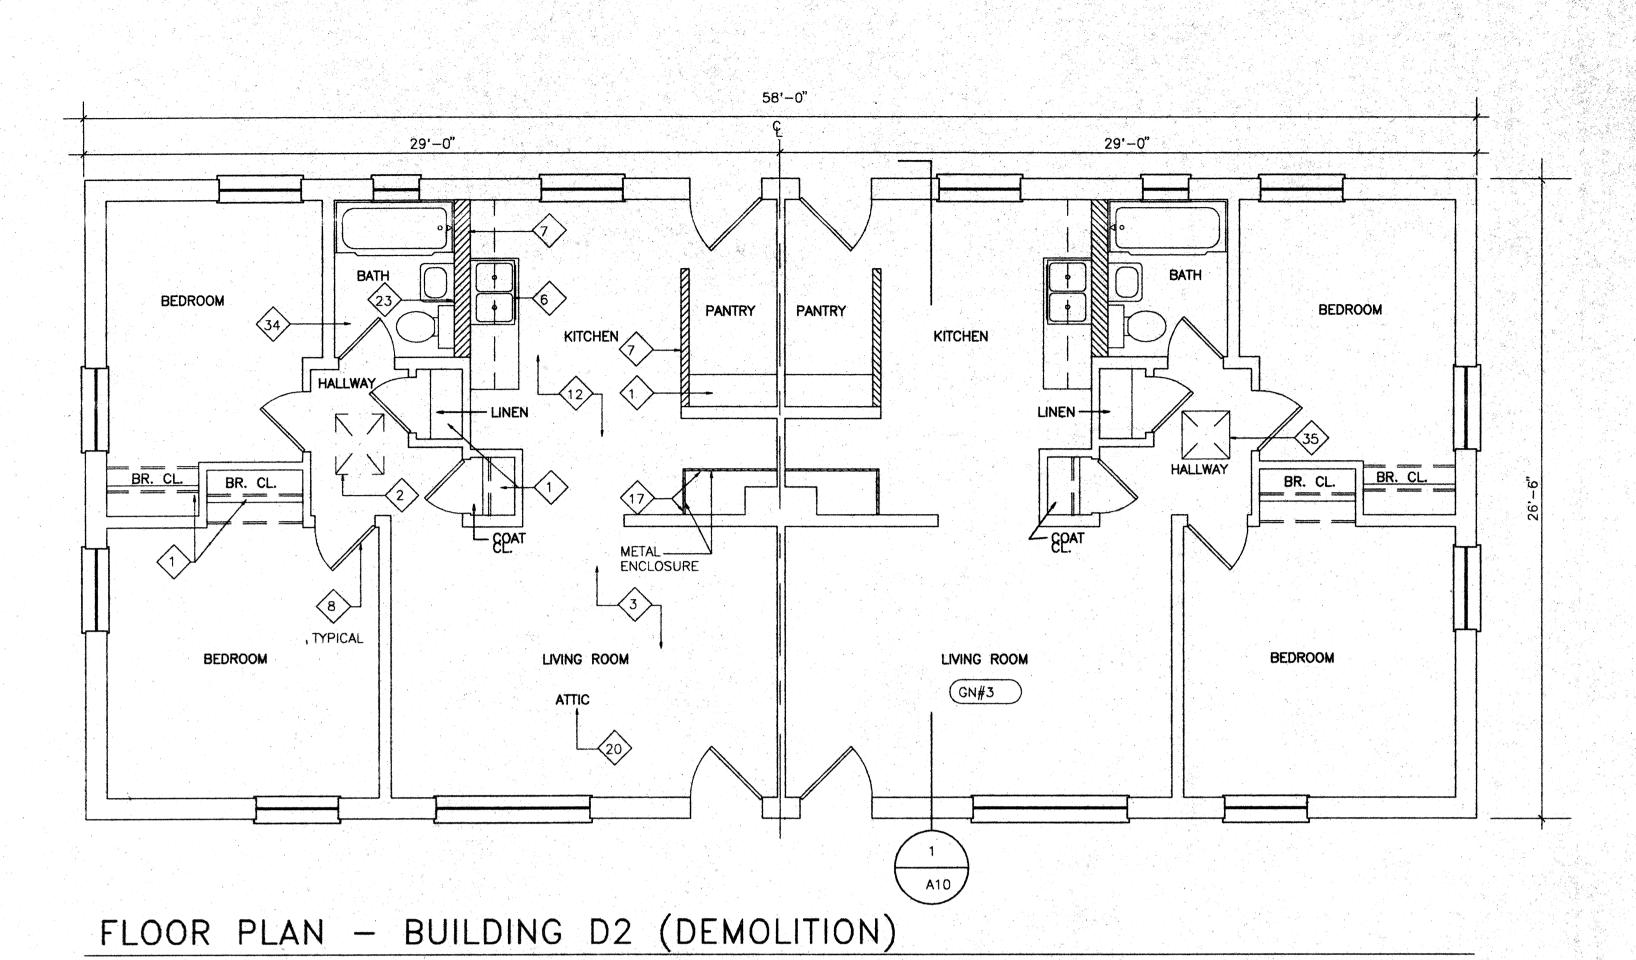

SCALE: 1/4" = 1'-0"

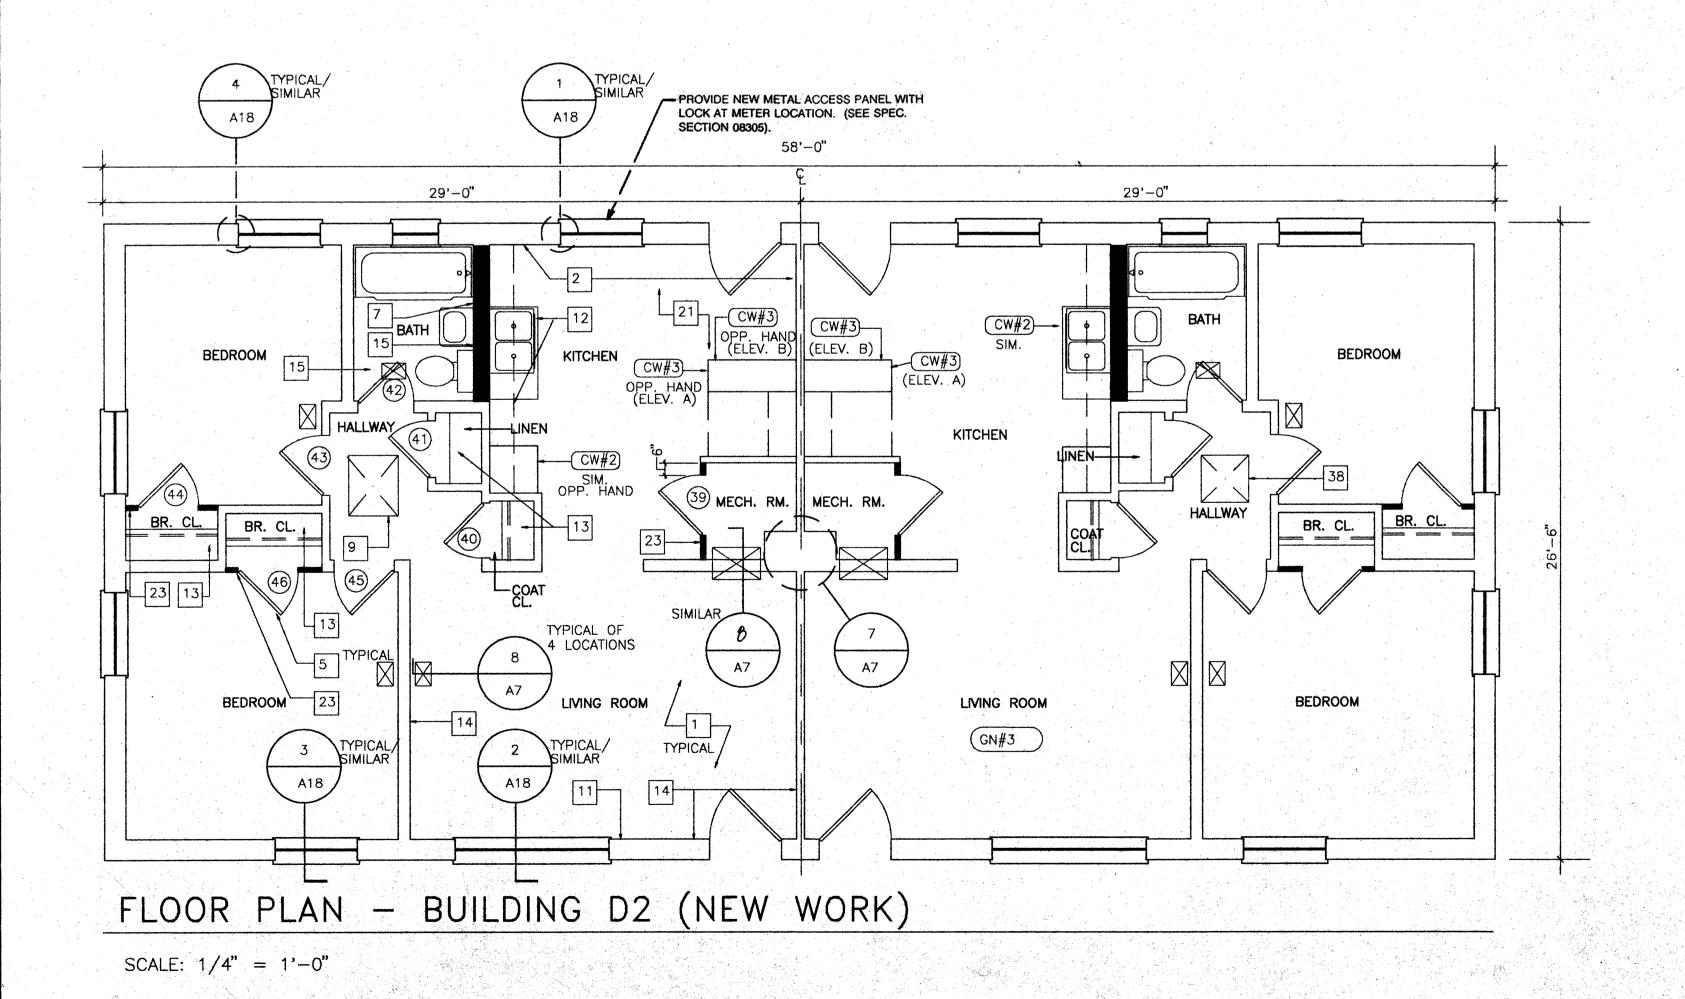

### DEMOLITION NOTES

- 1. REMOVE EXISTING WOOD SHELVING WITH SUPPORTS & RODS, PER SPECIFICATION SECTION 02090. (2 SHELVES EA. @ STORAGE, 4 SHELVES EA. @ LINEN & PANTRY, 1 ROD & 2 SHELVES EA. @ COAT CLOSETS, 2 RODS & 2 SHELVES EA. @ BEDROOM CLOSETS, 2 RODS & 1 SHELF EA. @ STAIR CLOSETS.
- 2. REMOVE EXISTING WOOD ACCESS PANEL & TRIM PER SPECIFICATION SECTION 02090. FRAME & PATCH EXISTING OPENING WITH 1/2" GWB @ BLDG. D2, HANDICAPPED CONVERSION ONLY.
- REMOVE ALL EXISTING WOOD TRIM THROUGHOUT ALL BLDG. SPACES, PER SPECIFICATION SECTION 02090.
- 4. REMOVE PAINT FROM ALL SURFACES OF METAL STAIR PER SPECIFICATION SECTION 02090.
- REMOVE EXIST. INTERIOR WOOD DOORS COMPLETE WITH HARDWARE PER SPECIFICATION SECTION 02090 (TYPICAL—ALL INTERIOR WOOD DOORS). METAL FRAME SHALL REMAIN, UNLESS OTHERWISE NOTED. REMOVE PAINT FROM FRAME PER SPECIFICATION SECTION 02090.
- 6. REMOVE EXIST. KITCHEN CABINETRY PER SPECIFICATION SECTION 02090, AND COUNTERTOPS PER SPEC. SECTION 02070 (SST SINK TO BE REUSED).
- REMOVE EXIST. PAINTED GWB PER SPECIFICATION SECTION 02090.
  REMOVE REMAINING STUD WALL COMPLETE.
- REMOVE EXIST. WOOD DOOR, FRAMES, TRIM AND HARDWARE PER SPECIFICATION SECTION 02090 (TYP. ALL INTERIOR DOORS).
- 9. REMOVE EXIST. LEAD-BASED PAINT PER SPECIFICATION SECTION 02090 THEN REMOVE REMAINING PLASTER PARTITION.
- 10. REMOVE EXISTING WOOD CABINETRY/CASEWORK & COMPONENTS COMPLETE, PER SPEC. SECTION NOTED. PATCH & REPAIR ALL DAMAGED SURFACES.
- 11. REMOVE EXIST. WOOD HANDRAIL & SUPPORTS PER SPECIFICATION SECTION 02090. PATCH AND REPAIR ALL DAMAGED SURFACES.

  12. REMOVE EXISTING FLOOR TILE AND WALL BASES COMPLETE AS DESIGNATED
- PER SPECIFICATION SECTION 02080. (INCLUDES MULTIPLE LAYERS. EXISTING MASTIC MATERIAL SHALL REMAIN.)
- 13. REMOVE PAINTED METAL ENCLOSURE PANEL PER SPECIFICATION SECTION 02090. FRAMING TO REMAIN.
- 14. REMOVE EXISTING PLUMBING FIXTURES COMPLETE. PATCH & REPAIR ALL DAMAGED SURFACES SCHEDULED TO REMAIN.
- 15. REMOVE EXIST. EXTERIOR DOOR, EXTERIOR SCREEN DOOR, FRAME & TRIM COMPLETE. REMOVE PORTION OF EXTERIOR WALL TO ACCOMODATE NEW DOOR AS SCHEDULED. SEE SHEET A17 FOR SCHEDULE & DETAILS. (TYPICAL ALL EXTERIOR DOORS @ DAYCARE UNIT, D2 HANDICAP CONVERSION, AND D3 HANDICAP CONVERSION)
- 16. REMOVE EXIST. LEAD-BASED PAINT PER SPECIFICATION SECTION 02090 THEN REMOVE REMAINING BLOCK WALL.
- 17. REMOVE EXIST. PAINTED METAL ENCLOSURE AND COMPONENTS PER SPECIFICATION SECTION 02090. SEE MECHANICAL SHEET FOR FURTHER DEMOLITION.
- 18. REMOVE EXIST. PTD. METAL HEADER PER SPECIFICATION SECTION 02090.
- 20. REMOVE CONTAMINATED BLOWN INSULATION PER SPEC. SECTION 02080.
  21. REMOVE EXISTING TERRACOTTA FLUE AND CEMENTITIOUS FILL IN ADDITION
- TO OTHER WALL DEMOLITION. FILL RESULTING VOIDS W/ CONCRETE & REPAIR ALL DAMAGED SURFACES SCHEDULED TO REMAIN.

  22. REMOVE EXISTING INTERIOR WOOD DOORS COMPLETE WITH HARDWARE &
- HM FRAMES PER SPECIFICATION SECTION 02090.

  23. EXISTING MIRROR/MEDICINE CABINET TO REMAIN. REMOVE & REINSTALL
- 24. REMOVE EXIST. LEAD—BASED PAINT FROM METAL PANEL ENCLOSURE PER SPECIFICATION SECTION 02090. EXIST. FACTORY—FINISHED FURNACE HOUSING SHALL REMAIN.

  25. 33. NOT SHOWN.
- 34. REMOVE EXISTING BATH ACCESSORIES, TO INCLUDE TOILET TISSUE DISPENSER, TOWEL BAR TUMBLER/TOOTHBRUSH HOLDER, SOAP DISH AND SHOWER CURTAIN ROD AS REQUIRED PER SPECIFICATION SECTION 02070.
- 35. REMOVE EXISTING CEILING AND FRAMING TO PROVIDE ATTIC ACCESS TO MATCH OPENING SIZE AND LOCATION OF ADJACENT UNIT PER SPECIFICATION SECTION 02090.
- 36. 37. NOT SHOWN.

### NEW WORK NOTES

1. PROVIDE NEW 1/2" GYPSUM WALLBOARD. SCREW & LAMINATE TO EXISTING PLASTER/CMU PARTITIONS, EXIST. FURRING, COLUMNS & BEAMS (TYPICAL ALL SPACES THROUGHOUT UNIT).

-

- 2. PROVIDE NEW 1-1/2" METAL FURRING CHANNELS & 1/2" GYPSUM WALLBOARD. (ENTIRE WALL)
- 3. PROVIDE NEW METAL STUD FRAMING WITH 1/2" GYPSUM WALLBOARD SOFFIT W/ REMOVABLE 1/2" PLYWOOOD FRONT PANEL.
- PROVIDE NEW RUBBER STAIR TREADS.
   PROVIDE NEW HOLLOW CORE WOOD DOORS. SEE DOOR SCHEDULE, SHEET A17. (TYPICAL ALL INTERIOR WOOD DOORS, PROVIDE HM FRAMES AS INDICATED ON DOOR SCHEDULE, DOOR TO BE CENTERED IN
- NEW PARTITION UNLESS OTHERWISE DIMENSIONED).

  6. PROVIDE NEW 3-5/8" METAL STUD & 1/2" GYPSUM WALLBOARD PARTITION (FLOOR TO CEILING HEIGHT, WORK INCLUDES AREA ABOVE DOORS) FRAME FLUSH TO EXISTING PARTITIONS. STAGGER MTL. STUDS WHERE REQUIRED TO PROVIDE FLUSH TRANSITION INTO EXIST. WALL OR NEW
- MTL. FURRING. TYP. ALL LOCATIONS INDICATED UNLESS OTHERWISE NOTED.

  7. PROVIDE NEW 1 X 4 WOOD CHAIR RAIL. (MTG. HEIGHT-36" TO C OF RAIL)

  SEE DETAIL 5/410
- 8. PROVIDE 1/2" PLYWOOD AT UNDERSIDE OF STAIR OR LANDING (SECURE TO BOTTOM OF STRINGER OR SUPPORT CHANNELS).
- 9. PROVIDE NEW 1/4" PLYWOOD ACCESS PANEL & TRIM. PROVIDE NEW FRAMED OPENING @ BLDG. D2 HANDICAPPED CONVERSION ONLY.
- 10. PROVIDE NEW EXTERIOR METAL DOOR W/SCREEN IN NEW HOLLOW METAL FRAME. PROVIDE NEW BLOCKING AND FINISH WALL. SEE SHEET A17 FOR SCHEDULE & DETAILS. (TYPICAL ALL DOORS @ DAYCARE UNIT, D2 HANDICAL CONVERSION & D3 HANDICAP CONVERSION)
- 11. PROVIDE NEW 7/8" METAL FURRING CHANNELS & 1/2" GWB. (ENTIRE WALL)
  12. PROVIDE NEW NATURAL FINISH PLYWOOD AND SOLID WOOD CABINETS,
- NEW COUNTERTOPS AND FULL HEIGHT BACKSPLASH.

  13. PROVIDE NEW WOOD SHELVING AND RODS. (2 SHELVES EA. @ STORAGE,
  4 SHELVES EA. @ LINEN & PANTRY, 1 ROD & 2 SHELVES EA. @ BEDROOM
  & COAT CLOSETS, 2 RODS & 2 SHELVES EA. @ STAIR CLOSETS, 1 ROD &
  1 SHELF EA. @ BATH. FOR DETAILS, SEE SHEET A19).
- 14. PROVIDE NEW 4" NOOD BASE. (TYPICAL ALL PARTITIONS) SEE 8/A.D.

  15. PROVIDE NEW 6" METAL STUD PARTITION WITH 1/2"
- GYPSUM WALLBOARD. 16. PROVIDE NEW HOLLOW METAL DOOR FRAMES.
- 17. PROVIDE NEW 1/2" GYPSUM WALLBOARD CEILING, SLOPE TO MATCH STAIR—SEE SECTION 1/A13.
- 18. PROVIDE NEW METAL STUD FRAMING WITH 1/2" GYPSUM WALLBOARD SOFFITS
  19. PROVIDE NEW 1-1/2" ♥ WOOD HANDRAIL SUPPORTED BY NEW METAL
- BRACKETS & SECURED TO EXISTING PARTITION. (CLEAR STAIN FINISH, SEE DETAILS 6 & 7/A19.)

  20. PROVIDE NEW WOOD CAP. (CLEAR STAIN FINISH) SEE DETAIL 6/A10.
- 21. PROVIDE NEW 12" X 12" VINYL COMPOSITION FLOOR TILE THROUGHOUT UNIT ALL SPACES. (UNLESS OTHERWISE NOTED.)
- 22. PROVIDE NEW 1/2" GYPSUM WALLBOARD FASTENED TO EXISTING METAL FRAMED DUCT ENCLOSURE.
- 23. PROVIDE NEW 2-1/2" METAL STUDS & 1/2" GYPSUM WALLBOARD PARTITION (FLOOR TO CEILING HEIGHT, WORK INCLUDES AREA ABOVE DOORS) FRAME FLUSH TO EXISTING PARTITIONS. TYPICAL ALL LOCATIONS INDICATED.
- 24. PATCH HOLES RESULTING FROM MECHANICAL DEMOLITION PER SPEC. SECTION 07242A (SEE MECHANICAL DRAWINGS).
- 25. PROVIDE NEW 1 X 6 WD TRIM AT AREA BETWEEN WINDOWS. (SHAPE TO MATCH EXISTING.)
- 26. PATCH EXIST. OPENING RESULTING FROM MECHANICAL DEMOLITION IN SECOND FLOOR SLAB WITH CONCRETE. (SEE MECHANICAL DRAWINGS)
  27. PROVIDE 2 1/2" METAL STUD CEILING FRAMING WITH 1/2" GWB THIS SIDE OF BEAM ONLY IN HALLWAY. BOTTOM OF DROP CLG. TO BE 3/4" HIGHER

THAN BOTTOM OF EXIST. BEAM. COORDINATE LOCATION OF FRAMING

- WITH MECHANICAL DUCT. (SEE SHEET M-6.)

  28. PROVIDE NEW HOLLOW CORE FLUSH WOOD BI-FOLD DOOR, TYPE E AS SHOWN ON SHEET A17. PROVIDE HARDWARE PER SPECIFICATION SECTION
- 08700. INSTALL DOOR VIA FLOOR & CEILING CONNECTIONS ONLY.

  29. 36. NOT SHOWN.

  37. PROVIDE NEW BATH ACCESSORIES, TO INCLUDE TOILET TISSUE DISPENSER.
- TOWEL BAR, TUMBLER/TOOTHBRUSH HOLDER, SOAP DISH AND SHOWER CURTAIN ROD, PER SPECIFICATION SECTION 10800. SEE BATH PARTIAL PLANS, SHEET A10.
- 38. PROVIDE NEW ATTIC ACCESS TO MATCH ACCESS IN ADJACENT UNIT. NEW WORK TO INCLUDE FRAMED OPENING, 1/4" PLYWOOD ACCESS PANEL AND TRIM.
- 39. 42. NOT SHOWN.

### SENERAL NOTES

- THE GENERAL CONTRACTOR SHALL VERIFY ALL FIELD CONDITIONS & DIMENSIONS PRIOR TO CONSTRUCTION & SHALL COORDINATE THE WORK OF ALL TRADES. ALL DISCREPANCIES SHALL BE BROUGHT TO THE IMMEDIATE ATTENTION OF THE ARCHITECT PRIOR TO STARTING CONSTRUCTION.
- ALL PARTITIONS SHOWN THUS ( ) INDICATE NEW PARTITIONS.
   FOR CONSTRUCTION NOTES APPLICABLE TO THIS UNIT, REFER TO OPPOSITE HAND UNIT THIS PLAN, UNLESS OTHERWISE NOTED (I.E. EXISTING
- PARTITION DEMOLITION). ALL DETAIL/SECTION SYMBOLS APPLY TO BOTH UNITS

  4. WORK NOTES INDICATED ARE MASTER NOTE LISTS. SOME NOTES MAY NOT BE APPLICABLE TO THE CORRESPONDING SHEETS ON WHICH THEY APPEAR.
- FOR DWELLING UNIT DOOR SCHEDULE & DETAILS, REFER TO SHEETS A17 & A18.
   FOR DWELLING UNIT CASEWORK ELEVATIONS & DETAILS, REFER TO
- SHEET A19.

  7. EXISTING ACCESS PANELS SHOWN AT APPROXIMATE LOCATION & SIZE. CONTRACTOR SHALL FIELD VERIFY EXACT LOCATION & DIMENSIONS.
- ALL DIMENSIONS ARE TO FACE OF STUD UNLESS OTHERWISE NOTED.
   PATCH & CLEAN ALL CEILING SURFACES PRIOR TO PAINTING (QUANTITY-
- CONTRACTOR SHALL PROVIDE 1/2" GWB AT ALL EXPOSED SURFACES OF BEAMS & COLUMNS. TYP. THROUGHOUT ALL UNITS.

APPROXIMATELY SIX (6)  $1^{"} \varnothing X 2^{"}$  DEEP PENETRATIONS PER UNIT).

12. PAINT NEW & EXIST. INTERIOR SURFACES WITHIN THE ENTIRE UNIT.
SURFACES TO BE PAINTED INCLUDE BUT ARE NOT LIMITED TO WALLS,
CEILINGS, ACCESS PANELS, TRIM, METAL PANEL ENCLOSURES, FURNACE
HOUSING, DUCT WORK, BEAMS, COLUMNS, DOORS & FRAMES, WOOD TRIM,

HANDRAILS, RODS, SHELVES, & SUPPORTS (TYP. THROUGHOUT ALL UNITS)


- 13. FOR BATH PARTIAL PLANS & DETAILS, SEE SHEET A10.
- 14. FOR BID ALTERNATE WORK, SEE SHEETS A29 THRU A31.
- 15. IN ADDITION TO THE WORK INDICATED ON THIS PLAN, THE CONTRACTOR SHALL PERFORM ALL WORK SHOWN ON THE CORRESPONDING DEMOLITION PLAN LOCATED ON THE SHEET REFERENCED THUS ( GN#15) . A1
- 16. ALL PARTITIONS SHOWN THUS ( ) INDICATE NEW 2X4 WOOD PARTITIONS.





COMPREHENSIVE RENOVATION OF VA 3-2 MARSHALL COURTS

NEWPORT NEWS, VA

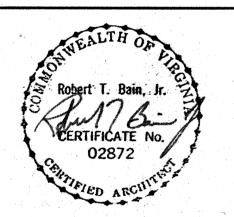

Designed: CET

Drawn: TEN / RSJ

Checked: смн

Scale: AS NOTED

Date: JANUARY 31, 1992

F-1

File No: 901003\A-8DN


Project No: 901003A

BUILDING
TYPE D2 FLOOR PLANS
(DEMOLITION &

NEW WORK)


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8A

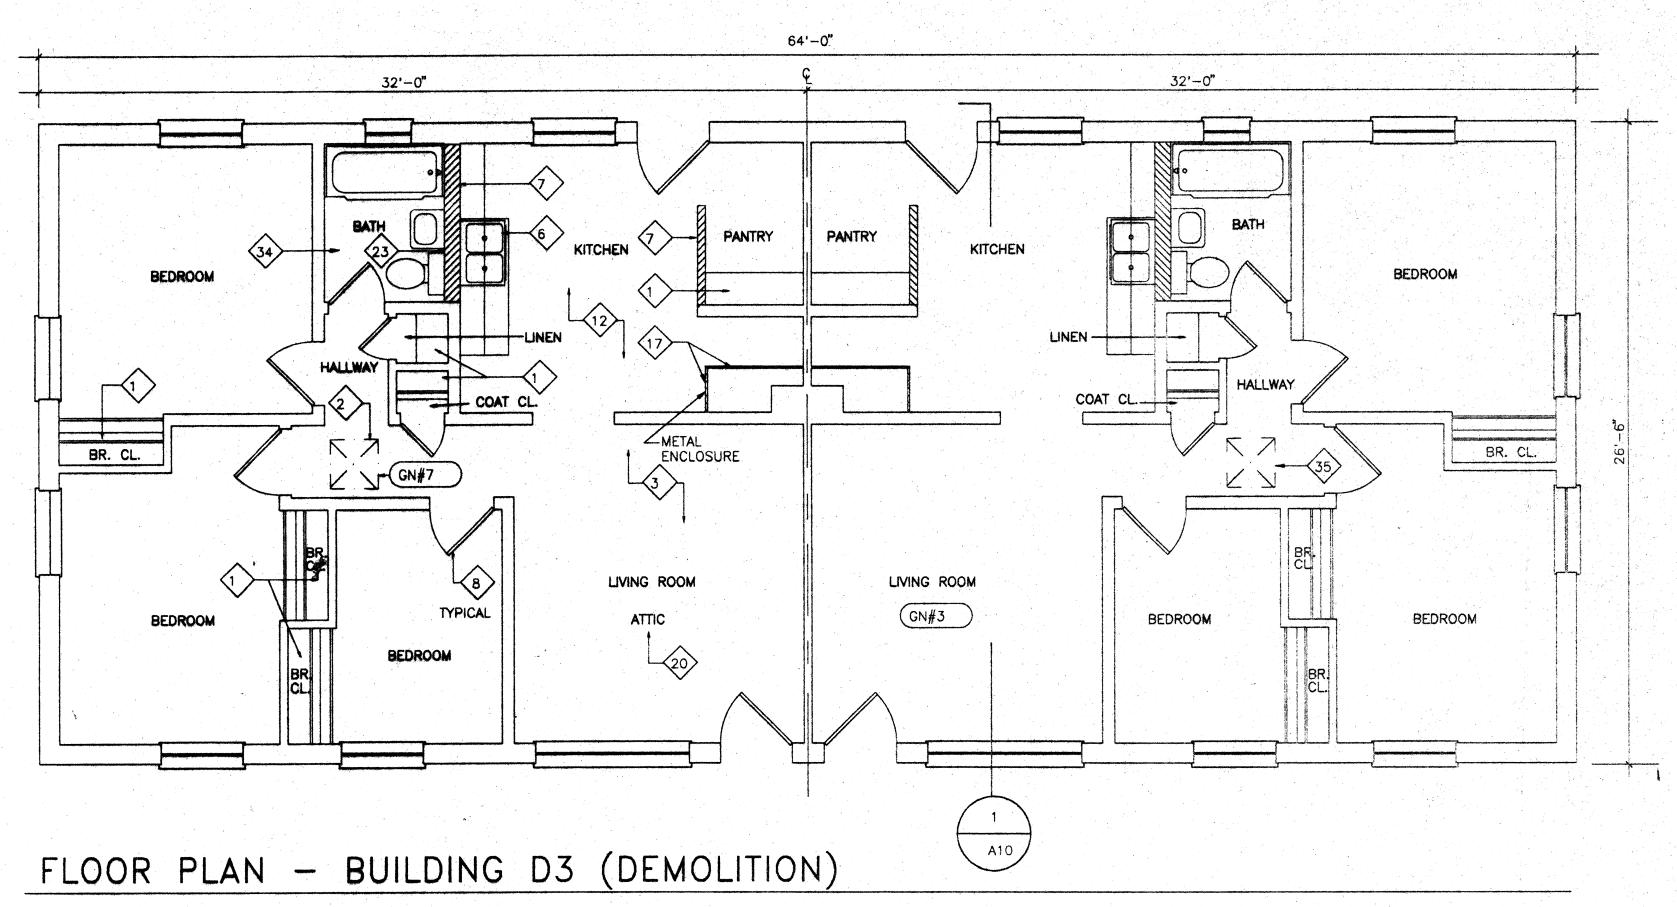

SCALE: 1/4" = 1'-0"

SCALE: 1/4" = 1'-0"

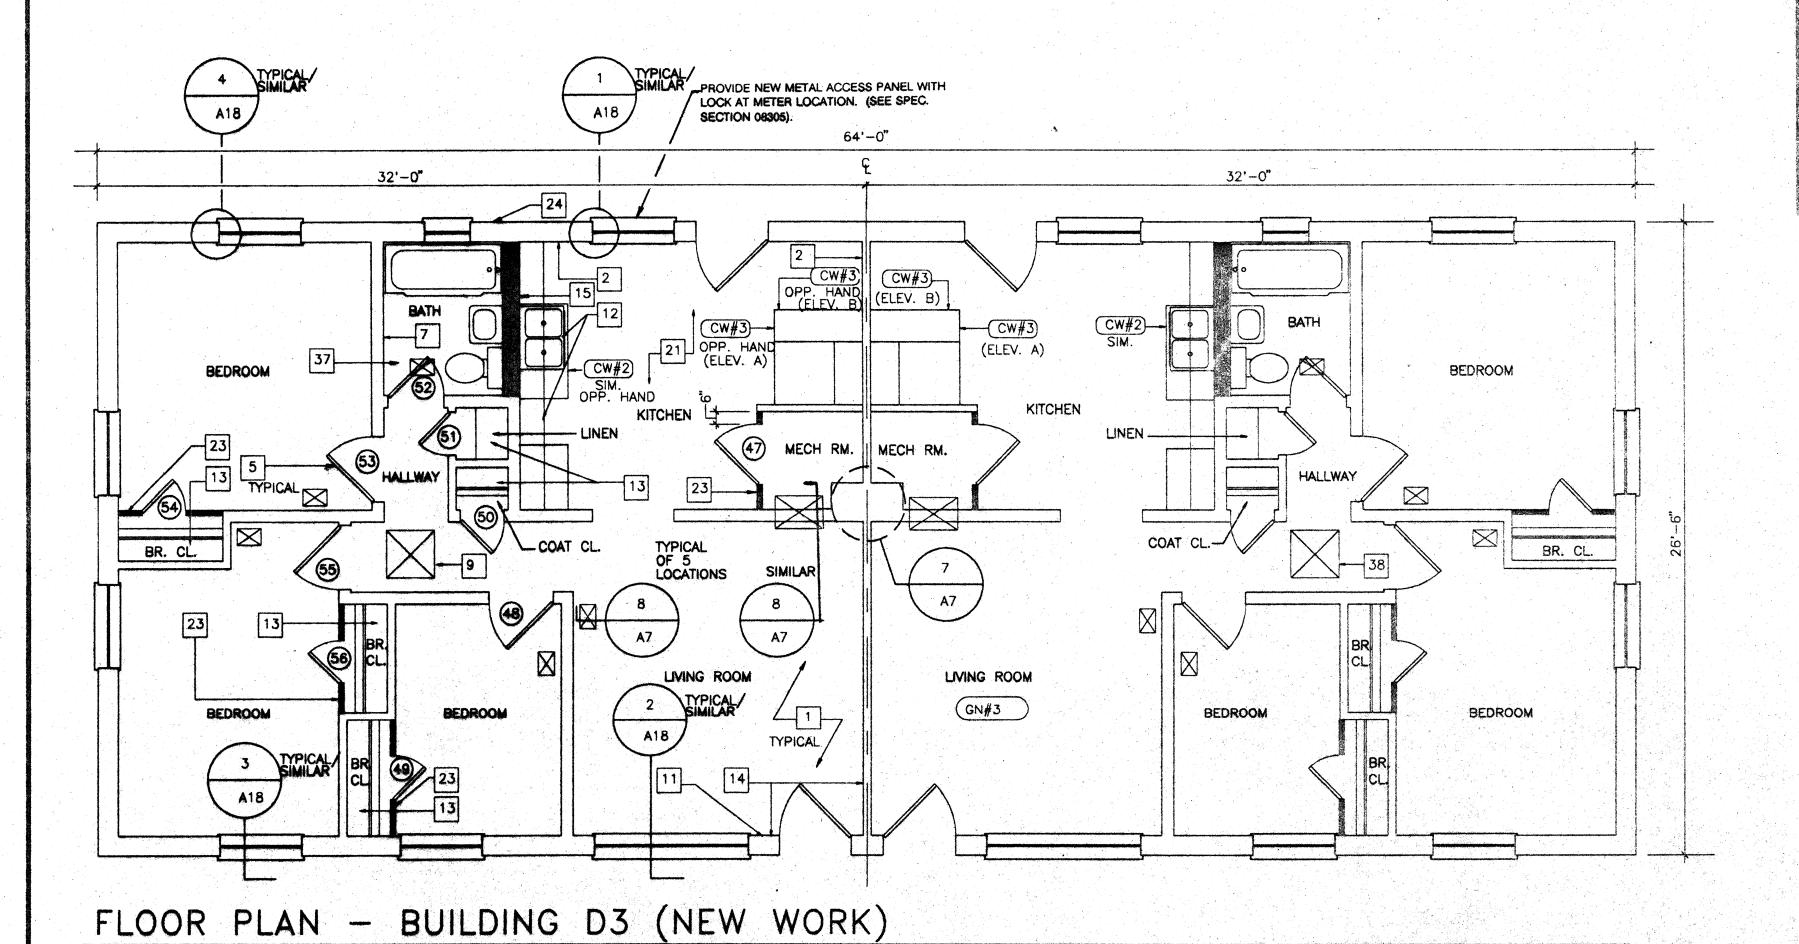

### DEMOLITION NOTES

- REMOVE EXISTING WOOD SHELVING WITH SUPPORTS & RODS, PER SPECIFICATION SECTION 02090. (2 SHELVES EA. @ STORAGE, 4 SHELVES EA. @ LINEN & PANTRY, 1 ROD & 2 SHELVES EA. @ COAT CLOSETS, 2 RODS & 2 SHELVES EA. @ BEDROOM CLOSETS, 2 RODS & 1 SHELF EA. @ STAIR CLOSETS.
- REMOVE EXISTING WOOD ACCESS PANEL & TRIM PER SPECIFICATION SECTION 02090. FRAME & PATCH EXISTING OPENING WITH 1/2" GWB BLDG. D2, HANDICAPPED CONVERSION ONLY.
- REMOVE ALL EXISTING WOOD TRIM THROUGHOUT ALL BLDG. SPACES, PER SPECIFICATION SECTION 02090.
- REMOVE PAINT FROM ALL SURFACES OF METAL STAIR PER
- SPECIFICATION SECTION 02090. REMOVE EXIST. INTERIOR WOOD DOORS COMPLETE WITH HARDWARE PER SPECIFICATION SECTION 02090 (TYPICAL-ALL INTERIOR WOOD DOORS). METAL FRAME SHALL REMAIN, UNLESS OTHERWISE NOTED. REMOVE
- REMOVE EXIST. KITCHEN CABINETRY PER SPECIFICATION SECTION 02090, AND COUNTERTOPS PER SPEC. SECTION 02070 (SST SINK TO BE REUSED).
- REMOVE EXIST, PAINTED GWB PER SPECIFICATION SECTION 02090. REMOVE REMAINING STUD WALL COMPLETE.
- REMOVE EXIST. WOOD DOOR, FRAMES, TRIM AND HARDWARE PER SPECIFICATION SECTION 02090 (TYP. ALL INTERIOR DOORS).

PAINT FROM FRAME PER SPECIFICATION SECTION 02090.

- 9. REMOVE EXIST. LEAD-BASED PAINT PER SPECIFICATION SECTION 02090 THEN REMOVE REMAINING PLASTER PARTITION.
- REMOVE EXISTING WOOD CABINETRY/CASEWORK & COMPONENTS COMPLETE PER SPEC. SECTION NOTED. PATCH & REPAIR ALL DAMAGED SURFACES.
- 11. REMOVE EXIST. WOOD HANDRAIL & SUPPORTS PER SPECIFICATION SECTION 02090. PATCH AND REPAIR ALL DAMAGED SURFACES.
- 12. REMOVE EXISTING FLOOR TILE AND WALL BASES COMPLETE AS DESIGNATED PER SPECIFICATION SECTION 02080. (INCLUDES MULTIPLE LAYERS.
- EXISTING MASTIC MATERIAL SHALL REMAIN.) 13. REMOVE PAINTED METAL ENCLOSURE PANEL PER SPECIFICATION SECTION 02090. FRAMING TO REMAIN.
- 14. REMOVE EXISTING PLUMBING FIXTURES COMPLETE. PATCH & REPAIR ALL DAMAGED SURFACES SCHEDULED TO REMAIN.
- REMOVE EXIST. EXTERIOR DOOR, EXTERIOR SCREEN DOOR, FRAME & TRIM REMOVE PORTION OF EXTERIOR WALL TO ACCOMODATE NEW DOOR AS SCHEDULED. SEE SHEET A17 FOR SCHEDULE & DETAILS. TYPICAL ALL EXTERIOR DOORS @ DAYCARE UNIT, D2 HANDICAP CONVERSION, AND D3 HANDICAP CONVERSION)
- REMOVE EXIST. LEAD-BASED PAINT PER SPECIFICATION SECTION 02090 THEN REMOVE REMAINING BLOCK WALL.
- 17. REMOVE EXIST. PAINTED METAL ENCLOSURE AND COMPONENTS PER SPECIFICATION SECTION 02090. SEE MECHANICAL SHEET FOR FURTHER
- 18. REMOVE EXIST. PTD. METAL HEADER PER SPECIFICATION SECTION 02090.
- 19. REMOVE CONTAMINATED SOIL TO A DEPTH OF 2" PER SPEC. SECTION 02080.
- 20. REMOVE CONTAMINATED BLOWN INSULATION PER SPEC. SECTION 02080. 21. REMOVE EXISTING TERRACOTTA FLUE AND CEMENTITIOUS FILL IN ADDITION
- TO OTHER WALL DEMOLITION. FILL RESULTING VOIDS W/ CONCRETE & REPAIR ALL DAMAGED SURFACES SCHEDULED TO REMAIN.
- 22. REMOVE EXISTING INTERIOR WOOD DOORS COMPLETE WITH HARDWARE & HM FRAMES PER SPECIFICATION SECTION 02090.
- 23. EXISTING MIRROR/MEDICINE CABINET TO REMAIN. REMOVE & REINSTALL AS REQUIRED.
- 24. REMOVE EXIST. LEAD-BASED PAINT FROM METAL PANEL ENCLOSURE PER SPECIFICATION SECTION 02090. EXIST. FACTORY-FINISHED FURNACE HOUSING SHALL REMAIN.
- 25. 33. NOT SHOWN. 34. REMOVE EXISTING BATH ACCESSORIES, TO INCLUDE TOILET TISSUE DISPENSER, TOWEL BAR TUMBLER/TOOTHBRUSH HOLDER, SOAP DISH AND SHOWER CURTAIN ROD AS REQUIRED PER SPECIFICATION SECTION 02070.
- 35. REMOVE EXISTING CEILING AND FRAMING TO PROVIDE ATTIC ACCESS TO MATCH OPENING SIZE AND LOCATION OF ADJACENT UNIT PER SPECIFICATION SECTION 02090.
- 36. 37. NOT SHOWN.

### NEW WORK NOTES

- PROVIDE NEW 1/2" GYPSUM WALLBOARD. SCREW & LAMINATE TO EXISTING PLASTER/CMU PARTITIONS, EXIST. FURRING, COLUMNS & BEAMS (TYPICAL ALL SPACES THROUGHOUT UNIT).
- 2. PROVIDE NEW 1-1/2" METAL FURRING CHANNELS & 1/2" GYPSUM
- WALLBOARD. (ENTIRE WALL) 3. PROVIDE NEW METAL STUD FRAMING WITH 1/2" GYPSUM
- WALLBOARD SOFFIT W/ REMOVABLE 1/2" PLYWOOOD FRONT PANEL.
- 4. PROVIDE NEW RUBBER STAIR TREADS. 5. PROVIDE NEW HOLLOW CORE WOOD DOORS. SEE DOOR SCHEDULE, SHEET A17. (TYPICAL ALL INTERIOR WOOD DOORS, PROVIDE HM FRAMES) AS INDICATED ON DOOR SCHEDULE, DOOR TO BE CENTERED IN
- NEW PARTITION UNLESS OTHERWISE DIMENSIONED) 6. PROVIDE NEW 3-5/8" METAL STUD & 1/2" GYPSUM WALLBOARD PARTITION - (FLOOR TO CEILING HEIGHT, WORK INCLUDES AREA ABOVE DOORS) - FRAME FLUSH TO EXISTING PARTITIONS. STAGGER MTL. STUDS WHERE REQUIRED TO PROVIDE FLUSH TRANSITION INTO EXIST. WALL OR NEW MTL. FURRING. TYP. ALL LOCATIONS INDICATED UNLESS OTHERWISE NOTED.
- PROVIDE NEW 1 X 4 WOOD CHAIR RAIL. (MTG: HEIGHT-36" TO C OF RAIL) SEE DETAIL 5/A10. 8. PROVIDE 1/2" PLYWOOD AT UNDERSIDE OF STAIR OR LANDING (SECURE
- TO BOTTOM OF STRINGER OR SUPPORT CHANNELS). 9. PROVIDE NEW 1/4" PLYWOOD ACCESS PANEL & TRIM. PROVIDE NEW
- FRAMED OPENING @ BLDG. D2 HANDICAPPED CONVERSION ONLY.
- 10. PROVIDE NEW EXTERIOR METAL DOOR W/SCREEN IN NEW HOLLOW METAL FRAME. PROVIDE NEW BLOCKING AND FINISH WALL. SEE SHEET A17 FOR SCHEDULE & DETAILS. (TYPICAL ALL DOORS @ DAYCARE UNIT, D2 HANDICAP CONVERSION & D3 HANDICAP CONVERSION)
- 11. PROVIDE NEW 7/8" METAL FURRING CHANNELS & 1/2" GWB. (ENTIRE WALL)
- 12. PROVIDE NEW NATURAL FINISH PLYWOOD AND SOLID WOOD CABINETS, NEW COUNTERTOPS AND FULL HEIGHT BACKSPLASH.
- 13. PROVIDE NEW WOOD SHELVING AND RODS. (2 SHELVES EA. @ STORAGE, 4 SHELVES EA. @ LINEN & PANTRY, 1 ROD & 2 SHELVES EA. @ BEDROOM & COAT CLOSETS, 2 RODS & 2 SHELVES EA. @ STAIR CLOSETS, 1 ROD & 1 SHELF EA. @ BATH. FOR DETAILS, SEE SHEET A19).
- 14. PROVIDE NEW 4" WOOD BASE. (TYPICAL ALL PARTITIONS) SEE 8/10
- 15. PROVIDE NEW 6" METAL STUD PARTITION WITH 1/2" GYPSUM WALLBOARD.
- 16. PROVIDE NEW HOLLOW METAL DOOR FRAMES. 17. PROVIDE NEW 1/2" GYPSUM WALLBOARD CEILING, SLOPE TO MATCH STAIR-
- SEE SECTION 1/A13. 18. PROVIDE NEW METAL STUD FRAMING WITH 1/2" GYPSUM WALLBOARD SOFFITS. 19. PROVIDE NEW 1-1/2" WOOD HANDRAIL SUPPORTED BY NEW METAL
- SEE DETAILS 6 & 7/A19.) 20. PROVIDE NEW WOOD CAP. (CLEAR STAIN FINISH) SEE DETAIL 6/A10.

BRACKETS & SECURED TO EXISTING PARTITION. (CLEAR STAIN FINISH,

21. PROVIDE NEW 12" X 12" VINYL COMPOSITION FLOOR TILE THROUGHOUT UNIT - ALL SPACES. (UNLESS OTHERWISE NOTED.)

22. PROVIDE NEW 1/2" GYPSUM WALLBOARD FASTENED TO EXISTING

- METAL FRAMED DUCT ENCLOSURE. PROVIDE NEW 2-1/2" METAL STUDS & 1/2" GYPSUM WALLBOARD PARTITION - (FLOOR TO CEILING HEIGHT, WORK INCLUDES AREA ABOVE DOORS) - FRAME FLUSH TO EXISTING PARTITIONS. TYPICAL ALL
- LOCATIONS INDICATED. 24. PATCH HOLES RESULTING FROM MECHANICAL DEMOLITION PER SPEC.
- SECTION 07242A (SEE MECHANICAL DRAWINGS). 25. PROVIDE NEW 1 X 6 WD TRIM AT AREA BETWEEN WINDOWS. (SHAPE TO
- MATCH EXISTING.) 26. PATCH EXIST. OPENING RESULTING FROM MECHANICAL DEMOLITION IN SECOND
- FLOOR SLAB WITH CONCRETE. (SEE MECHANICAL DRAWINGS) 27. PROVIDE 2 1/2" METAL STUD CEILING FRAMING WITH 1/2" GWB THIS SIDE OF BEAM ONLY IN HALLWAY. BOTTOM OF DROP CLG. TO BE 3/4" HIGHER
- THAN BOTTOM OF EXIST. BEAM. COORDINATE LOCATION OF FRAMING WITH MECHANICAL DUCT. (SEE SHEET M-6.) 28. PROVIDE NEW HOLLOW CORE FLUSH WOOD BI-FOLD DOOR, TYPE E AS SHOWN ON SHEET A17. PROVIDE HARDWARE PER SPECIFICATION SECTION
- 08700. INSTALL DOOR VIA FLOOR & CEILING CONNECTIONS ONLY. 29. - 36. NOT SHOWN. 37. PROVIDE NEW BATH ACCESSORIES, TO INCLUDE TOILET TISSUE DISPENSER, TOWEL BAR, TUMBLER/TOOTHBRUSH HOLDER, SOAP DISH AND SHOWER
- CURTAIN ROD, PER SPECIFICATION SECTION 10800. SEE BATH PARTIAL PLANS, SHEET A10. 38. PROVIDE NEW ATTIC ACCESS TO MATCH ACCESS IN ADJACENT UNIT. NEW
- WORK TO INCLUDE FRAMED OPENING, 1/4" PLYWOOD ACCESS PANEL AND
- 39. 42. NOT SHOWN.

## GENERAL NOTES


- THE GENERAL CONTRACTOR SHALL VERIFY ALL FIELD CONDITIONS & DIMENSIONS PRIOR TO CONSTRUCTION & SHALL COORDINATE THE WORK OF ALL TRADES. ALL DISCREPANCIES SHALL BE BROUGHT TO THE IMMEDIATE ATTENTION OF THE ARCHITECT PRIOR TO STARTING CONSTRUCTION.
- ALL PARTITIONS SHOWN THUS ( ) INDICATE NEW PARTITIONS. 3. FOR CONSTRUCTION NOTES APPLICABLE TO THIS UNIT, REFER TO OPPOSITE HAND UNIT THIS PLAN, UNLESS OTHERWISE NOTED (I.E. EXISTING PARTITION DEMOLITION). ALL DETAIL/SECTION SYMBOLS APPLY TO BOTH UNITS
- WORK NOTES INDICATED ARE MASTER NOTE LISTS. SOME NOTES MAY NOT BE APPLICABLE TO THE CORRESPONDING SHEETS ON WHICH THEY APPEAR.
- 5. FOR DWELLING UNIT DOOR SCHEDULE & DETAILS, REFER TO SHEETS A17 & A18.
- 6. FOR DWELLING UNIT CASEWORK ELEVATIONS & DETAILS, REFER TO SHEET A19.
- 7. EXISTING ACCESS PANELS SHOWN AT APPROXIMATE LOCATION & SIZE. CONTRACTOR SHALL FIELD VERIFY EXACT LOCATION & DIMENSIONS.
- REMOVED.
- 9. ALL DIMENSIONS ARE TO FACE OF STUD UNLESS OTHERWISE NOTED.
- 10. PATCH & CLEAN ALL CEILING SURFACES PRIOR TO PAINTING (QUANTITY-
- APPROXIMATELY SIX (6) 1"  $\varnothing$  X 2" DEEP PENETRATIONS PER UNIT). 11. CONTRACTOR SHALL PROVIDE 1/2" GWB AT ALL EXPOSED SURFACES OF
- BEAMS & COLUMNS. TYP. THROUGHOUT ALL UNITS. 12. PAINT NEW & EXIST. INTERIOR SURFACES WITHIN THE ENTIRE UNIT SURFACES TO BE PAINTED INCLUDE BUT ARE NOT LIMITED TO WALLS,
- CEILINGS, ACCESS PANELS, TRIM, METAL PANEL ENCLOSURES, FURNACE HOUSING, DUCT WORK, BEAMS, COLUMNS, DOORS & FRAMES, WOOD TRIM, HANDRAILS, RODS, SHELVES, & SUPPORTS (TYP. THROUGHOUT ALL UNITS). 13. FOR BATH PARTIAL PLANS & DETAILS, SEE SHEET A10.
- 14. FOR BID ALTERNATE WORK, SEE SHEETS A29 THRU A31.
- 15. IN ADDITION TO THE WORK INDICATED ON THIS PLAN, THE CONTRACTOR SHALL PERFORM ALL WORK SHOWN ON THE CORRESPONDING DEMOLITION PLAN LOCATED ON THE SHEET REFERENCED THUS ( GN#15)
- 16. ALL PARTITIONS SHOWN THUS ( ) INDICATE NEW 2X4 WOOD



NEWPORT NEWS, VA

MARSHALL

COURTS

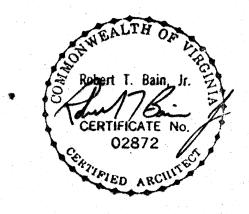

Designed: CET

Drawn: TEN / RSJ

Checked: CMH

Scale:

JANUARY 31, 1992

AS NOTED


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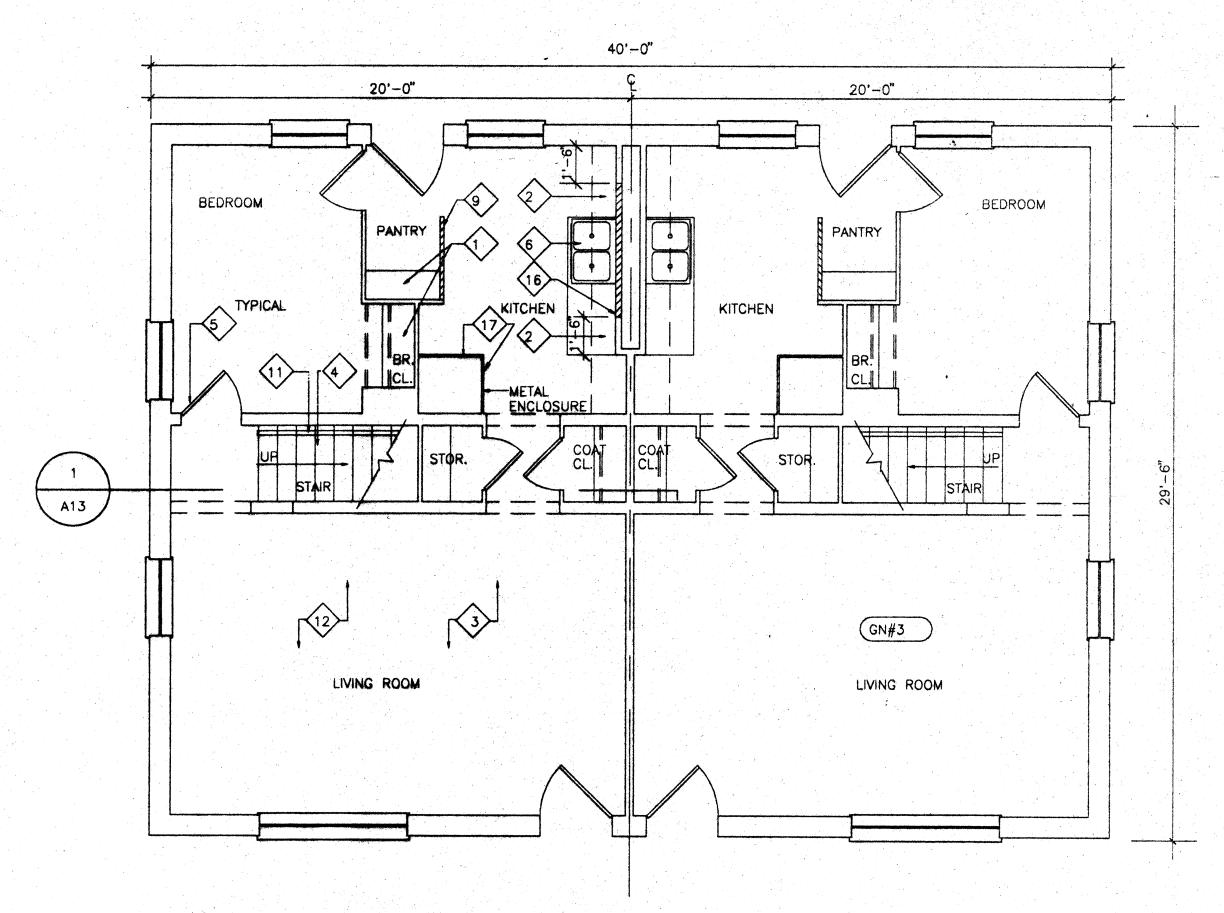
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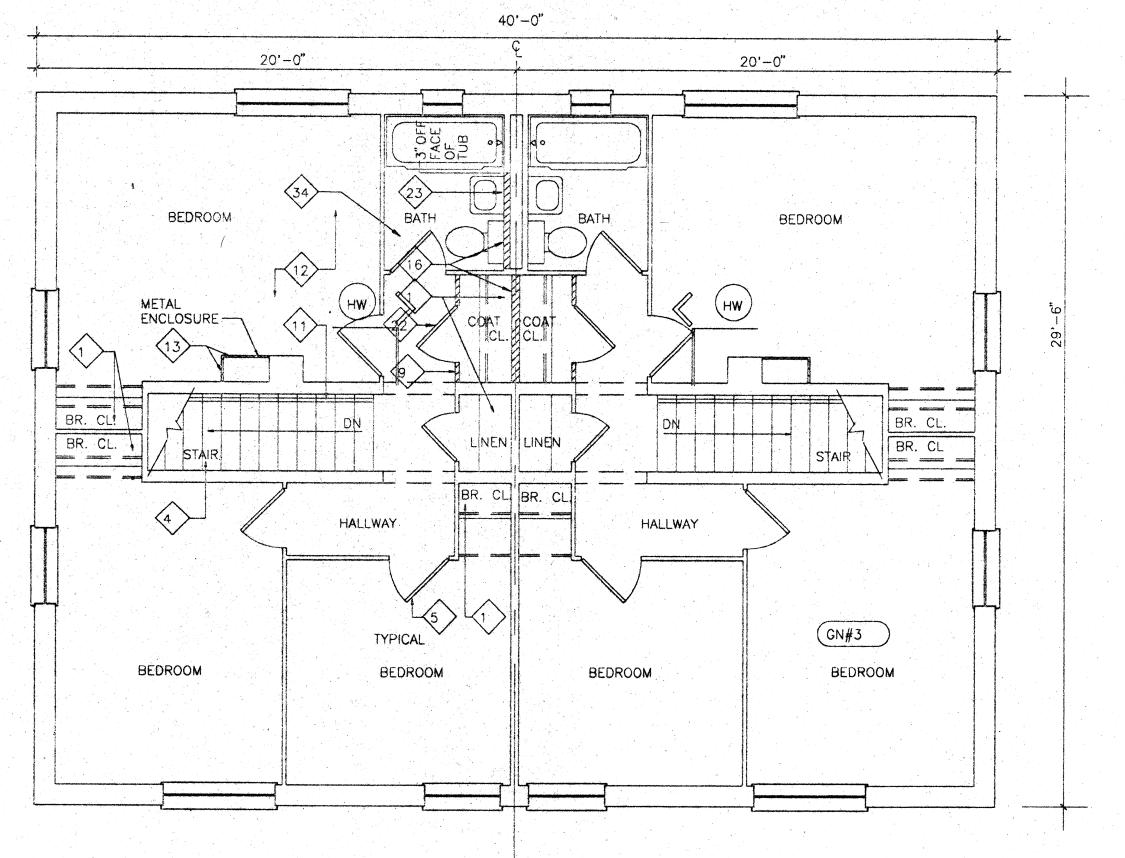
BUILDING TYPE D3 -FLOOR PLANS (DEMOLITION &

NEW WORK)

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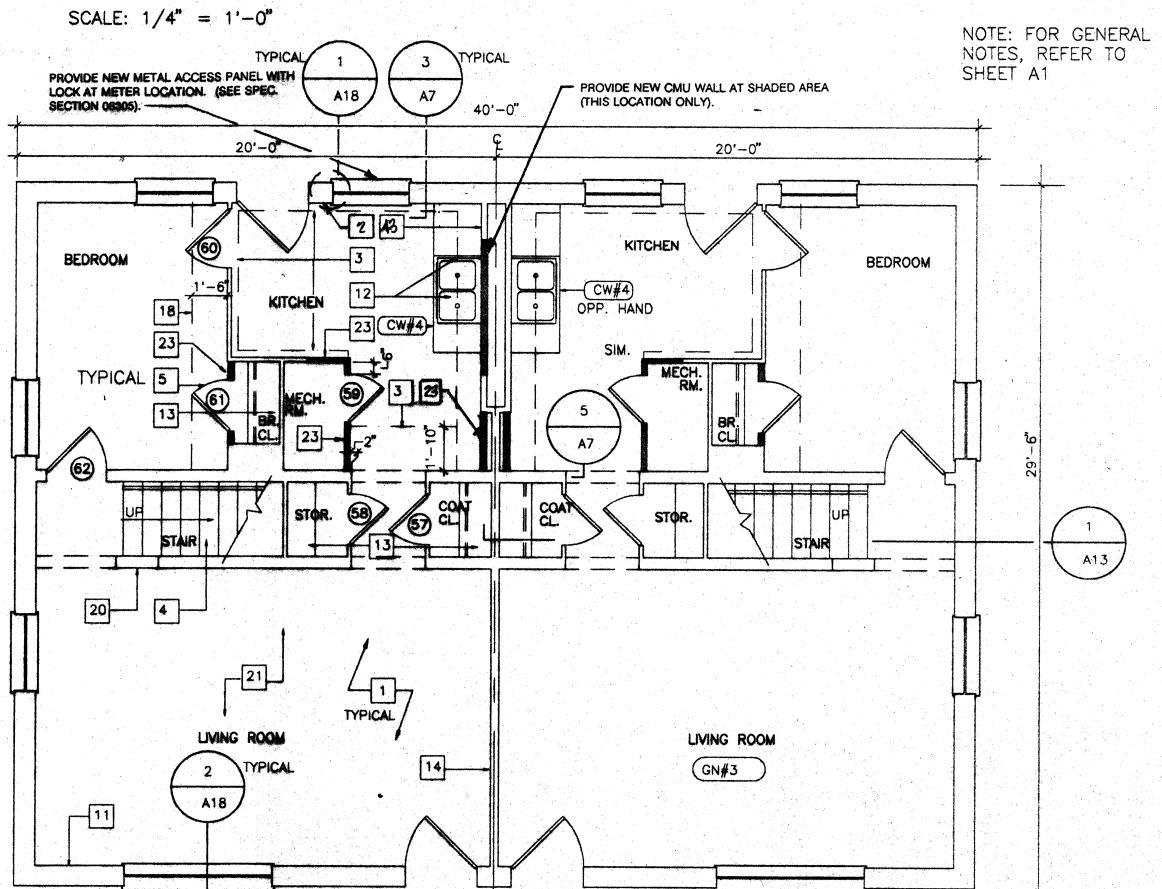




SECOND FLOOR PLAN - BLDG. D4 (DEMOLITION)
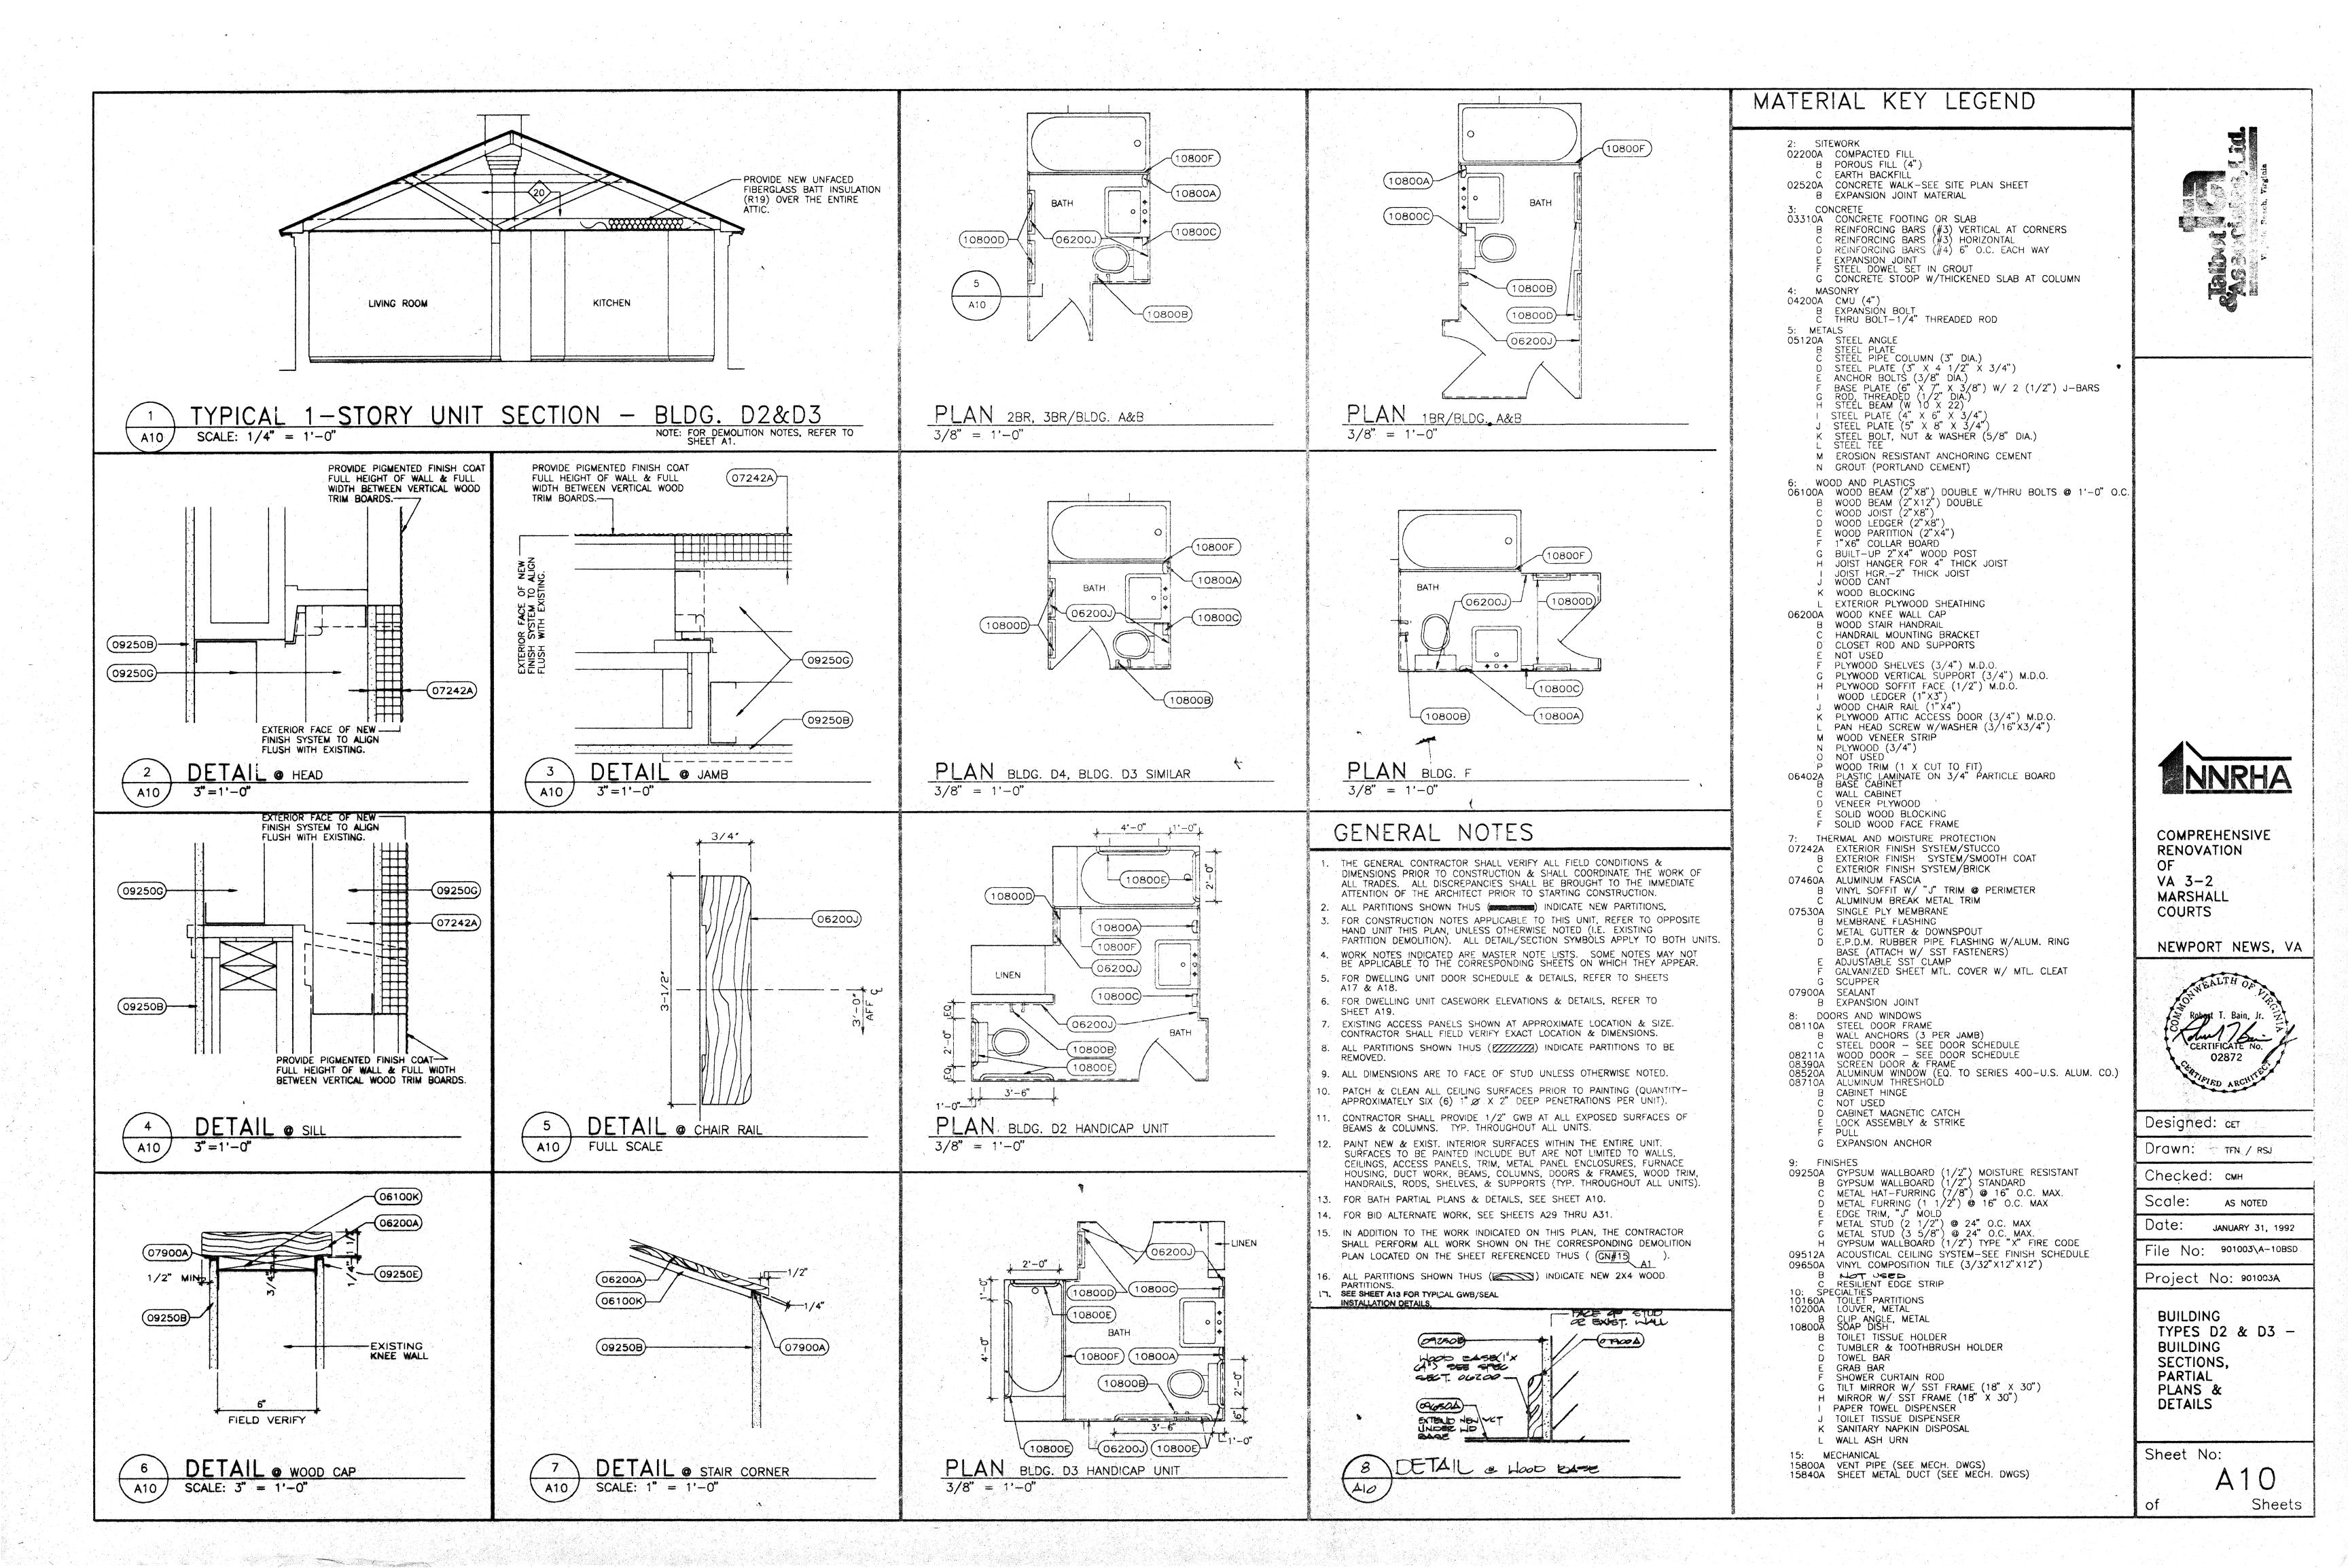
### FIRST FLOOR PLAN - BLDG. D4 (DEMOLITION)

SCALE: 1/4" = 1'-0"



PROVIDE NEW CMU WALL AT SHADED AREA (THIS LOCATION ONLY). 20'-0" 20'-0" BEDROOM BEDROOM BR. CL. BR. CL. [5] 23\_\_\_ (GN#3 BEDROOM 14 BEDROOM BEDROOM BEDROOM TYPICAL A18

SECOND FLOOR PLAN - BLDG. D4 (NEW WORK)

FIRST FLOOR PLAN - BLDG. D4 (NEW WORK)

SCALE: 1/4" = 1'-0"

SCALE: 1/4" = 1'-0"

# DEMOLITION NOTES

- 1. REMOVE EXISTING WOOD SHELVING WITH SUPPORTS & RODS, PER SPECIFICATION SECTION 02090. (2 SHELVES EA. @ STORAGE, 4 SHELVES EA. @ LINEN & PANTRY, 1 ROD & 2 SHELVES EA. @ COAT CLOSETS, 2 RODS & 2 SHELVES EA. @ BEDROOM CLOSETS, 2 RODS & 1 SHELF
- EA. @ STAIR CLOSETS. 2. REMOVE EXISTING WOOD ACCESS PANEL & TRIM PER SPECIFICATION SECTION 02090. FRAME & PATCH EXISTING OPENING WITH 1/2" GWB @ BLDG. D2, HANDICAPPED CONVERSION ONLY.
- 3. REMOVE ALL EXISTING WOOD TRIM THROUGHOUT ALL BLDG. SPACES, PER SPECIFICATION SECTION 02090.
- 4. REMOVE PAINT FROM ALL SURFACES OF METAL STAIR PER SPECIFICATION SECTION 02090.
- 5. REMOVE EXIST. INTERIOR WOOD DOORS COMPLETE WITH HARDWARE PER SPECIFICATION SECTION 02090 (TYPICAL-ALL INTERIOR WOOD DOORS). METAL FRAME SHALL REMAIN, UNLESS OTHERWISE NOTED. REMOVE PAINT FROM FRAME PER SPECIFICATION SECTION 02090.
- 6. REMOVE EXIST. KITCHEN CABINETRY PER SPECIFICATION SECTION 02090, AND COUNTERTOPS PER SPEC. SECTION 02070 (SST SINK TO BE REUSED).
- 7. REMOVE EXIST. PAINTED GWB PER SPECIFICATION SECTION 02090. REMOVE REMAINING STUD WALL COMPLETE.
- 8. REMOVE EXIST. WOOD DOOR, FRAMES, TRIM AND HARDWARE PER SPECIFICATION SECTION 02090 (TYP. ALL INTERIOR DOORS).
- 9. REMOVE EXIST. LEAD-BASED PAINT PER SPECIFICATION SECTION 02090 THEN REMOVE REMAINING PLASTER PARTITION.
- 10. REMOVE EXISTING WOOD CABINETRY/CASEWORK & COMPONENTS COMPLETE PER SPEC. SECTION NOTED. PATCH & REPAIR ALL DAMAGED SURFACES.
- 11. REMOVE EXIST. WOOD HANDRAIL & SUPPORTS PER SPECIFICATION SECTION 02090. PATCH AND REPAIR ALL DAMAGED SURFACES.
- 12. REMOVE EXISTING FLOOR TILE AND WALL BASES COMPLETE AS DESIGNATED PER SPECIFICATION SECTION 02080. (INCLUDES MULTIPLE LAYERS. EXISTING MASTIC MATERIAL SHALL REMAIN.)
- 13. REMOVE PAINTED METAL ENCLOSURE PANEL PER SPECIFICATION SECTION 02090. FRAMING TO REMAIN.
- 14. REMOVE EXISTING PLUMBING FIXTURES COMPLETE. PATCH & REPAIR ALL DAMAGED SURFACES SCHEDULED TO REMAIN.
- 15. REMOVE EXIST. EXTERIOR DOOR, EXTERIOR SCREEN DOOR, FRAME & TRIM COMPLETE. REMOVE PORTION OF EXTERIOR WALL TO ACCOMODATE NEW DOOR AS SCHEDULED. SEE SHEET A17 FOR SCHEDULE & DETAILS. (TYPICAL ALL EXTERIOR DOORS @ DAYCARE UNIT, D2 HANDICAP CONVERSION, AND D3 HANDICAP CONVERSION)
- 16. REMOVE EXIST LEAD-BASED PAINT PER SPECIFICATION SECTION 02090 THEN REMOVE REMAINING BLOCK WALL.
- 17. REMOVE EXIST. PAINTED METAL ENCLOSURE AND COMPONENTS PER SPECIFICATION SECTION 02090. SEE MECHANICAL SHEET FOR FURTHER DEMOLITION.
- 18. 21. NOT SHOWN 22. REMOVE EXISTING INTERIOR WOOD DOORS COMPLETE WITH HARDWARE &
- HM FRAMES PER SPECIFICATION SECTION 02090. 23. EXISTING MIRROR/MEDICINE CABINET TO REMAIN. REMOVE & REINSTALL
- AS REQUIRED. 24. - 33. NOT SHOWN

35. - 37. NOT SHOWN.

34. REMOVE EXISTING BATH ACCESSORIES, TO INCLUDE TOILET TISSUE DISPENSER, TOWEL BAR TUMBLER/TOOTHBRUSH HOLDER, SOAP DISH AND SHOWER CURTAIN ROD AS REQUIRED PER SPECIFICATION SECTION 02070.

- 1. PROVIDE NEW 1/2" GYPSUM WALLBOARD. SCREW & LAMINATE TO EXISTING PLASTER/CMU PARTITIONS, EXIST. FURRING, COLUMNS & BEAMS (TYPICAL ALL SPACES THROUGHOUT UNIT).
- 2. PROVIDE NEW 1-1/2" METAL FURRING CHANNELS & 1/2" GYPSUM WALLBOARD. (ENTIRE WALL)
- PROVIDE NEW METAL STUD FRAMING WITH 1/2" GYPSUM
- WALLBOARD SOFFIT W/ REMOVABLE 1/2" PLYWOOOD FRONT PANEL. 4. PROVIDE NEW RUBBER STAIR TREADS.
- PROVIDE NEW HOLLOW CORE WOOD DOORS. SEE DOOR SCHEDULE, SHEET A17. (TYPICAL ALL INTERIOR WOOD DOORS, PROVIDE HM FRAMES AS INDICATED ON DOOR SCHEDULE, DOOR TO BE CENTERED IN NEW PARTITION UNLESS OTHERWISE DIMENSIONED).
- PROVIDE NEW 3-5/8" METAL STUD & 1/2" GYPSUM WALLBOARD PARTITION (FLOOR TO CEILING HEIGHT, WORK INCLUDES AREA ABOVE DOORS) - FRAME FLUSH TO EXISTING PARTITIONS. STAGGER MTL. STUDS WHERE REQUIRED TO PROVIDE FLUSH TRANSITION INTO EXIST. WALL OR NEW
- MTL. FURRING. TYP. ALL LOCATIONS INDICATED UNLESS OTHERWISE NOTED. 7. PROVIDE NEW 1 X 4 WOOD CHAIR RAIL. (MTG. HEIGHT-36" TO C OF RAIL) SEE DETAIL 5/A10.
- 8. PROVIDE 1/2" PLYWOOD AT UNDERSIDE OF STAIR OR LANDING (SECURE TO BOTTOM OF STRINGER OR SUPPORT CHANNELS).
- 9. PROVIDE NEW 1/4" PLYWOOD ACCESS PANEL & TRIM. PROVIDE NEW FRAMED OPENING @ BLDG. D2 HANDICAPPED CONVERSION ONLY.
- 10. PROVIDE NEW EXTERIOR METAL DOOR W/SCREEN IN NEW HOLLOW METAL FRAME. PROVIDE NEW BLOCKING AND FINISH WALL. SEE SHEET A17 FOR SCHEDULE & DETAILS. (TYPICAL ALL DOORS @ DAYCARE UNIT, D2 HANDICAP
- CONVERSION & D3 HANDICAP CONVERSION) PROVIDE NEW 7/8" METAL FURRING CHANNELS & 1/2" GWB. (ENTIRE WALL) 12. PROVIDE NEW NATURAL FINISH PLYWOOD AND SOLID WOOD CABINETS,
- 13. PROVIDE NEW WOOD SHELVING AND RODS. (2 SHELVES EA. @ STORAGE, 4 SHELVES EA. @ LINEN & PANTRY, 1 ROD & 2 SHELVES EA. @ BEDROOM & COAT CLOSETS, 2 RODS & 2 SHELVES EA. @ STAIR CLOSETS, 1 ROD & 1 SHELF EA. @ BATH. FOR DETAILS, SEE SHEET A19).

NEW COUNTERTOPS AND FULL HEIGHT BACKSPLASH.

- 14. PROVIDE NEW 4" WOOD BASE (TYPICAL ALL PARTITIONS) SEE 8/AID.
- 15. PROVIDE NEW 6" METAL STUD PARTITION WITH 1/2"
- GYPSUM WALLBOARD. 16. PROVIDE NEW HOLLOW METAL DOOR FRAMES.

SEE DETAILS 6 & 7/A19.)

PLANS, SHEET A10.


- 17. PROVIDE NEW 1/2" GYPSUM WALLBOARD CEILING, SLOPE TO MATCH STAIR-SEE SECTION 1/A13.
- 18. PROVIDE NEW METAL STUD FRAMING WITH 1/2" GYPSUM WALLBOARD SOFFITS. 19. PROVIDE NEW 1-1/2" WOOD HANDRAIL SUPPORTED BY NEW METAL BRACKETS & SECURED TO EXISTING PARTITION. (CLEAR STAIN FINISH,
- 20. PROVIDE NEW WOOD CAP. (CLEAR STAIN FINISH) SEE DETAIL 6/A10. 21. PROVIDE NEW 12" X 12" VINYL COMPOSITION FLOOR TILE THROUGHOUT
- UNIT ALL SPACES. (UNLESS OTHERWISE NOTED.)
- 22. PROVIDE NEW 1/2" GYPSUM WALLBOARD FASTENED TO EXISTING METAL FRAMED DUCT ENCLOSURE.
- 23. PROVIDE NEW 2-1/2" METAL STUDS & 1/2" GYPSUM WALLBOARD PARTITION (FLOOR TO CEILING HEIGHT, WORK INCLUDES AREA ABOVE DOORS) - FRAME FLUSH TO EXISTING PARTITIONS. TYPICAL ALL LOCATIONS INDICATED.
- 24. PATCH HOLES RESULTING FROM MECHANICAL DEMOLITION PER SPEC. SECTION 07242A (SEE MECHANICAL DRAWINGS).
- 25. PROVIDE NEW 1 X 6 WD TRIM AT AREA BETWEEN WINDOWS. (SHAPE TO MATCH EXISTING.)
- 26. PATCH EXIST. OPENING RESULTING FROM MECHANICAL DEMOLITION IN SECOND
- FLOOR SLAB WITH CONCRETE, (SEE MECHANICAL DRAWINGS) 27. - 36. NOT SHOWN
- 37. PROVIDE NEW BATH ACCESSORIES, TO INCLUDE TOILET TISSUE DISPENSER, TOWEL BAR, TUMBLER/TOOTHBRUSH HOLDER, SOAP DISH AND SHOWER CURTAIN ROD, PER SPECIFICATION SECTION 10800. SEE BATH PARTIAL
- 38. 42. NOT SHOWN. 43. PROVIDE NEW 2"X2" WOOD FURRING WITH 1/2" G. WB (ENTIRE



COMPREHENSIVE RENOVATION VA 3-2MARSHALL

COURTS

NEWPORT NEWS, VA

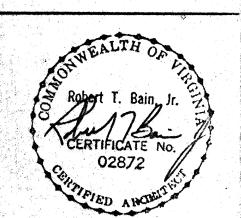

Designed: CET

Drawn: TEN / RSJ

Checked: CMH

Scale: AS NOTED


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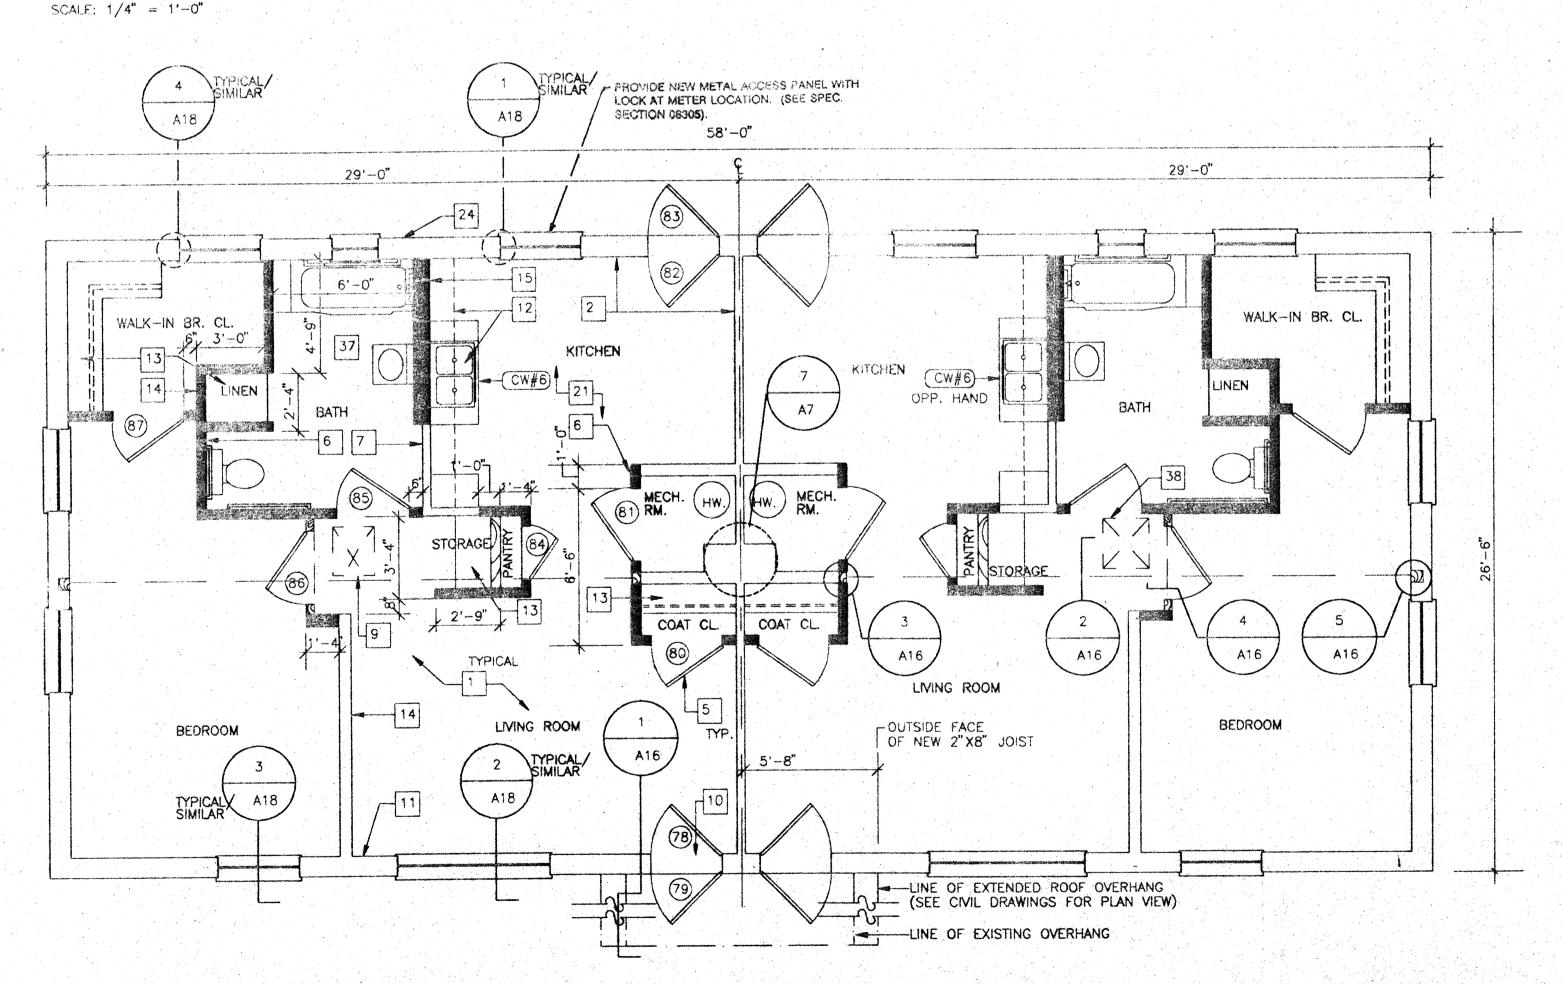
Project No:

BUILDING TYPE D4 -FLOOR PLANS (DEMOLITION & NEW WORK)

Sheet No:



FLOOR PLAN - BUILDING D2 / 1BR HANDICAP CONVERSION (DEMOLITION)

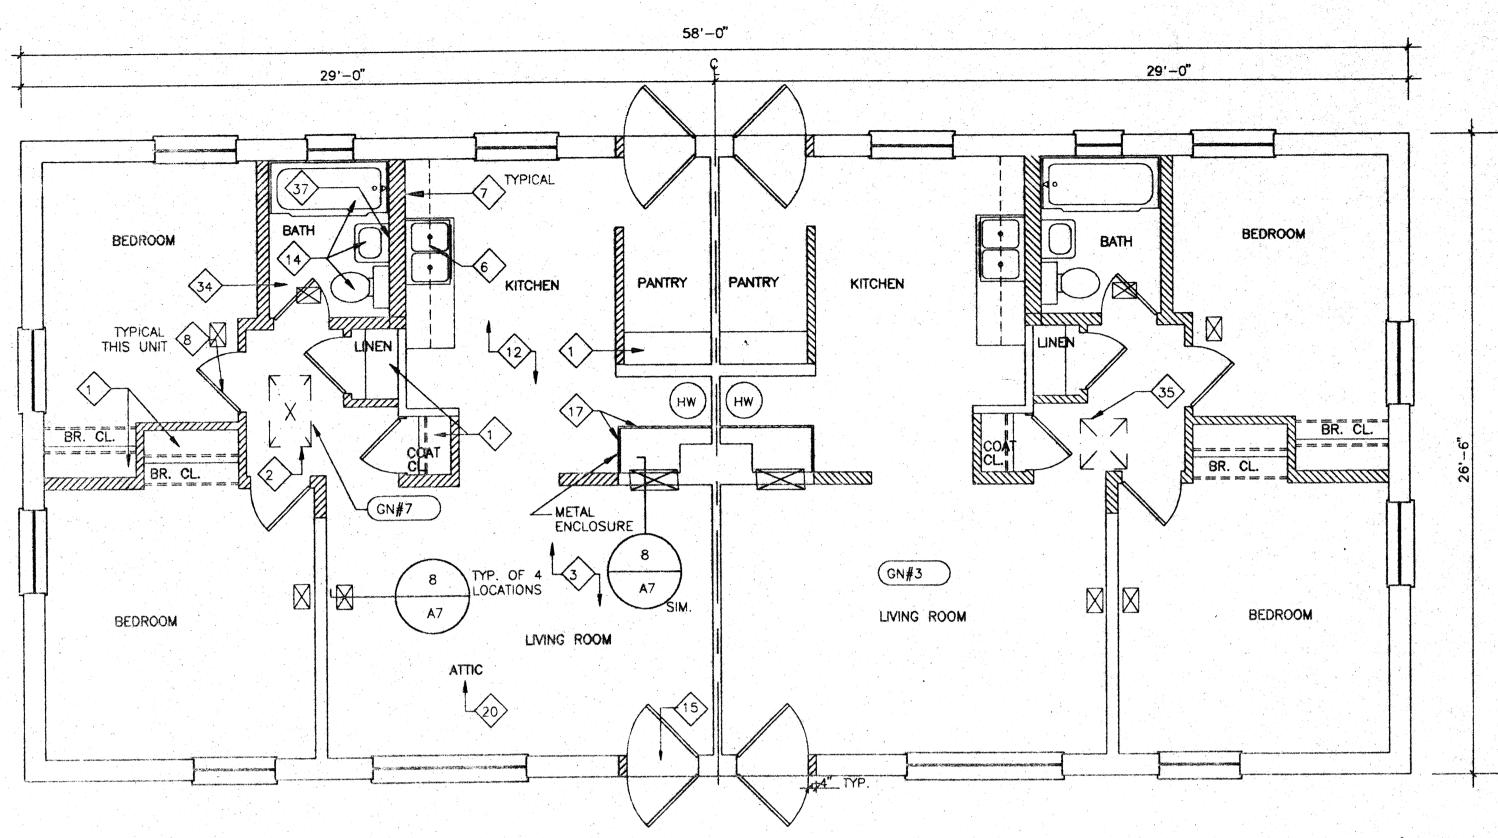

FLOOR PLAN - BUILDING D2 / 1BR HANDICAP CONVERSION (NEW WORK)

SCALE: 1/4" = 1'-0"

### > DEMOLITION NOTES

- 1. REMOVE EXISTING WOOD SHELVING WITH SUPPORTS & RODS, PER SPECIFICATION SECTION 02090. (2 SHELVES EA. STORAGE, 4 SHELVES EA. LINEN & PANTRY, 1 ROD & 2 SHELVES EA. COAT CLOSETS, 2 RODS & 2 SHELVES EA. BEDROOM CLOSETS, 2 RODS & 1 SHELF EA. STAIR CLOSETS.
- 2. REMOVE EXISTING WOOD ACCESS PANEL & TRIM PER SPECIFICATION SECTION 02090. FRAME & PATCH EXISTING OPENING WITH 1/2" GWB BLDG. D2, HANDICAPPED CONVERSION ONLY.
- 3. REMOVE ALL EXISTING WOOD TRIM THROUGHOUT ALL BLDG. SPACES, PER SPECIFICATION SECTION 02090.
- 4. REMOVE PAINT FROM ALL SURFACES OF METAL STAIR PER SPECIFICATION SECTION 02090.
- 5. REMOVE EXIST. INTERIOR WOOD DOORS COMPLETE WITH HARDWARE PER SPECIFICATION SECTION 02090 (TYPICAL—ALL INTERIOR WOOD DOORS).

  METAL FRAME SHALL REMAIN, UNLESS OTHERWISE NOTED. REMOVE PAINT FROM FRAME PER SPECIFICATION SECTION 02090.
- 6. REMOVE EXIST. KITCHEN CABINETRY PER SPECIFICATION SECTION 02090, AND COUNTERTOPS PER SPEC. SECTION 02070 (SST SINK TO BE REUSED).
- 7. REMOVE EXIST. PAINTED GWB PER SPECIFICATION SECTION 02090. REMOVE REMAINING STUD WALL COMPLETE.
- 8. REMOVE EXIST. WOOD DOOR, FRAMES, TRIM AND HARDWARE PER SPECIFICATION SECTION 02090 (TYP. ALL INTERIOR DOORS).
- 9. REMOVE EXIST. LEAD-BASED PAINT PER SPECIFICATION SECTION 02090 THEN REMOVE REMAINING PLASTER PARTITION.
- 10. REMOVE EXISTING WOOD CABINETRY/CASEWORK & COMPONENTS COMPLETE, PER SPEC. SECTION NOTED. PATCH & REPAIR ALL DAMAGED SURFACES.

  11. REMOVE EXIST. WOOD HANDRAIL & SUPPORTS PER SPECIFICATION SECTION 02090. PATCH AND REPAIR ALL DAMAGED SURFACES.
- 2. REMOVE EXISTING FLOOR TILE AND WALL BASES COMPLETE AS DESIGNATED PER SPECIFICATION SECTION 02080. (INCLUDES MULTIPLE LAYERS. EXISTING MASTIC MATERIAL SHALL REMAIN.)
- 3. REMOVE PAINTED METAL ENCLOSURE PANEL PER SPECIFICATION SECTION 02090. FRAMING TO REMAIN.
- 14. REMOVE EXISTING PLUMBING FIXTURES COMPLETE. PATCH & REPAIR ALL DAMAGED SURFACES SCHEDULED TO REMAIN.
- 15. REMOVE EXIST. EXTERIOR DOOR, EXTERIOR SCREEN DOOR, FRAME & TRIM COMPLETE. REMOVE PORTION OF EXTERIOR WALL TO ACCOMODATE NEW DOOR AS SCHEDULED. SEE SHEET A17 FOR SCHEDULE & DETAILS. (TYPICAL ALL EXTERIOR DOORS @ DAYCARE UNIT, D2 HANDICAP CONVERSION, AND D3 HANDICAP CONVERSION)
- 16. REMOVE EXIST. LEAD-BASED PAINT PER SPECIFICATION SECTION 02090 THEN REMOVE REMAINING BLOCK WALL.
- 17. REMOVE EXIST. PAINTED METAL ENCLOSURE AND COMPONENTS PER SPECIFICATION SECTION 02090. SEE MECHANICAL SHEET, FOR FURTHER DEMOLITION.
- 18. REMOVE EXIST. PTD. METAL HEADER PER SPECIFICATION SECTION 02090.

  19. REMOVE CONTAMINATED SOIL TO A DEPTH OF 2" PER SPEC. SECTION 02080
- 20. REMOVE CONTAMINATED BLOWN INSULATION PER SPEC. SECTION 02080.
- 21. REMOVE EXISTING TERRACOTTA FLUE AND CEMENTITIOUS FILL IN ADDITION
  TO OTHER WALL DEMOLITION. FILL RESULTING VOIDS W/ CONCRETE &
- REPAIR ALL DAMAGED SURFACES SCHEDULED TO REMAIN.

  22. REMOVE EXISTING INTERIOR WOOD DOORS COMPLETE WITH HARDWARE & HM FRAMES PER SPECIFICATION SECTION 02090.
- 3. EXISTING MIRROR/MEDICINE CABINET TO REMAIN. REMOVE & REINSTALL AS REQUIRED.
- 24. REMOVE EXIST. LEAD-BASED PAINT FROM METAL PANEL ENCLOSURE
  PER SPECIFICATION SECTION 02090. EXIST. FACTORY—FINISHED FURNACE.
- HOUSING SHALL REMAIN.

  25. REMOVE EXIST. TOILET PARTITIONS COMPLETE. PATCH & REPAIR ALL
- DAMAGED SURFACES, SCHEDULED TO REMAIN.
- 26. REMOVE EXIST. TLT. ACCESSORIES COMPLETE, INCLUDING TLT. TISSUE DISPENSERS, PAPER TOWEL DISPENSER, SANITARY NAPKIN DISPOSAL, MIRRORS, SOAP DISPENSERS, ETC.
- 27. REMOVE EXIST. WIRE FENCE PARTITION & SUPPORTS COMPLETE. PATCH & REPAIR ALL DAMAGED SURFACES SCHEDULED TO REMAIN.
- 28. REMOVE EXIST. 12"x12" CLG. TILES & SUPPORTS LOCATED ABOVE 2'x4'
  CLG. TILES PER SPECIFICATION SECTION 02080. (WORK INCLUDES ALL
- AREAS BOUNDED BY HEAVY DASHED LINES.)
  29. REMOVE EXIST. WINDOW, FRAME, SILL & COMPONENTS COMPLETE. PATCH
- & REPAIR ALL DAMAGED SURFACES SCHEDULED TO REMAIN.

  30. REMOVE EXIST. WALL PANELLING, FURRING & TRIM PER SPEC. SECTION
- 30. REMOVE EXIST. WALL PANELLING, FURRING & TRIM PER SPEC. SECTION NOTED. (ALL WALLS THIS SPACE.)
- 31. REMOVE EXIST. MTL. DOOR, TRIM & HARDWARE PER SPEC. SECTION 02070 SALVAGE MTL. DOOR & HARDWARE REMOVE EXIST. DOOR FRAME PER SPEC. SECTION 02090.
- 32. 33. NOT SHOWN

  34. REMOVE EXISTING BATH ACCESSORIES, TO INCLUDE TOILET TISSUE DISPENSER, TOWEL BAR TUMBLER/TOOTHBRUSH HOLDER, SOAP DISH AND SHOWER
- TOWEL BAR TUMBLER/TOOTHBRUSH HOLDER, SOAP DISH AND SHOWER CURTAIN ROD AS REQUIRED PER SPECIFICATION SECTION 02070.

  35. REMOVE EXISTING CEILING AND FRAMING TO PROVIDE ATTIC ACCESS
- TO MATCH OPENING SIZE AND LOCATION OF ADJACENT UNIT PER SPECIFICATION SECTION 02090.
- 37. REMOVE EXISTING MIRROR/MEDICINE CABINET PER SPECIFICATION SECTION 02070.

NOTE: BUILDING TYPE D2 UNITS TO RECEIVE HANDICAPPED CONVERSION ARE AS FOLLOWS:

770A (26 T STEET)
770B (36 T STEET)
771A
771B
800A
800B
801A

(FOR SITE LOCATION, & RELATED WORK, SEE CIVIL DWGS.)

### NEW WORK NOTES

- 1. PROVIDE NEW 1/2" GYPSUM WALLBOARD. SCREW & LAMINATE TO EXISTING PLASTER/CMU PARTITIONS, EXIST. FURRING, COLUMNS & BEAMS (TYPICAL ALL SPACES THROUGHOUT UNIT).
- 2. PROVIDE NEW 1-1/2" METAL FURRING CHANNELS & 1/2" GYPSUM WALLBOARD. (ENTIRE WALL)
- 3. PROVIDE NEW METAL STUD FRAMING WITH 1/2" GYPSUM WALLBOARD SOFFIT W/ REMOVABLE 1/2" PLYWOOOD FRONT PANEL.
- PROVIDE NEW RUBBER STAIR TREADS.
   PROVIDE NEW HOLLOW CORE WOOD DOORS. SEE DOOR SCHEDULE, SHEET A17. (TYPICAL ALL INTERIOR WOOD DOORS, PROVIDE HM FRAMES AS INDICATED ON DOOR SCHEDULE, DOOR TO BE CENTERED IN NEW PARTITION UNLESS OTHERWISE DIMENSIONED).
- 6. PROVIDE NEW 3-5/8" METAL STUD & 1/2" GYPSUM WALLBOARD PARTITION (FLOOR TO CEILING HEIGHT, WORK INCLUDES AREA ABOVE DOORS) FRAME FLUSH TO EXISTING PARTITIONS. STAGGER MTL. STUDS WHERE REQUIRED TO PROVIDE FLUSH TRANSITION INTO EXIST. WALL OR NEW MTL. FURRING. TYP. ALL LOCATIONS INDICATED UNLESS OTHERWISE NOTED.
- 7. PROVIDE NEW 1 X 4 WOOD CHAIR RAIL. (MTG. HEIGHT-36" TO C OF RAIL)
  SEE DETAIL 5/A10.
- 8. PROVIDE 1/2" PLYWOOD AT UNDERSIDE OF STAIR OR LANDING (SECURE TO BOTTOM OF STRINGER OR SUPPORT CHANNELS).

PROVIDE NEW EXTERIOR METAL DOOR W/SCREEN IN NEW HOLLOW METAL

- 9. PROVIDE NEW 1/4" PLYWOOD ACCESS PANEL & TRIM. PROVIDE NEW FRAMED OPENING @ BLDG. D2 HANDICAPPED CONVERSION ONLY.
- FRAME. PROVIDE NEW BLOCKING AND FINISH WALL. SEE SHEET A17 FOR SCHEDULE & DETAILS. (TYPICAL ALL DOORS @ DAYCARE UNIT, D2 HANDICAP CONVERSION & D3 HANDICAP CONVERSION)
- 11. PROVIDE NEW 7/8" METAL FURRING CHANNELS & 1/2" GWB. (ENTIRE WALL)

  12. PROVIDE NEW NATURAL FINISH PLYWOOD AND SOLID WOOD CABINETS,
- NEW COUNTERTOPS AND FULL HEIGHT BACKSPLASH.

  13. PROVIDE NEW WOOD SHELVING AND RODS. (2 SHELVES EA. @ STORAGE,
  4 SHELVES EA. @ LINEN & PANTRY, 1 ROD & 2 SHELVES EA. @ BEDROOM
  & COAT CLOSETS, 2 RODS & 2 SHELVES EA. @ STAIR CLOSETS, 1 ROD &
  1 SHELF EA. @ BATH. FOR DETAILS, SEE SHEET A19).
- 14. PROVIDE NEW 4" HOOD! BASE. (TYPICAL ALL PARTITIONS) SEE 8/A10
- 15. PROVIDE NEW 6" METAL STUD PARTITION WITH 1/2" GYPSUM WALLBOARD.
- 16. PROVIDE NEW HOLLOW METAL DOOR FRAMES.
- 17. PROVIDE NEW 1/2" GYPSUM WALLBOARD CEILING, SLOPE TO MATCH STAIR-SEE SECTION 1/A13.
- 18. PROVIDE NEW METAL STUD FRAMING WITH 1/2" GYPSUM WALLBOARD SOFFITS.

  19. PROVIDE NEW 1-1/2" WOOD HANDRAIL SUPPORTED BY NEW METAL
  BRACKETS & SECURED TO EXISTING PARTITION. (CLEAR STAIN FINISH,
  SEE DETAILS 6 & 7/A19.)
- 20. PROVIDE NEW WOOD CAP. (CLEAR STAIN FINISH) SEE DETAIL 6/A10.
  21. PROVIDE NEW 12" X 12" VINYL COMPOSITION FLOOR TILE THROUGHOUT
- UNIT ALL SPACES. (UNLESS OTHERWISE NOTED.)

  22. PROVIDE NEW 1/2" GYPSUM WALLBOARD FASTENED TO EXISTING
- METAL FRAMED DUCT ENCLOSURE.

  23. PROVIDE NEW 2-1/2" METAL STUDS & 1/2" GYPSUM WALLBOARD PARTITION (FLOOR TO CEILING HEIGHT, WORK INCLUDES AREA ABOVE DOORS) FRAME FLUSH TO EXISTING PARTITIONS. TYPICAL ALL
- LOCATIONS INDICATED.

  24. PATCH HOLES RESULTING FROM MECHANICAL DEMOLITION PER SPEC. SECTION 07242A (SEE MECHANICAL DRAWINGS).
- 25. PROVIDE NEW 1 X 6 WD TRIM AT AREA BETWEEN WINDOWS. (SHAPE TO MATCH EXISTING.)
- 26. PATCH EXIST. OPENING RESULTING FROM MECHANICAL DEMOLITION IN SECOND FLOOR SLAB WITH CONCRETE. (SEE MECHANICAL DRAWINGS)
- FLOOR SLAB WITH CONCRETE. (SEE MECHANICAL DRAWINGS)

  27. PROVIDE 2 1/2" METAL STUD CEILING FRAMING WITH 1/2" GWB THIS SIDE
  OF BEAM ONLY IN HALLWAY. BOTTOM OF DROP CLG. TO BE 3/4" HIGHER
  THAN BOTTOM OF EXIST. BEAM. COORDINATE LOCATION OF FRAMING
- WITH MECHANICAL DUCT. (SEE SHEET M-6.)

  28. PROVIDE NEW HOLLOW CORE FLUSH WOOD BI-FOLD DOOR, TYPE E AS SHOWN ON SHEET A17. PROVIDE HARDWARE PER SPECIFICATION SECTION 08700. INSTALL DOOR VIA FLOOR & CEILING CONNECTIONS ONLY.
- 29. PROVIDE REQUIRED BLOCKING & SUPPORT FOR WALL-MOUNTED EQUIPMENT (COORDINATE WITH MECHANICAL/ELECTRICAL DRAWINGS).
- (COORDINATE WITH MECHANICAL/ELECTRICAL DRAWINGS).

  30. PROVIDE NEW EXTERIOR FINISH SYSTEM AS NOTED.

  31. PROVIDE NEW WOOD TRIM (1x REQ'D. WIDTH) AT ALL WINDOW LOCATIONS
- 32. PROVIDE NEW FINISH AT STAGE FLOOR (SEE SPECIFICATION SECTION 09900).
- 33. REPAIR CONCRETE SLAB RESULTING FROM PLUMBING DEMOLITION. PROVIDE CEMENTITIOUS LEVELING MATERIAL OVER ENTIRE ROOM.

  34. 36. NOT SHOWN.
- 37. PROVIDE NEW BATH ACCESSORIES, TO INCLUDE TOILET TISSUE DISPENSER TOWEL BAR, TUMBLER/TOOTHBRUSH HOLDER, SOAP DISH AND SHOWER CURTAIN ROD, PER SPECIFICATION SECTION 10800. SEE BATH PARTIAL PLANS, SHEET A10.
- 38. PROVIDE NEW ATTIC ACCESS TO MATCH ACCESS IN ADJACENT UNIT. NEW WORK TO INCLUDE FRAMED OPENING, 1/4" PLYWOOD ACCESS PANEL AND TRIM
  - TRIM.
     42 NOT SHOWN
- 39. 42. NOT SHOWN.

SHEET A19.

### GENERAL NOTES

- THE GENERAL CONTRACTOR SHALL VERIFY ALL FIELD CONDITIONS & DIMENSIONS PRIOR TO CONSTRUCTION & SHALL COORDINATE THE WORK OF ALL TRADES. ALL DISCREPANCIES SHALL BE BROUGHT TO THE IMMEDIATE ATTENTION OF THE ARCHITECT PRIOR TO STARTING CONSTRUCTION.
- ALL PARTITIONS SHOWN THUS ( ) INDICATE NEW PARTITIONS
   FOR CONSTRUCTION NOTES APPLICABLE TO THIS UNIT, REFER TO OPPOSITE HAND UNIT THIS PLAN, UNLESS OTHERWISE NOTED (I.E. EXISTING PARTITION DEMOLITION). ALL DETAIL/SECTION SYMBOLS APPLY TO BOTH UNITS
- WORK NOTES INDICATED ARE MASTER NOTE LISTS. SOME NOTES MAY NOT BE APPLICABLE TO THE CORRESPONDING SHEETS ON WHICH THEY APPEAR
   FOR DWELLING UNIT DOOR SCHEDULE & DETAILS, REFER TO SHEETS
- A17 & A18.

  6. FOR DWELLING UNIT CASEWORK ELEVATIONS & DETAILS, REFER TO
- EXISTING ACCESS PANELS SHOWN AT APPROXIMATE LOCATION & SIZE. CONTRACTOR SHALL FIELD VERIFY EXACT LOCATION & DIMENSIONS.


  ALL PARTITIONS SHOWN THUS (VIIIII) INDICATE PARTITIONS TO BE
- 9. ALL DIMENSIONS ARE TO FACE OF STUD UNLESS OTHERWISE NOTED.
- O. PATCH & CLEAN ALL CEILING SURFACES PRIOR TO PAINTING (QUANTITY-APPROXIMATELY SIX (6) 1" & X 2" DEEP PENETRATIONS PER UNIT).
- 11. CONTRACTOR SHALL PROVIDE 1/2" GWB AT ALL EXPOSED SURFACES OF BEAMS & COLUMNS. TYP. THROUGHOUT ALL UNITS.
- 2. PAINT NEW & EXIST. INTERIOR SURFACES WITHIN THE ENTIRE UNIT.
  SURFACES TO BE PAINTED INCLUDE BUT ARE NOT LIMITED TO WALLS,
  CEILINGS, ACCESS PANELS, TRIM, METAL PANEL ENCLOSURES, FURNACE
  HOUSING, DUCT WORK, BEAMS, COLUMNS, DOORS & FRAMES, WOOD TRIM,
  HANDRAILS, RODS, SHELVES, & SUPPORTS (TYP. THROUGHOUT ALL UNITS).
- 13. FOR BATH PARTIAL PLANS & DETAILS, SEE SHEET A10.
- 14. FOR BID ALTERNATE WORK, SEE SHEETS A29 THRU A31.
- 15. IN ADDITION TO THE WORK INDICATED ON THIS PLAN, THE CONTRACTOR SHALL PERFORM ALL WORK SHOWN ON THE CORRESPONDING DEMOLITION PLAN LOCATED ON THE SHEET REFERENCED THUS ( GN#15 ).
- 16. ALL PARTITIONS SHOWN THUS ( ) INDICATE NEW 2X4 WOOD



COMPREHENSIVE
RENOVATION
OF
VA 3-2
MARSHALL

COURTS

NEWPORT NEWS, VA

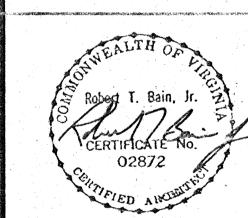

Designed: CET

Drawn: TFN / RSJ

Checked: CMH

Scale: AS NOTED

Date: JANUARY 31, 1992

File No: 901003\A-14DN


Project No: 901003A

BUILDING
TYPE D2 —
FLOOR PLANS
(DEMOLITION &
NEW WORK /
HANDICAPPED
CONVERSION)


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FLOOR PLAN - BUILDING D3 - HANDICAP CONVERSION (DEMOLITION)



FLOOR PLAN - BUILDING D3 - HANDICAP CONVERSION (NEW WORK)

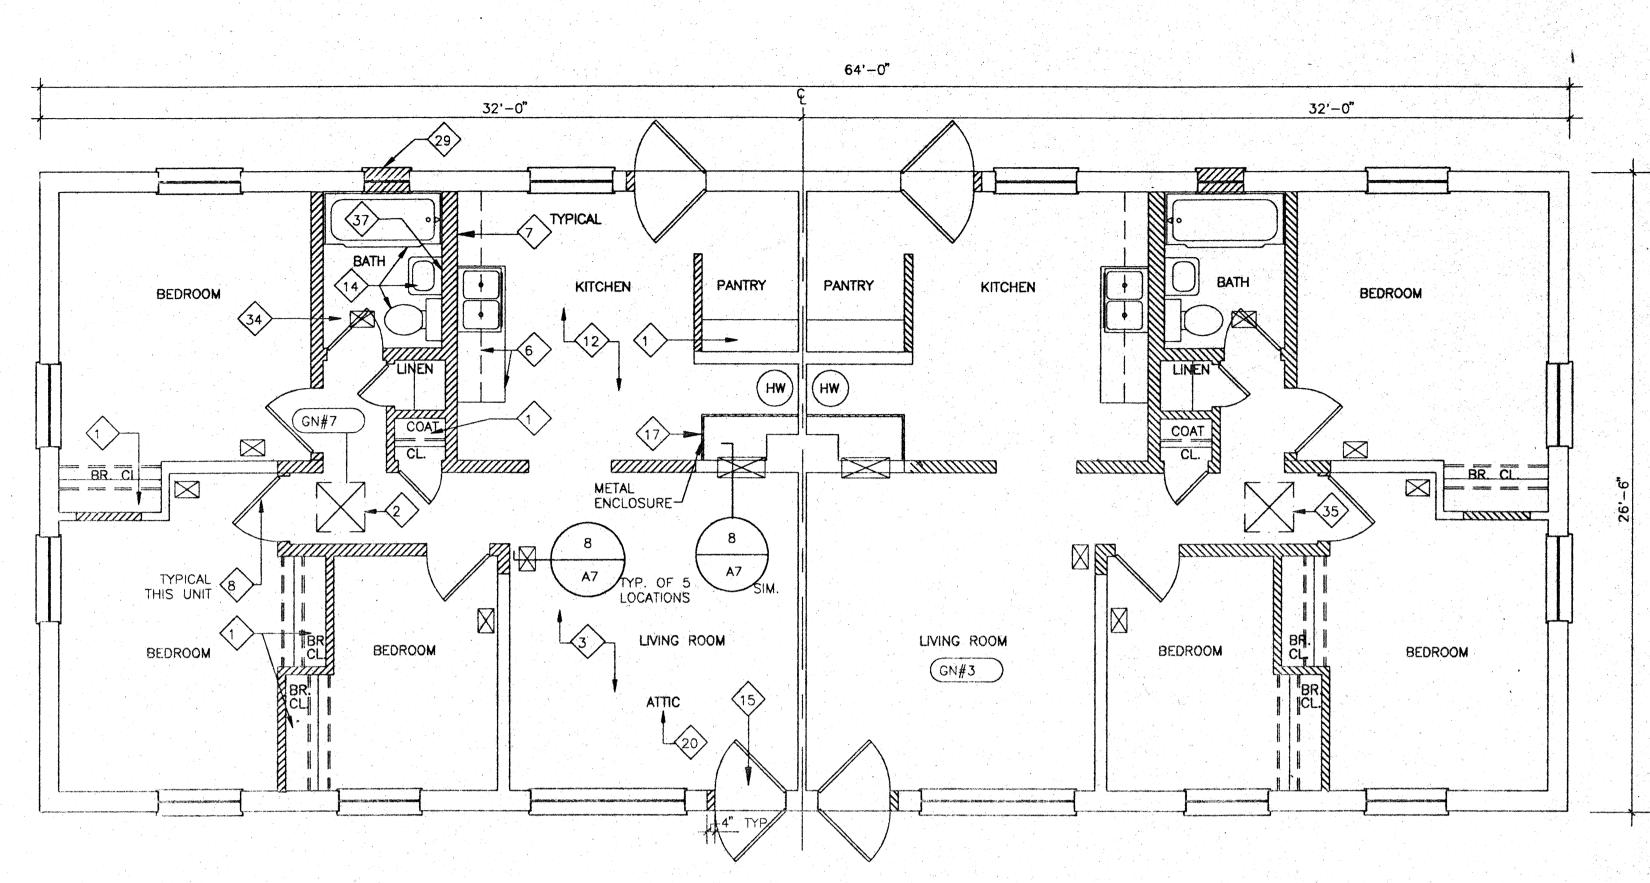SCALE: 1/4" = 1'-0"

### DEMOLITION NOTES

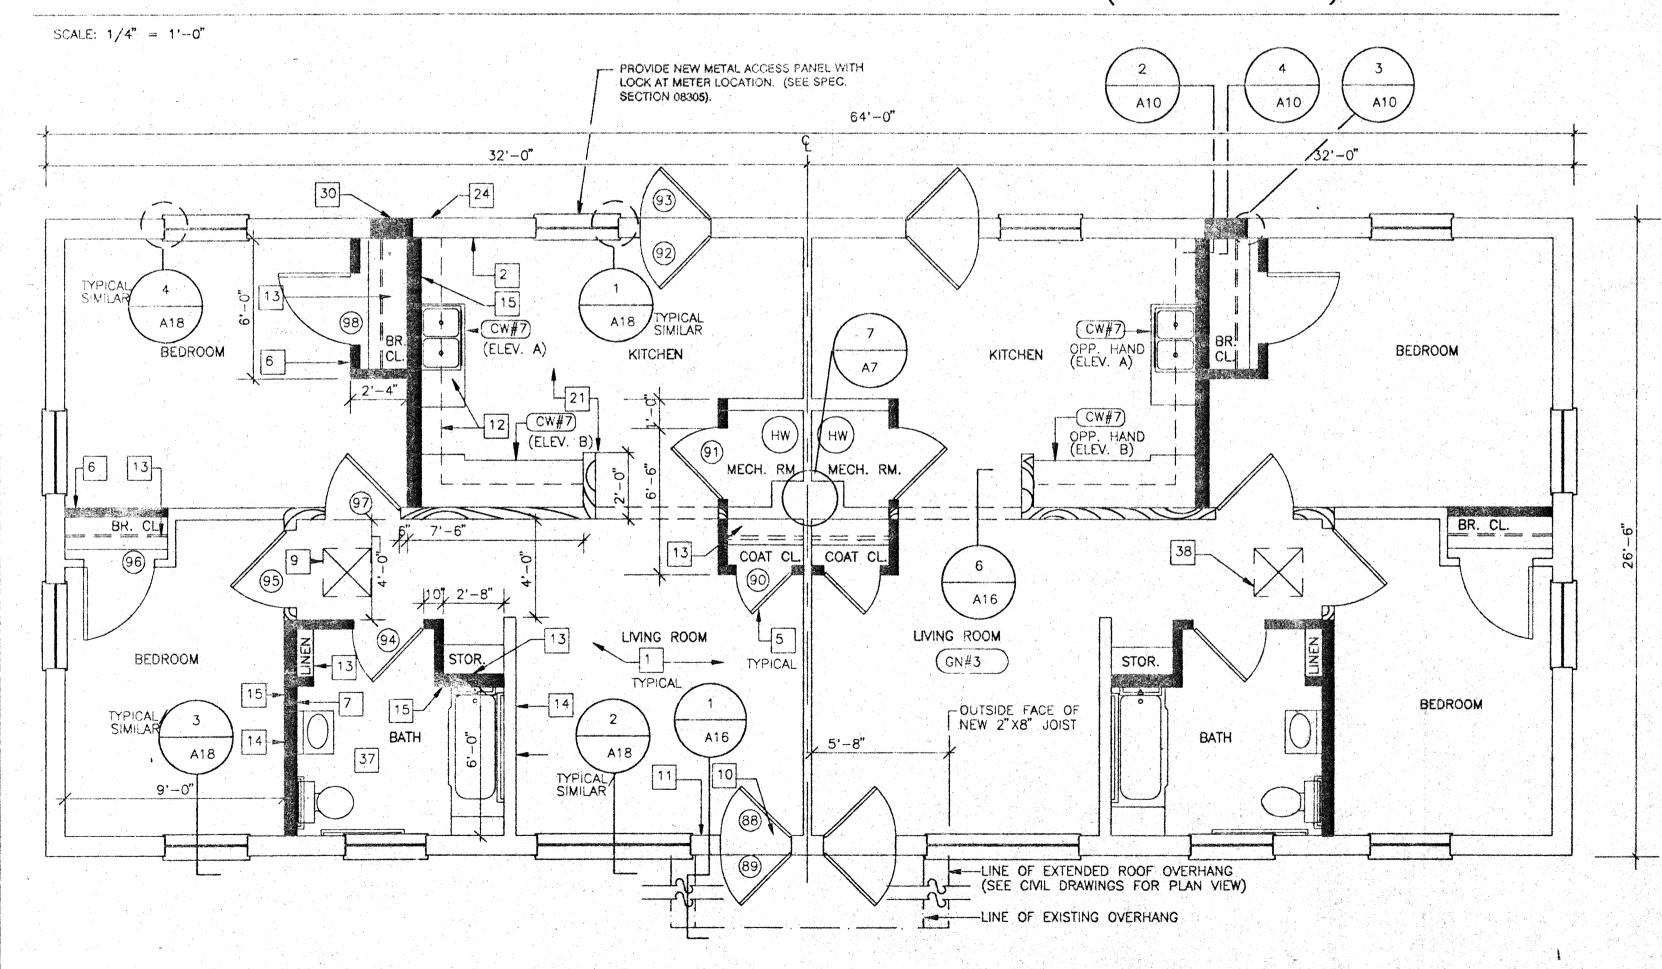- 1. REMOVE EXISTING WOOD SHELVING WITH SUPPORTS & RODS, PER SPECIFICATION SECTION 02090. (2 SHELVES EA. @ STORAGE, 4 SHELVES EA. @ LINEN & PANTRY, 1 ROD & 2 SHELVES EA. @ COAT CLOSETS, 2 RODS & 2 SHELVES EA. @ BEDROOM CLOSETS, 2 RODS & 1 SHELF EA. @ STAIR CLOSETS.
- 2. REMOVE EXISTING WOOD ACCESS PANEL & TRIM PER SPECIFICATION SECTION 02090. FRAME & PATCH EXISTING OPENING WITH 1/2" GWB & BLDG. D2, HANDICAPPED CONVERSION ONLY.
- 3. REMOVE ALL EXISTING WOOD TRIM THROUGHOUT ALL BLDG. SPACES, PER SPECIFICATION SECTION 02090.
- 4. REMOVE PAINT FROM ALL SURFACES OF METAL STAIR PER SPECIFICATION SECTION 02090.
- REMOVE EXIST. INTERIOR WOOD DOORS COMPLETE WITH HARDWARE PER SPECIFICATION SECTION 02090 (TYPICAL-ALL INTERIOR WOOD DOORS).

  METAL FRAME SHALL REMAIN, UNLESS OTHERWISE NOTED. REMOVE PAINT FROM FRAME PER SPECIFICATION SECTION 02090.
- 6. REMOVE EXIST. KITCHEN CABINETRY PER SPECIFICATION SECTION 02090, AND COUNTERTOPS PER SPEC. SECTION 02070 (SST SINK TO BE REUSED).
- 7. REMOVE EXIST. PAINTED GWB PER SPECIFICATION SECTION 02090.
  REMOVE REMAINING STUD WALL COMPLETE.
- REMOVE EXIST. WOOD DOOR, FRAMES, TRIM AND HARDWARE PER SPECIFICATION SECTION 02090 (TYP. ALL INTERIOR DOORS).
- 9. REMOVE EXIST. LEAD—BASED PAINT PER SPECIFICATION SECTION 02090 THEN REMOVE REMAINING PLASTER PARTITION.
- 10. REMOVE EXISTING WOOD CABINETRY/CASEWORK & COMPONENTS COMPLETE, PER SPEC, SECTION NOTED. PATCH & REPAIR ALL DAMAGED SURFACES.

  11. REMOVE EXIST. WOOD HANDRAIL & SUPPORTS PER SPECIFICATION SECTION
- 02090. PATCH AND REPAIR ALL DAMAGED SURFACES.

  12. REMOVE EXISTING FLOOR TILE AND WALL BASES COMPLETE AS DESIGNATED PER SPECIFICATION SECTION 02080. (INCLUDES MULTIPLE LAYERS.
- EXISTING MASTIC MATERIAL SHALL REMAIN.)

  13. REMOVE PAINTED METAL ENCLOSURE PANEL PER SPECIFICATION SECTION 02090. FRAMING TO REMAIN.
- 14. REMOVE EXISTING PLUMBING FIXTURES COMPLETE. PATCH & REPAIR ALL DAMAGED SURFACES SCHEDULED TO REMAIN.
- 15. REMOVE EXIST. EXTERIOR DOOR, EXTERIOR SCREEN DOOR, FRAME & TRIM COMPLETE. REMOVE PORTION OF EXTERIOR WALL TO ACCOMODATE NEW DOOR AS SCHEDULED. SEE SHEET A17 FOR SCHEDULE & DETAILS. (TYPICAL ALL EXTERIOR DOORS @ DAYCARE UNIT, D2 HANDICAP CONVERSION, AND D3 HANDICAP CONVERSION)
- 16. REMOVE EXIST. LEAD-BASED PAINT PER SPECIFICATION SECTION 02090 THEN REMOVE REMAINING BLOCK WALL.
- 17. REMOVE EXIST. PAINTED METAL ENCLOSURE AND COMPONENTS PER SPECIFICATION SECTION 02090. SEE MECHANICAL SHEET FOR FURTHER DEMOLITION.
- 18. REMOVE EXIST. PTD. METAL HEADER PER SPECIFICATION SECTION 02090.
  19. REMOVE CONTAMINATED SOIL TO A DEPTH OF 2" PER SPEC. SECTION 02080.
- 20. REMOVE CONTAMINATED BLOWN INSULATION PER SPEC. SECTION 02080.
  21. REMOVE EXISTING TERRACOTTA FLUE AND CEMENTITIOUS FILL IN ADDITION
- 1. REMOVE EXISTING TERRACOTTA FLUE AND CEMENTITIOUS FILL IN ADDITION TO OTHER WALL DEMOLITION. FILL RESULTING VOIDS W/ CONCRETE & REPAIR ALL DAMAGED SURFACES SCHEDULED TO REMAIN.
- 22. REMOVE EXISTING INTERIOR WOOD DOORS COMPLETE WITH HARDWARE & HM FRAMES PER SPECIFICATION SECTION 02090.
- 23. EXISTING MIRROR/MEDICINE CABINET TO REMAIN. REMOVE & REINSTALL AS REQUIRED.
- 24. REMOVE EXIST. LEAD—BASED PAINT FROM METAL PANEL ENCLOSURE PER SPECIFICATION SECTION 02090. EXIST. FACTORY—FINISHED FURNACE HOUSING SHALL REMAIN.
  - REMOVE EXIST. TOILET PARTITIONS COMPLETE. PATCH & REPAIR ALL
- DAMAGED SURFACES, SCHEDULED TO REMAIN.

  26. REMOVE EXIST. TLT. ACCESSORIES COMPLETE, INCLUDING TLT. TISSUE
  DISPENSERS, PAPER TOWEL DISPENSER, SANITARY NAPKIN DISPOSAL, MIRRORS
- SOAP DISPENSERS, ETC.

  27. REMOVE EXIST. WIRE FENCE PARTITION & SUPPORTS COMPLETE. PATCH &
- REPAIR ALL DAMAGED SURFACES SCHEDULED TO REMAIN.
- 28. REMOVE EXIST. 12"x12" CLG. TILES & SUPPORTS LOCATED ABOVE 2'x4' CLG. TILES PER SPECIFICATION SECTION 02080. (WORK INCLUDES ALL
- AREAS BOUNDED BY HEAVY DASHED LINES.)

  29. REMOVE EXIST. WINDOW, FRAME, SILL & COMPONENTS COMPLETE. PATCH
- & REPAIR ALL DAMAGED SURFACES SCHEDULED TO REMAIN.

  30. REMOVE EXIST. WALL PANELLING, FURRING & TRIM PER SPEC. SECTION
- NOTED. (ALL WALLS THIS SPACE.)
- 31. REMÓVE EXIST. MTL. DOOR, TRIM & HARDWARE PER SPEC. SECTION 02070. SALVAGE MTL. DOOR & HARDWARE REMOVE EXIST. DOOR FRAME PER SPEC. SECTION 02090.
- 32. 33. NOT SHOWN

  34. REMOVE EXISTING BATH ACCESSORIES, TO INCLUDE TOILET TISSUE DISPENSER
  TOWEL BAR TUMBLER/TOOTHBRUSH HOLDER, SOAP DISH AND SHOWER
- CURTAIN ROD AS REQUIRED PER SPECIFICATION SECTION 02070.

  35. REMOVE EXISTING CEILING AND FRAMING TO PROVIDE ATTIC ACCESS
- TO MATCH OPENING SIZE AND LOCATION OF ADJACENT UNIT PER SPECIFICATION SECTION 02090.
- 6. NOT SHOWN.
- 7. REMOVE EXISTING MIRROR/MEDICINE CABINET PER SPECIFICATION SECTION 02070.

NOTE: BUILDING TYPE D3 UNITS TO RECEIVE HANDICAPPED CONVERSION ARE AS FOLLOWS:

3300A 3300B 3302A 3302B 3400A 3400B 3402A 3402B

3501A 3501B

(FOR SITE LOCATION, & RELATED WORK, SEE CIVIL DWGS.)

### NEW WORK NOTES

- 1. PROVIDE NEW 1/2" GYPSUM WALLBOARD. SCREW & LAMINATE TO EXISTING PLASTER/CMU PARTITIONS, EXIST. FURRING, COLUMNS & BEAMS (TYPICAL ALL SPACES THROUGHOUT UNIT).
- 2. PROVIDE NEW 1-1/2" METAL FURRING CHANNELS & 1/2" GYPSUM WALLBOARD. (ENTIRE WALL)
- 3. PROVIDE NEW METAL STUD FRAMING WITH 1/2" GYPSUM WALLBOARD SOFFIT W/ REMOVABLE 1/2" PLYWOOOD FRONT PANEL.
- PROVIDE NEW RUBBER STAIR TREADS.
   PROVIDE NEW HOLLOW CORE WOOD DOORS. SEE DOOR SCHEDULE, SHEET A17. (TYPICAL ALL INTERIOR WOOD DOORS, PROVIDE HM FRAMES AS INDICATED ON DOOR SCHEDULE, DOOR TO BE CENTERED IN NEW PARTITION UNLESS OTHERWISE DIMENSIONED).
- 6. PROVIDE NEW 3-5/8" METAL STUD & 1/2" GYPSUM WALLBOARD PARTITION (FLOOR TO CEILING HEIGHT, WORK INCLUDES AREA ABOVE DOORS) FRAME FLUSH TO EXISTING PARTITIONS. STAGGER MTL. STUDS WHERE REQUIRED TO PROVIDE FLUSH TRANSITION INTO EXIST. WALL OR NEW MTL. FURRING. TYP. ALL LOCATIONS INDICATED UNLESS OTHERWISE NOTED.
  7. PROVIDE NEW 1 X 4 WOOD CHAIR RAIL. (MTG. HEIGHT-36" TO C OF RAIL) SEE DETAIL 5/A10.
- 8. PROVIDE 1/2" PLYWOOD AT UNDERSIDE OF STAIR OR LANDING (SECURE TO BOTTOM OF STRINGER OR SUPPORT CHANNELS).
- 9. PROVIDE NEW 1/4" PLYWOOD ACCESS PANEL & TRIM. PROVIDE NEW FRAMED OPENING @ BLDG. D2 HANDICAPPED CONVERSION ONLY.
- 10. PROVIDE NEW EXTERIOR METAL DOOR W/SCREEN IN NEW HOLLOW METAL FRAME. PROVIDE NEW BLOCKING AND FINISH WALL. SEE SHEET A17 FOR SCHEDULE & DETAILS. (TYPICAL ALL DOORS @ DAYCARE UNIT, D2 HANDICAP
- 11. PROVIDE NEW 7/8" METAL FURRING CHANNELS & 1/2" GWB. (ENTIRE WALL)
- 12. PROVIDE NEW NATURAL FINISH PLYWOOD AND SOLID WOOD CABINETS, NEW COUNTERTOPS AND FULL HEIGHT BACKSPLASH.
- 13. PROVIDE NEW WOOD SHELVING AND RODS. (2 SHELVES EA. @ STORAGE, 4 SHELVES EA. @ LINEN & PANTRY, 1 ROD & 2 SHELVES EA. @ BEDROOM & COAT CLOSETS, 2 RODS & 2 SHELVES EA. @ STAIR CLOSETS, 1 ROD & 1 SHELF EA. @ BATH. FOR DETAILS, SEE SHEET A19).
- 14. PROVIDE NEW 4" WOOD BASE. (TYPICAL ALL PARTITIONS) SEE 8/610.

  15. PROVIDE NEW 6" METAL STUD PARTITION WITH 1/2"
- GYPSUM WALLBOARD.

  16. PROVIDE NEW HOLLOW METAL DOOR FRAMES.

CONVERSION & D3 HANDICAP CONVERSION)

- 17. PROVIDE NEW 1/2" GYPSUM WALLBOARD CEILING, SLOPE TO MATCH STAIR—SEE SECTION 1/A13.
- 18. PROVIDE NEW METAL STUD FRAMING WITH 1/2" GYPSUM WALLBOARD SOFFITS

  19. PROVIDE NEW 1-1/2" O'WOOD HANDRAIL SUPPORTED BY NEW METAL
  BRACKETS & SECURED TO EXISTING PARTITION. (CLEAR STAIN FINISH,
  SEE DETAILS 6 & 7/A19.)
- 20. PROVIDE NEW WOOD CAP. (CLEAR STAIN FINISH) SEE DETAIL 6/A10.
  21. PROVIDE NEW 12" X 12" VINYL COMPOSITION FLOOR TILE THROUGHOUT UNIT ALL SPACES. (UNLESS OTHERWISE NOTED.)
- 22. PROVIDE NEW 1/2" GYPSUM WALLBOARD FASTENED TO EXISTING METAL FRAMED DUCT ENCLOSURE.
  - PROVIDE NEW 2-1/2" METAL STUDS & 1/2" GYPSUM WALLBOARD PARTITION (FLOOR TO CEILING HEIGHT, WORK INCLUDES AREA ABOVE DOORS) FRAME FLUSH TO EXISTING PARTITIONS. TYPICAL ALL LOCATIONS INDICATED.
- 24. PATCH HOLES RESULTING FROM MECHANICAL DEMOLITION PER SPEC. SECTION 07242A (SEE MECHANICAL DRAWINGS).
- 25. PROVIDE NEW 1 X 6 WD TRIM AT AREA BETWEEN WINDOWS. (SHAPE TO MATCH EXISTING.)
- 26. PATCH EXIST. OPENING RESULTING FROM MECHANICAL DEMOLITION IN SECOND FLOOR SLAB WITH CONCRETE. (SEE MECHANICAL DRAWINGS)
- 27. PROVIDE 2 1/2" METAL STUD CEILING FRAMING WITH 1/2" GWB THIS SIDE OF BEAM ONLY IN HALLWAY. BOTTOM OF DROP CLG. TO BE 3/4" HIGHER THAN BOTTOM OF EXIST. BEAM. COORDINATE LOCATION OF FRAMING
- WITH MECHANICAL DUCT. (SEE SHEET M-6.)

  28. PROVIDE NEW HOLLOW CORE FLUSH WOOD BI-FOLD DOOR, TYPE E AS SHOWN ON SHEET A17. PROVIDE HARDWARE PER SPECIFICATION SECTION
- 08700. INSTALL DOOR VIA FLOOR & CEILING CONNECTIONS ONLY.

  29. PROVIDE REQUIRED BLOCKING & SUPPORT FOR WALL-MOUNTED EQUIPMENT
- (COORDINATE WITH MECHANICAL/ELECTRICAL DRAWINGS).

  30. PROVIDE NEW EXTERIOR FINISH SYSTEM AS NOTED.
- 31. PROVIDE NEW WOOD TRIM (1x REQ'D. WIDTH) AT ALL WINDOW LOCATIONS.
  32. PROVIDE NEW FINISH AT STAGE FLOOR (SEE SPECIFICATION SECTION 09900).
- 33. REPAIR CONCRETE SLAB RESULTING FROM PLUMBING DEMOLITION. PROVIDE CEMENTITIOUS LEVELING MATERIAL OVER ENTIRE ROOM.
  34. 36. NOT. SHOWN.
- 37. PROVIDE NEW BATH ACCESSORIES, TO INCLUDE TOILET TISSUE DISPENSER, TOWEL BAR, TUMBLER/TOOTHBRUSH HOLDER, SOAP DISH AND SHOWER CURTAIN ROD, PER SPECIFICATION SECTION 10800. SEE BATH PARTIAL PLANS, SHEET A10.
- 38. PROVIDE NEW ATTIC ACCESS TO MATCH ACCESS IN ADJACENT UNIT. NEW WORK TO INCLUDE FRAMED OPENING, 1/4" PLYWOOD ACCESS PANEL AND
- TRIM.

  39. 42. NOT SHOWN.
- 42. NOT SHOWN.

### GENERAL NOTES

- 1. THE GENERAL CONTRACTOR SHALL VERIFY ALL FIELD CONDITIONS & DIMENSIONS PRIOR TO CONSTRUCTION & SHALL COORDINATE THE WORK OF ALL TRADES. ALL DISCREPANCIES SHALL BE BROUGHT TO THE IMMEDIATE ATTENTION OF THE ARCHITECT PRIOR TO STARTING CONSTRUCTION.

  2. ALL PARTITIONS SHOWN THUS (\*\*\*) INDICATE NEW PARTITIONS
- 2. ALL PARTITIONS SHOWN THUS ( ) INDICATE NEW PARTITIONS

  3. FOR CONSTRUCTION NOTES APPLICABLE TO THIS UNIT, REFER TO OPPOSITE HAND UNIT THIS PLAN, UNLESS OTHERWISE NOTED (I.E. EXISTING

PARTITION DEMOLITION). ALL DETAIL/SECTION SYMBOLS APPLY TO BOTH UNITS

- 4. WORK NOTES INDICATED ARE MASTER NOTE LISTS. SOME NOTES MAY NOT BE APPLICABLE TO THE CORRESPONDING SHEETS ON WHICH THEY APPEAR 5. FOR DWELLING UNIT DOOR SCHEDULE & DETAILS, REFER TO SHEETS
- A17 & A18.

  6. FOR DWELLING UNIT CASEWORK ELEVATIONS & DETAILS, REFER TO SHEET A19.
- 9. ALL DIMENSIONS ARE TO FACE OF STUD UNLESS OTHERWISE NOTED.
- 10. PATCH & CLEAN ALL CEILING SURFACES PRIOR TO PAINTING (QUANTITY-APPROXIMATELY SIX (6) 1" & X 2" DEEP PENETRATIONS PER UNIT).
- 11. CONTRACTOR SHALL PROVIDE 1/2" GWB AT ALL EXPOSED SURFACES OF
- BEAMS & COLUMNS. TYP. THROUGHOUT ALL UNITS.

  12. PAINT NEW & EXIST. INTERIOR SURFACES WITHIN THE ENTIRE UNIT.
  SURFACES TO BE PAINTED INCLUDE BUT ARE NOT LIMITED TO WALLS,
  CEILINGS, ACCESS PANELS, TRIM, METAL PANEL ENCLOSURES, FURNACE
  HOUSING, DUCT WORK, BEAMS, COLUMNS, DOORS & FRAMES, WOOD TRIM,
  HANDRAILS, RODS, SHELVES, & SUPPORTS (TYP. THROUGHOUT ALL UNITS).
- 13. FOR BATH PARTIAL PLANS & DETAILS, SEE SHEET A10.
- 14. FOR BID ALTERNATE WORK, SEE SHEETS A29 THRU A31.

PARTITIONS.

- 15. IN ADDITION TO THE WORK INDICATED ON THIS PLAN, THE CONTRACTOR SHALL PERFORM ALL WORK SHOWN ON THE CORRESPONDING DEMOLITION PLAN LOCATED ON THE SHEET REFERENCED THUS ( GN#15) A1
- 16. ALL PARTITIONS SHOWN THUS ( ) INDICATE NEW 2X4 WOOD




RENOVATION
OF
VA 3-2

COMPREHENSIVE

NEWPORT NEWS, VA

MARSHALL

COURTS

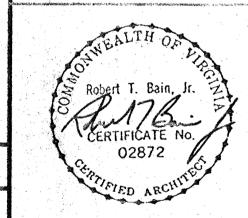

Designed: CET

Drawn: TFN / RSJ

Checked: CMH
Scale: AS NOTED


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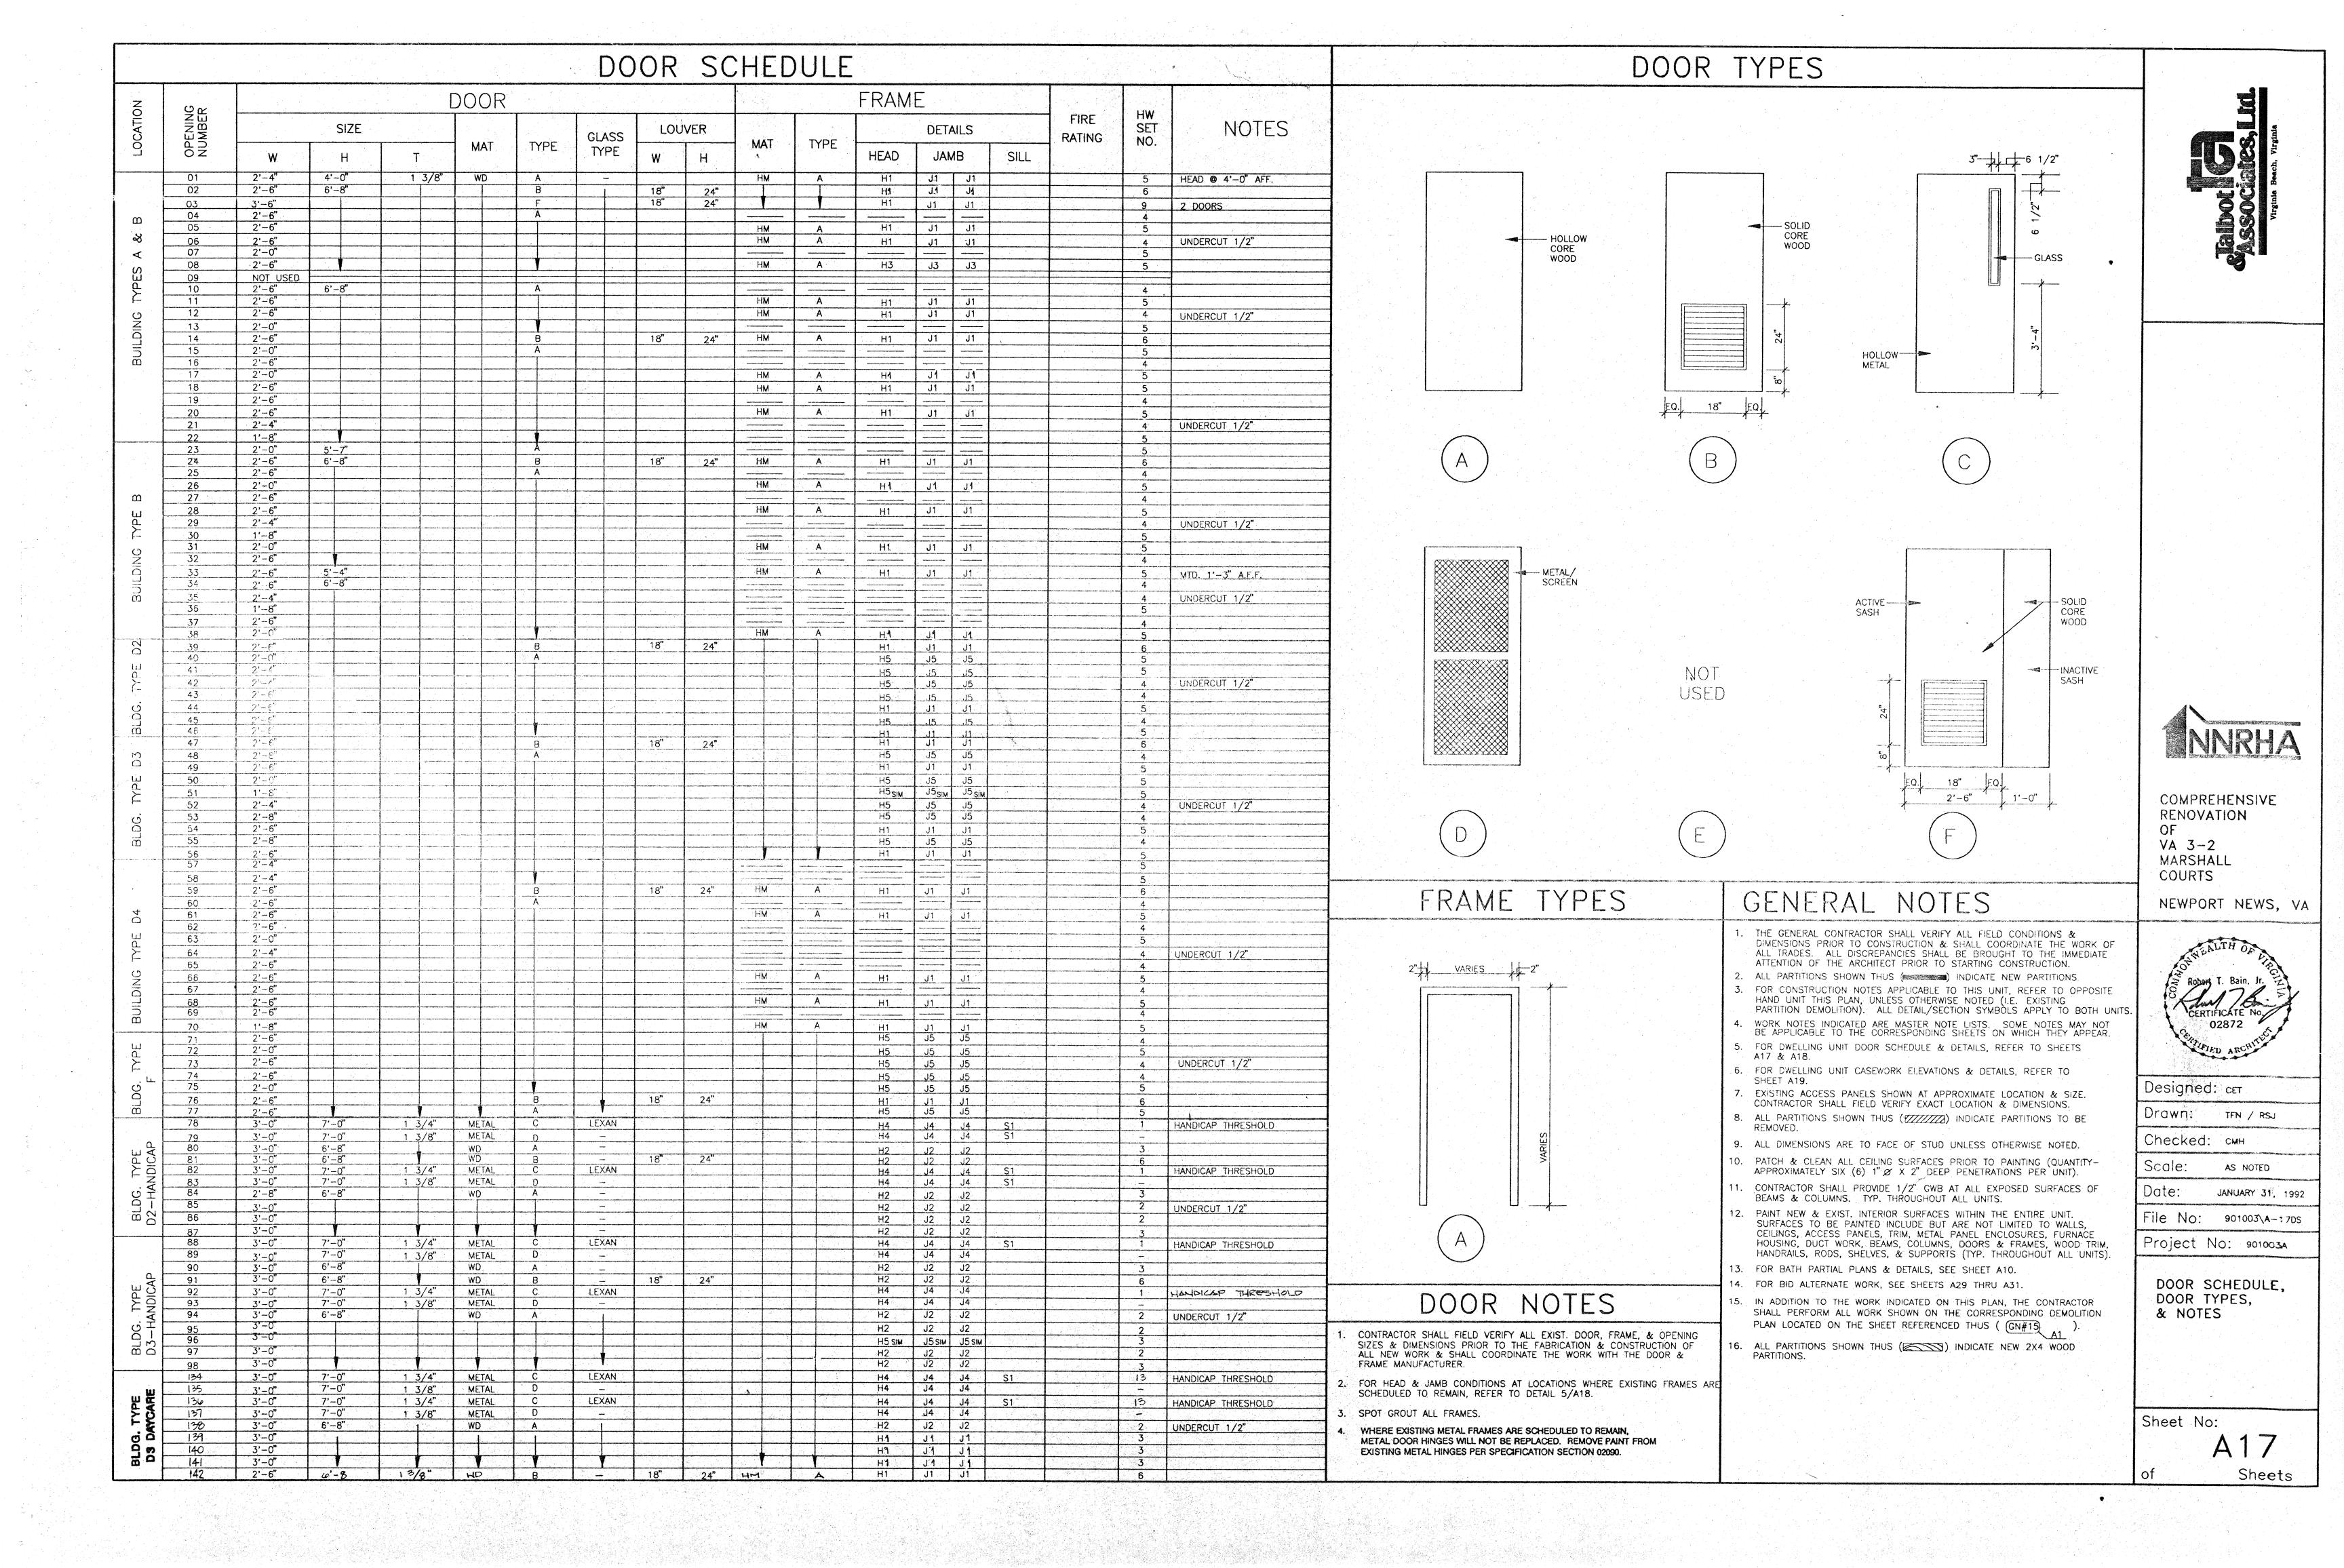
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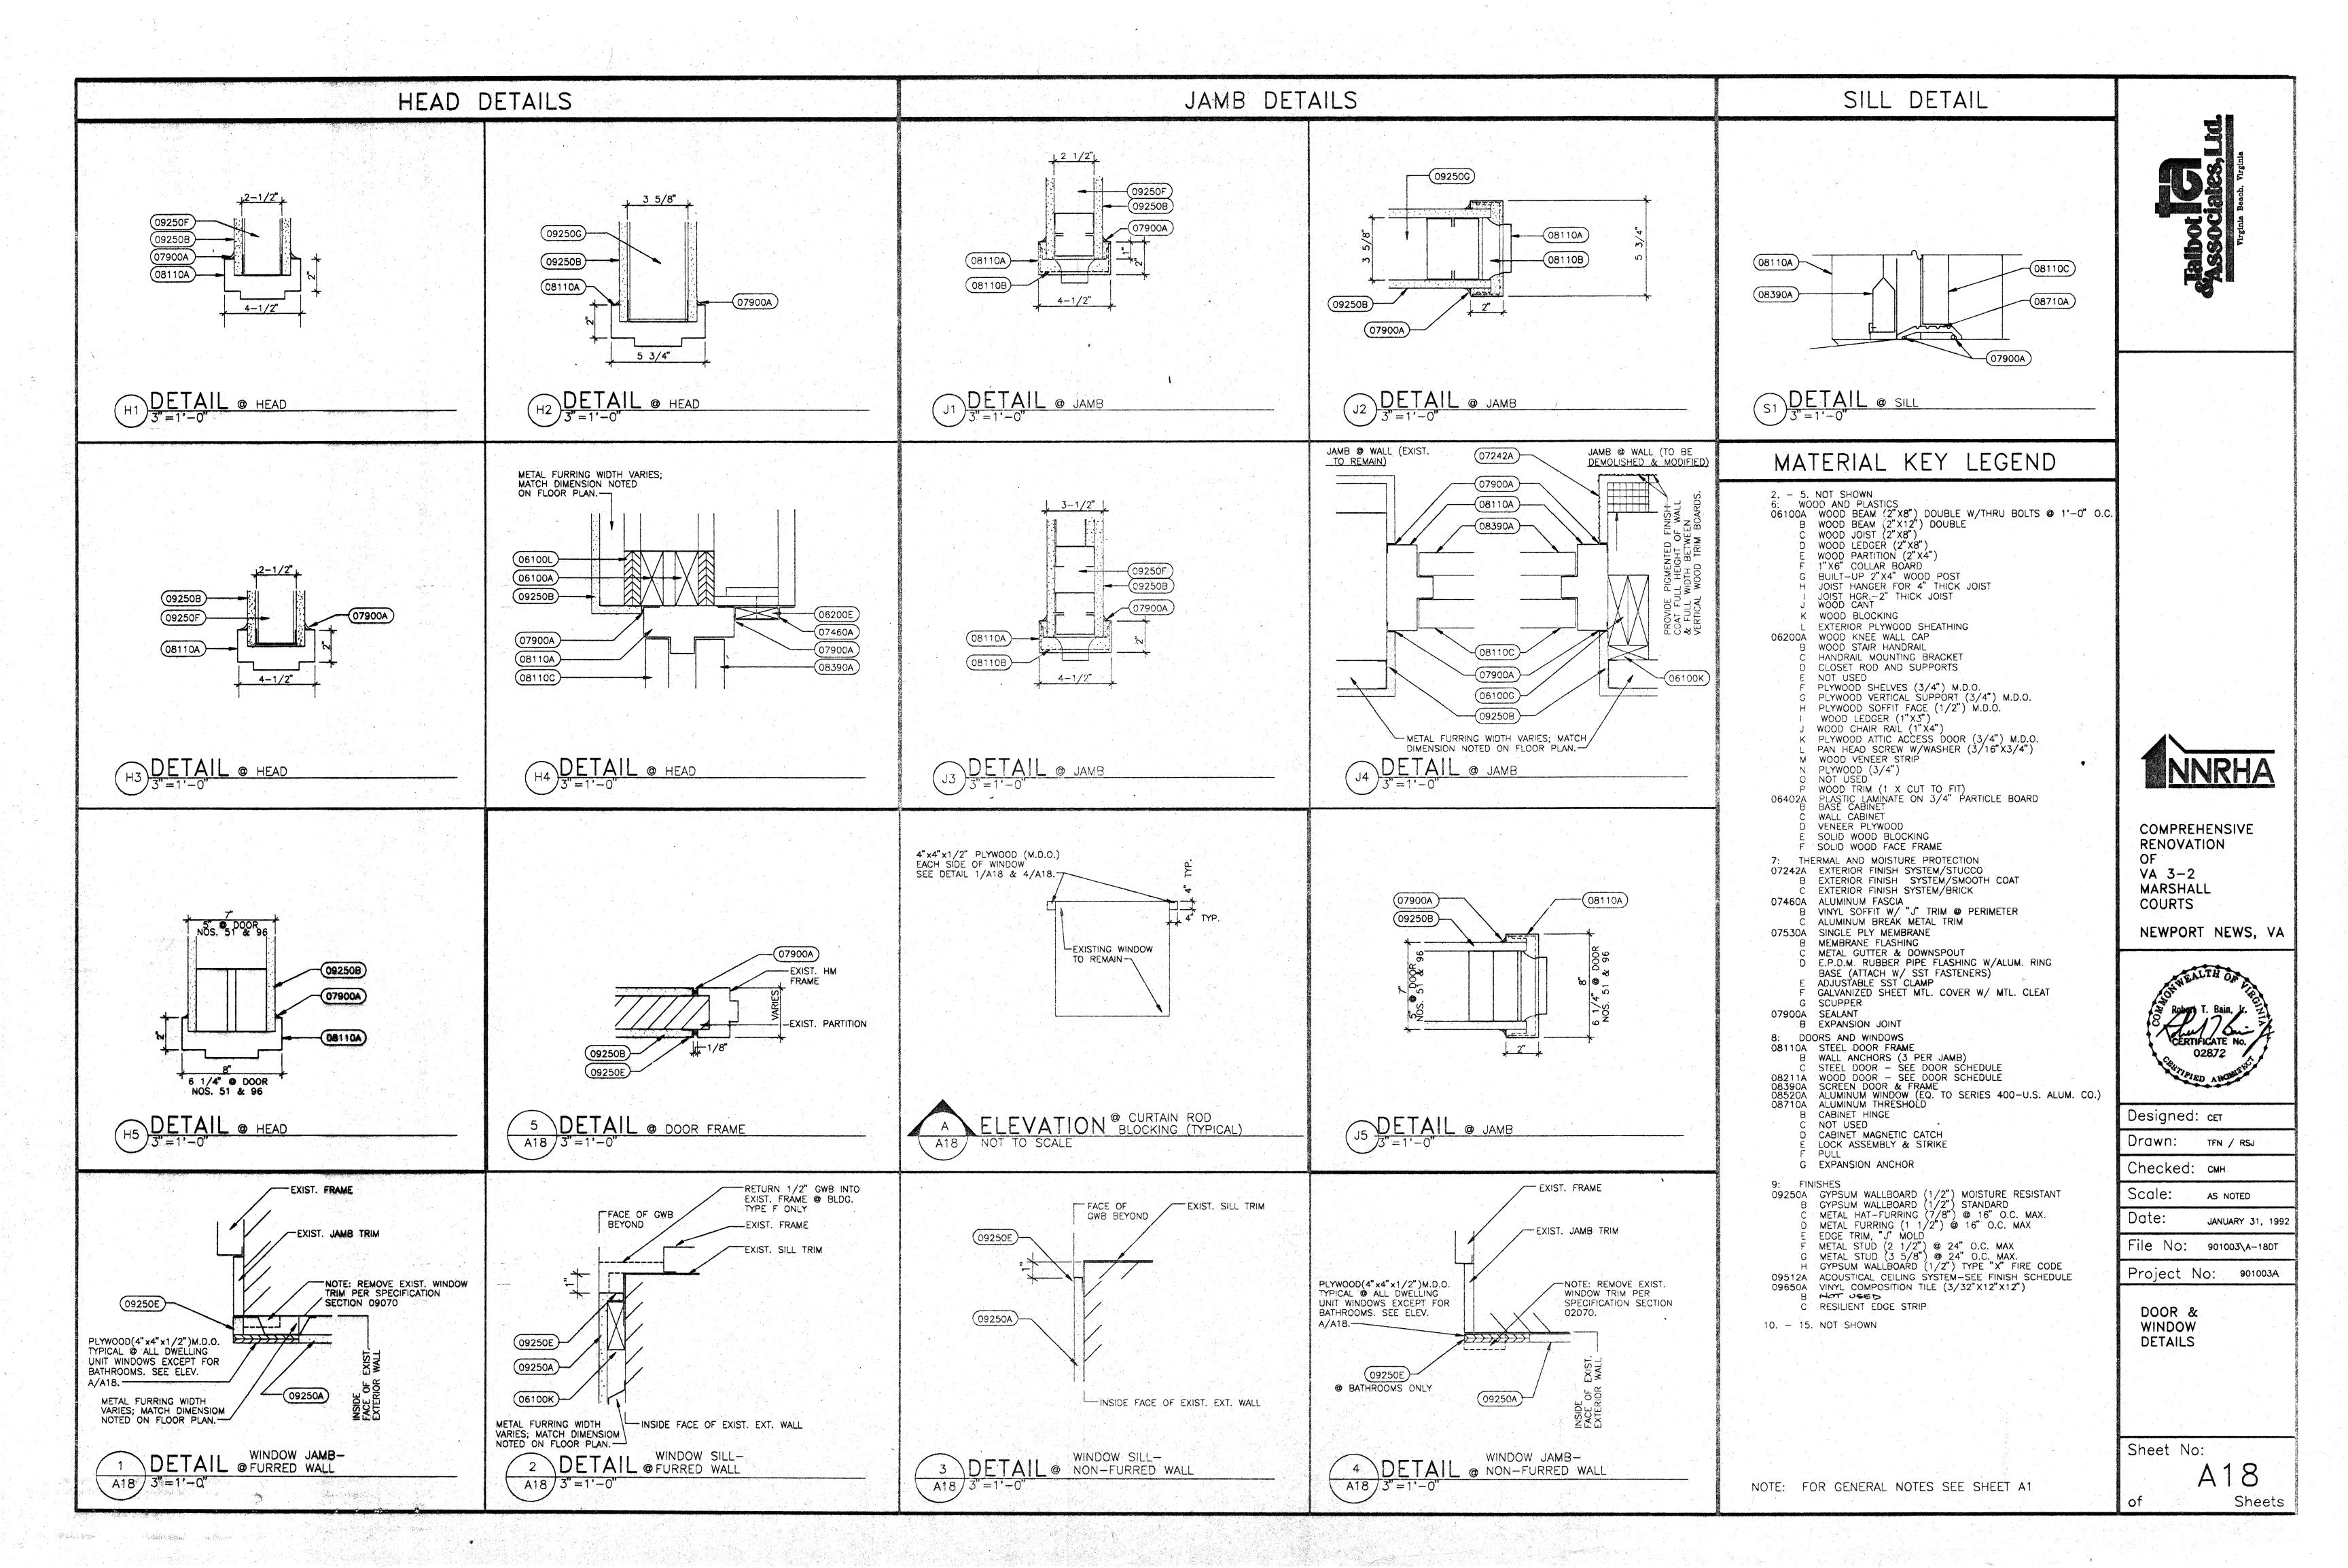
BUILDING
TYPE D3 FLOOR PLANS
(DEMOLITION &
NEW WORK /
HANDICAPPED
CONVERSION)


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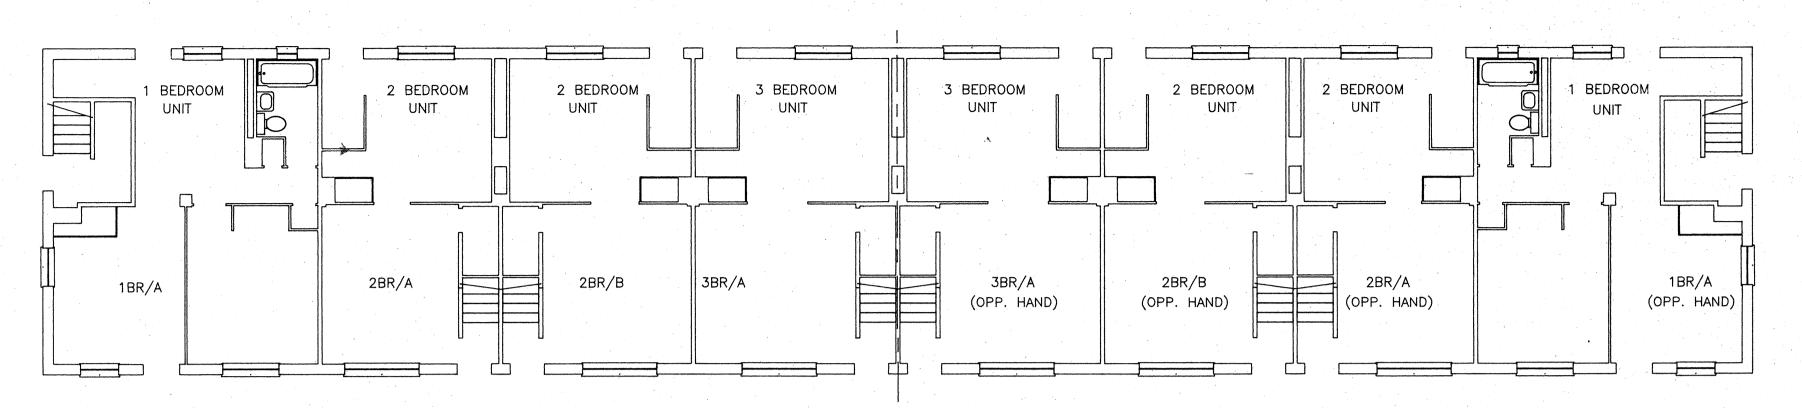
A15








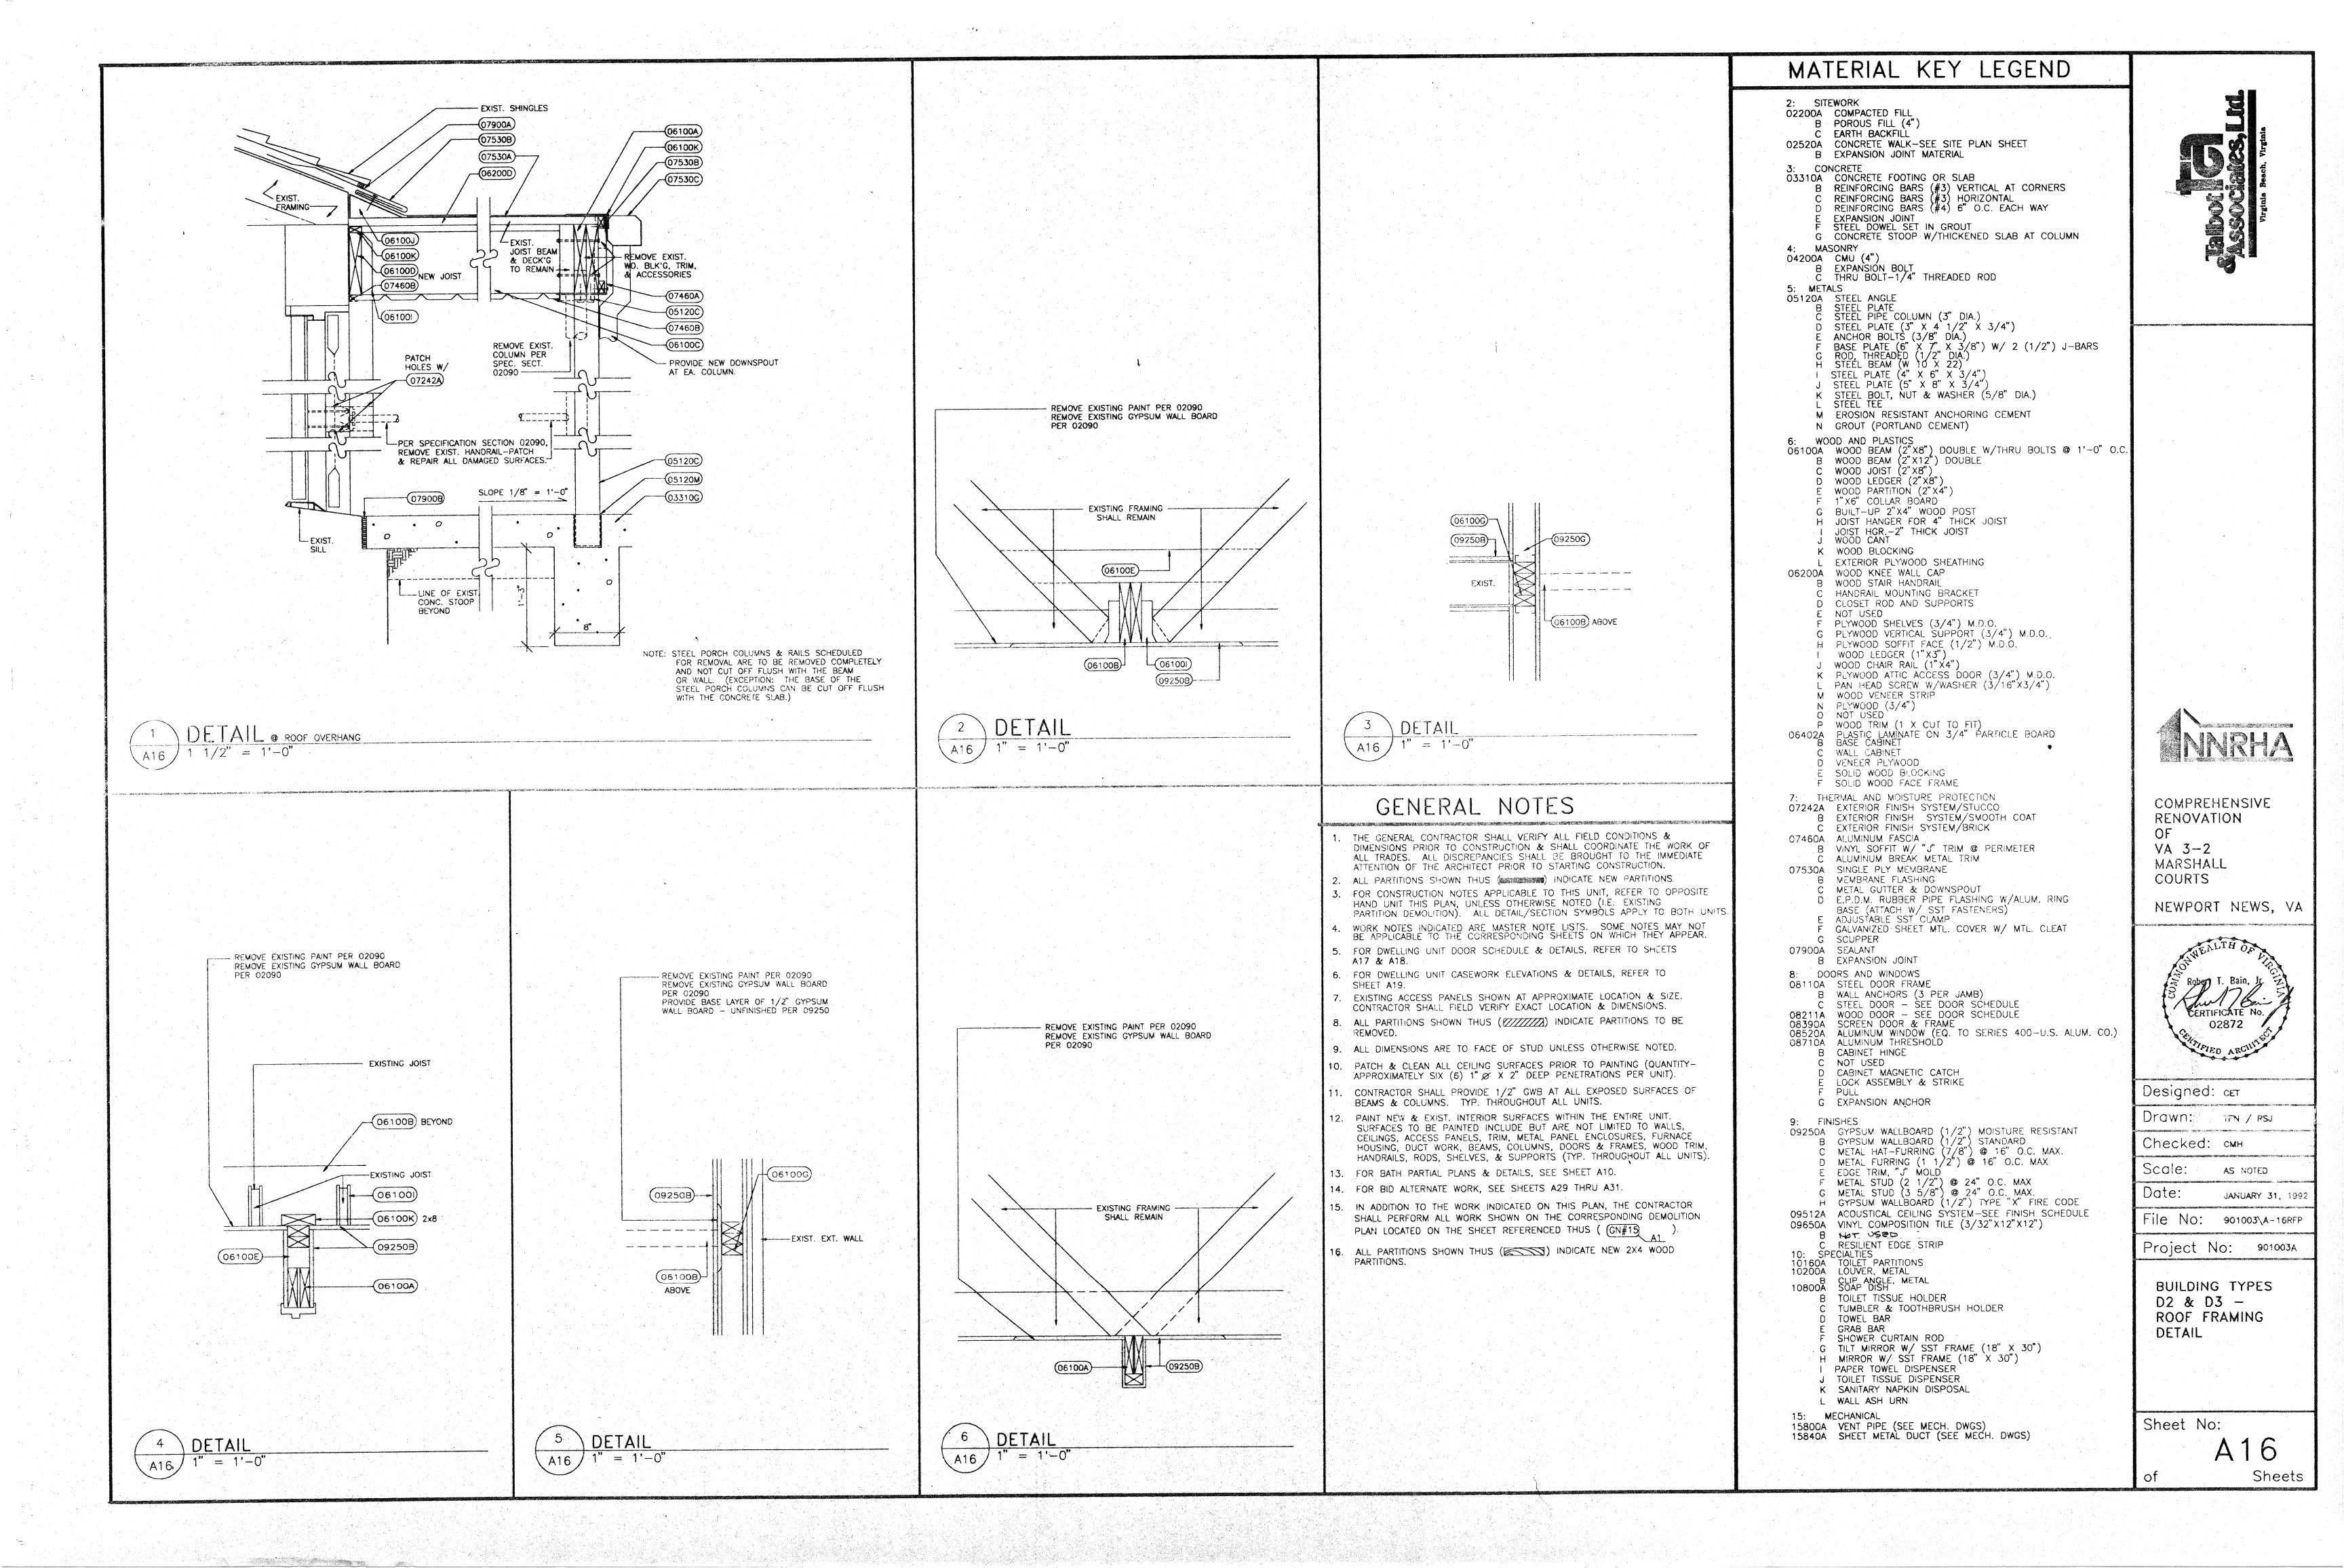

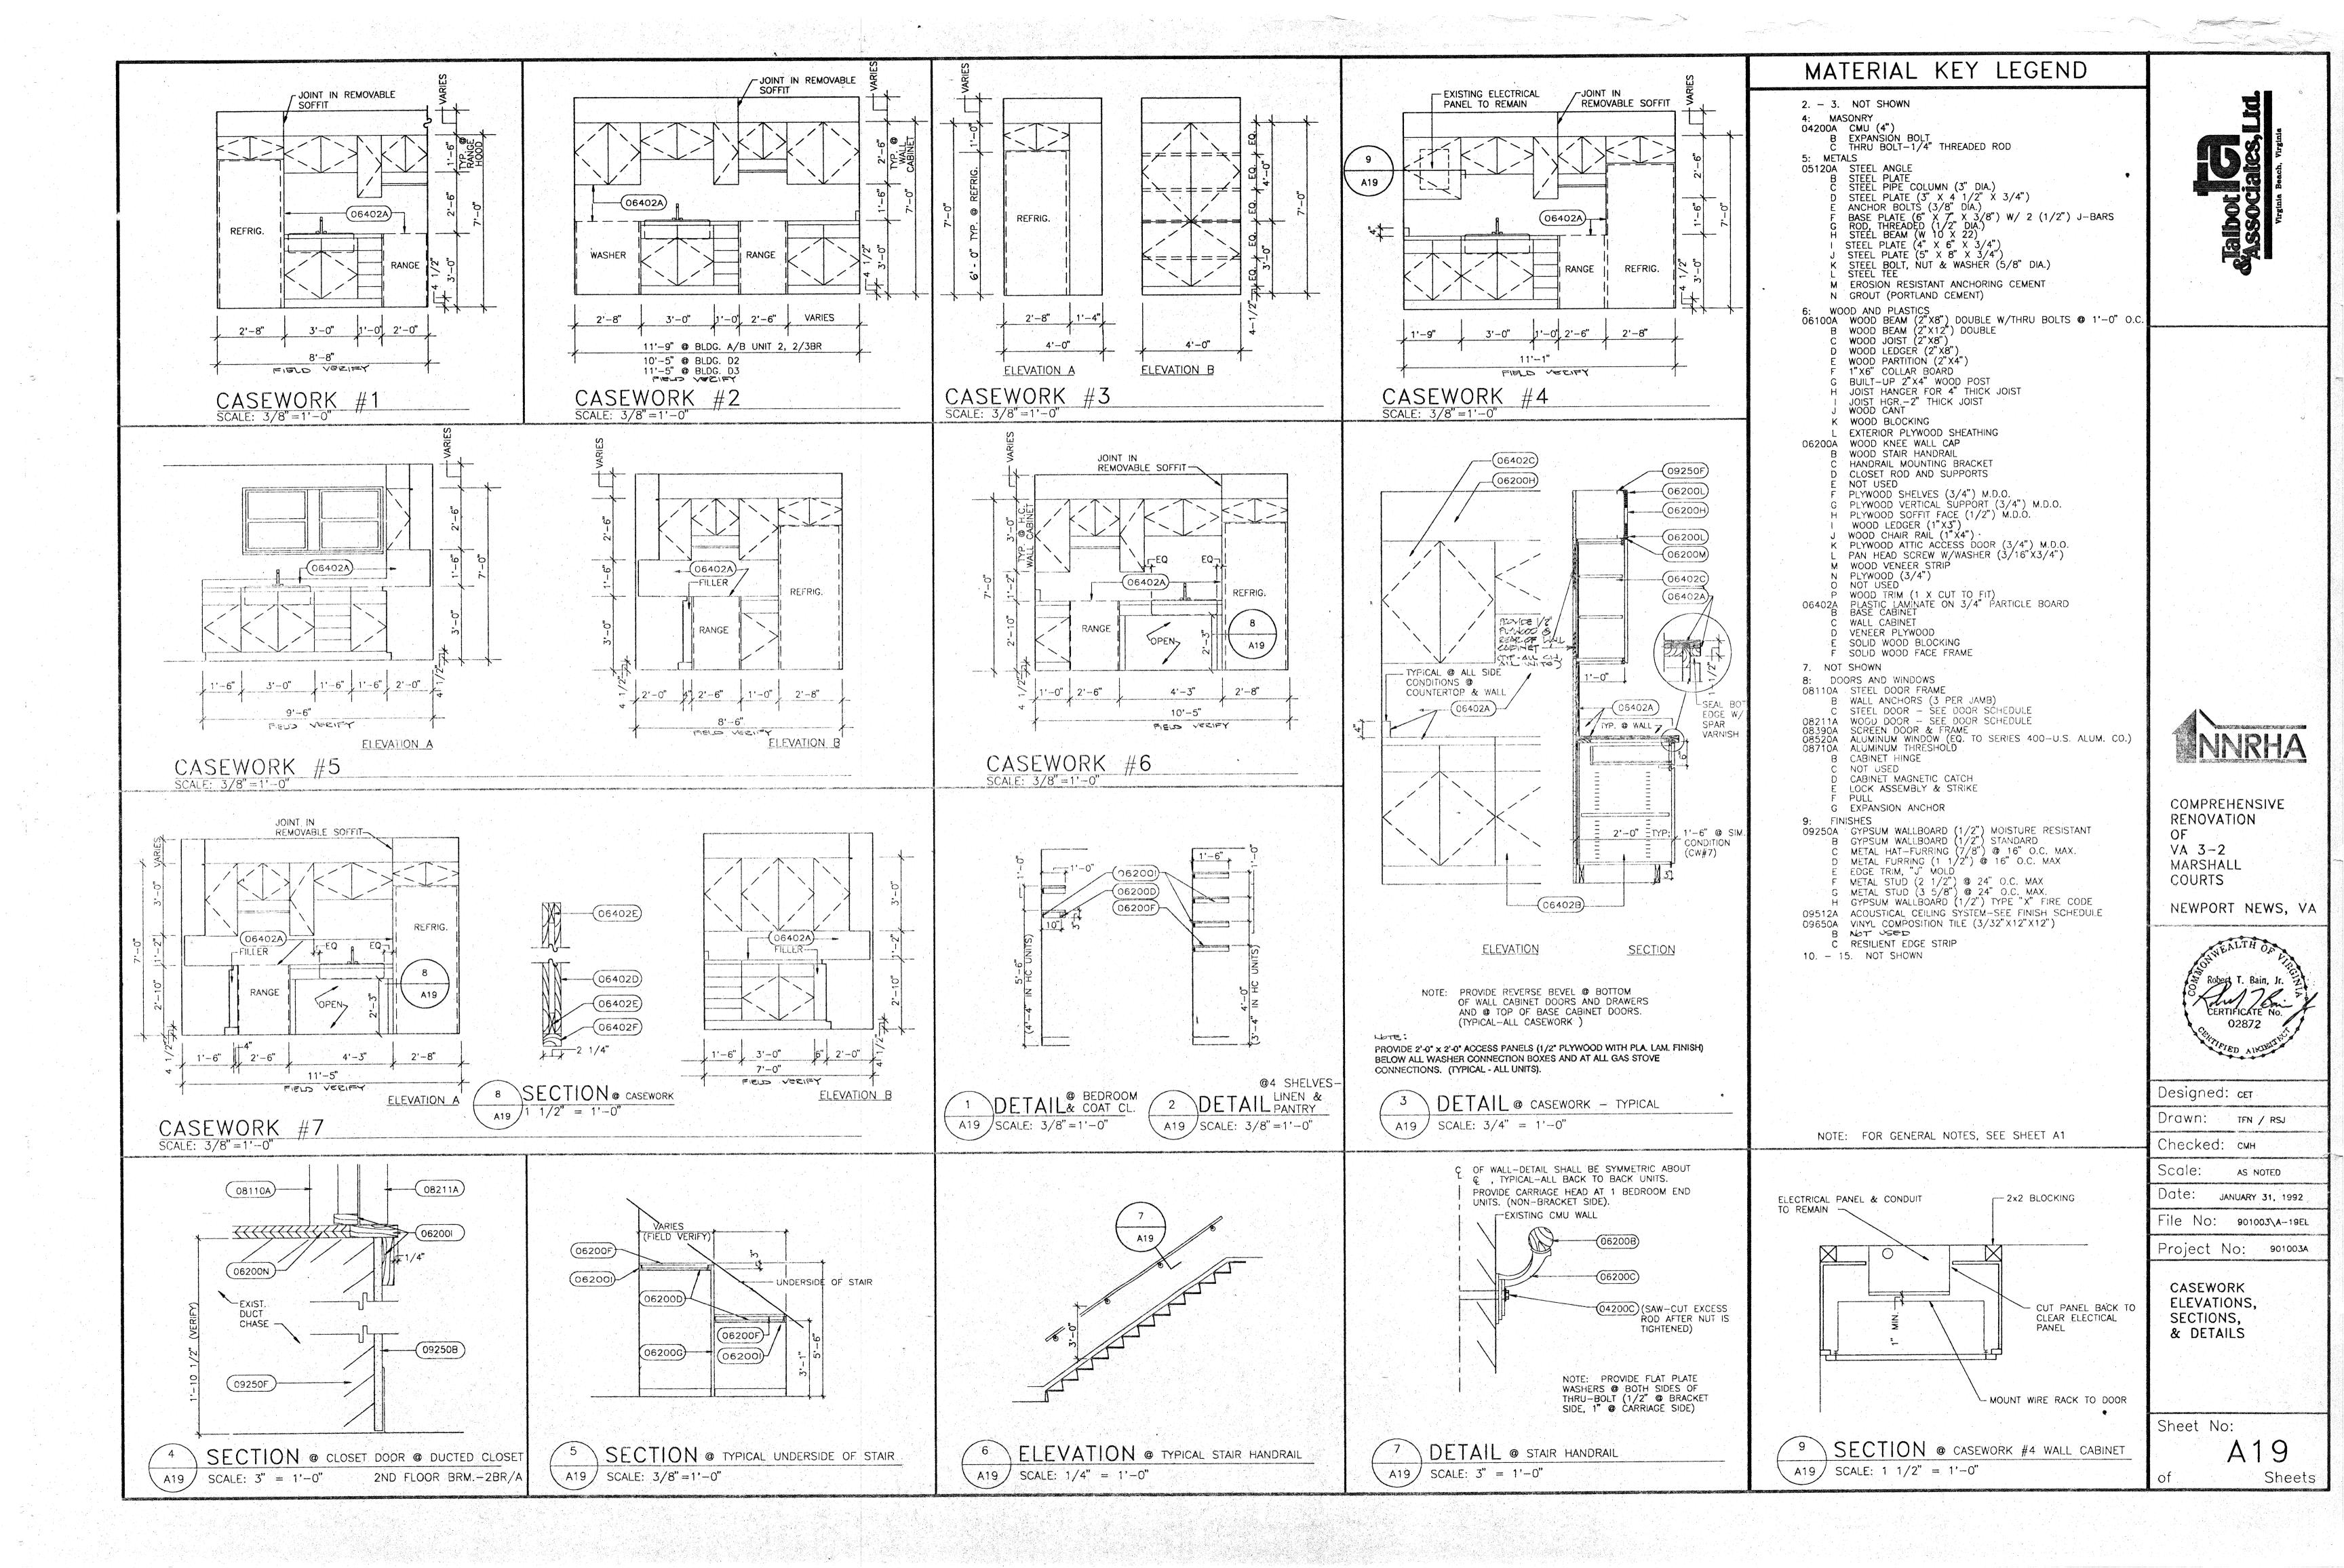


### FIRST FLOOR PLAN - BUILDING "B"

SCALE: 1/8" = 1'-0"

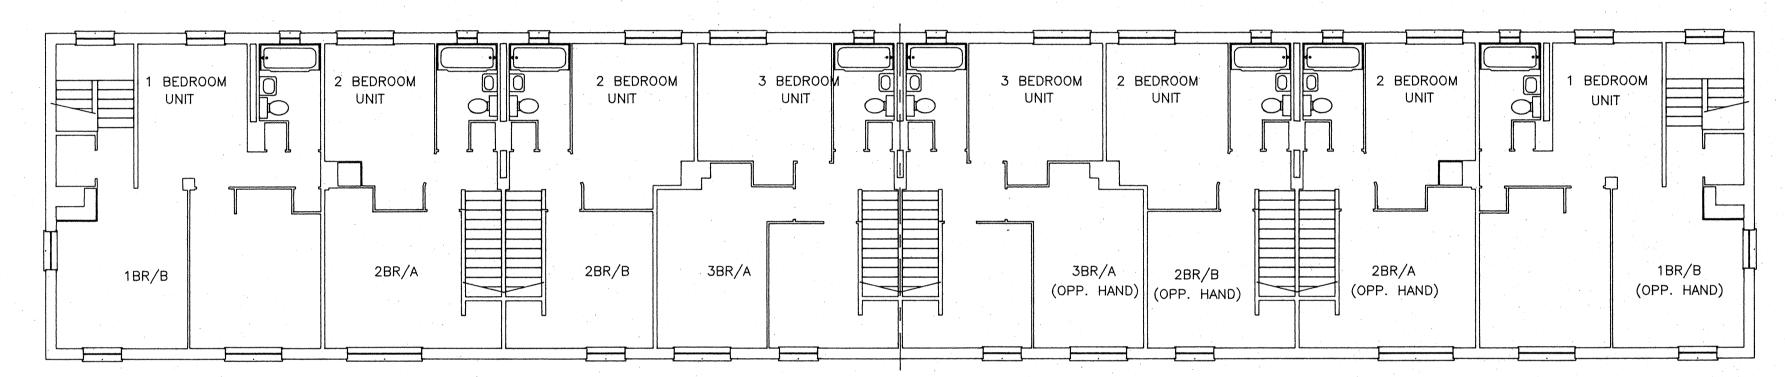


# SECOND FLOOR PLAN - BUILDING "B"

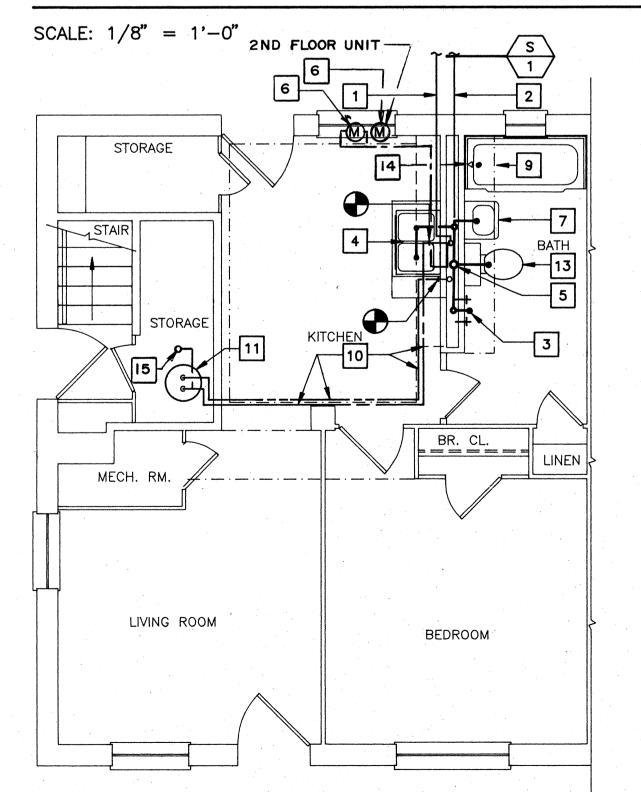


1ST FL. - UNIT 1BR/A

SCALE: 1/4" = 1'-0"

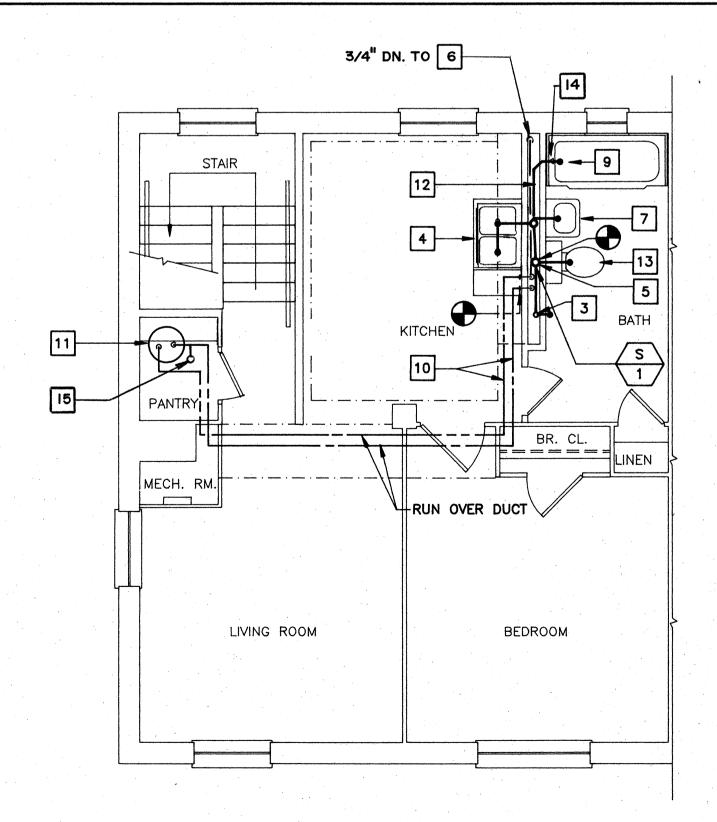

2ND FL. - UNIT 1BR/B

SCALE: 1/4" = 1'-0"

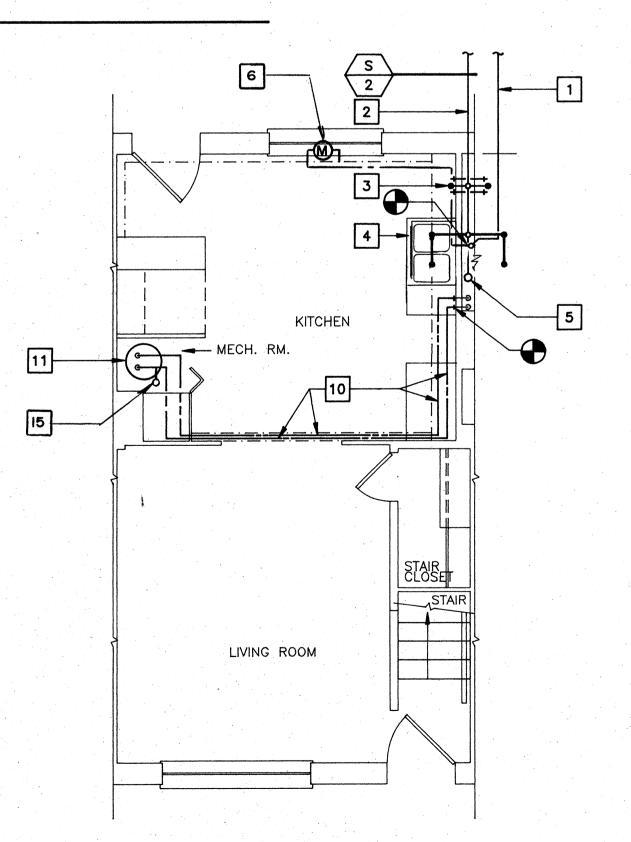

1ST FL. - UNIT 2BR/A

SCALE: 1/4" = 1'-0"

### ☐ NEW WORK NOTES

- 1. EXISTING COLD WATER SERVICE.
- 2. EXISTING UNDERGROUND SANITARY SEWER.
- PROVIDE RECESSED WASHER CONNECTION BOX. CONNECT 2" DRAIN ROUGH IN TO EXISTING PIPING IN CHASE. CONNECT HOT AND COLD WATER PIPING TO EXISTING PIPING IN CHASE. SEE WASTE RISER DIAGRAM, SHEET P6.
- RE-INSTALL EXISTING 2-COMPARTMENT KITCHEN SINK TO NEW COUNTERTOP WITH NEW SCREW AND CLIPS. PROVIDE NEW P-TRAP, ANGLE SUPPLIES DRAIN ROUGH-IN AND MAKE ALL FINAL CONNECTIONS TO WATER AND DRAIN CONNECTIONS IN CHASE. SEE WASTE RISER DIAGRAM, SHEET P6.
- 5. EXISTING 3" WASTE STACK.
- 6. PROVIDE 3/4" METER IN ACCESS PANEL. SEE ARCHITECTURAL DRAWINGS FOR LOCATION. SEE WATER RISER DIAGRAM SHEET P-10. EXTEND PIPING FROM METER TO EXISTING PIPING AS INDICATED.
- RE-INSTALL EXISTING WALL-HUNG LAVATORY AND HANGER BRACKET. PROVIDE P-TRAP, ANGLE SUPPLIES, DRAIN ROUGH-IN, AND MAKE FINAL CONNECTION TO EXISTING WASTE AND DRAIN CONNECTIONS IN CHASE. SEE WASTE RISER DIAGRAM, SHEET P6.
- 8. NOT USED.
- 9. EXISTING BATH TUB.
- 10. PROVIDE NEW 3/4" HOT WATER AND COLD WATER PIPING FROM WATER HEATER TO POINTS INDICATED. RUN PIPING IN NEW SOFFIT SPACE.
- 11. PROVIDE VALVES AND FINAL CONNECTIONS TO WATER HEATER/HEATING UNIT AS INDICATED ON MECHANICAL DRAWINGS.
- 12. PROVIDE ROUGH-IN PIPING AND CONNECT TO EXISTING TUB WASTE AND EXTEND PIPING AS INDICATED. SEE WASTE RISER DIAGRAM, SHEET P6.
- 13. RE-INSTALL WATER CLOSET AT COMPLETION OF NEW FLOOR FINISH WORK. PROVIDE WAX RING AND RE-SET TO EXISTING CLOSET FLANGE AND WATER SUPPLY.
- 14. PROVIDE TUB/SHOWER VALVE, FILL SPOUT, SHOWER ARM AND SHOWER HEAD. CONNECT TO EXISTING WATER ROUGH—IN. SEE FIXTURE CONNECTION SCHEDULE (P-11).
- 15. PROVIDE 1/2" UPRIGHT SPRINKLER HEAD, 3/4" CHECK VALVE AND 3/4" PIPING FROM SPRINKLER HEAD TO EXISTING COLD WATER PIPING. INSTALL IN ACCORDANCE WITH NFPA 13.

### NOTES THIS SHEET

1. FOR LEGEND, SEE SHEET P4.

BEDROOM

BEDROOM


2ND FL. - UNIT 2BR/A

- 2. FOR GENERAL NOTES, SEE SHEET P4.
- 3. FOR FIXTURE CONNECTION SCHEDULE, SEE SHEET P6.
- 4. FOR WATER HEATER/HEATING UNIT DETAIL, SEE SHEET M19.
- 5. FOR WASTE RISER DIAGRAM AND WATER RISER DIAGRAMS, SEE SHEET P6.



COMPREHENSIVE RENOVATION VA 3-2 MARSHALL COURTS

NEWPORT NEWS, VA

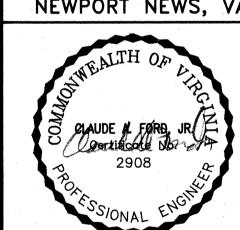

T.L.M. Designed Drawn: C.A.F. Checked: AS NOTED Scale:

Date: JANUARY 31, 1992

File No:


Project No: 90006

BUILDING TYPE B — FLOOR PLANS (NEW WORK)


Sheet No

P5 Sheets

SCALE: 1/4" = 1'-0"

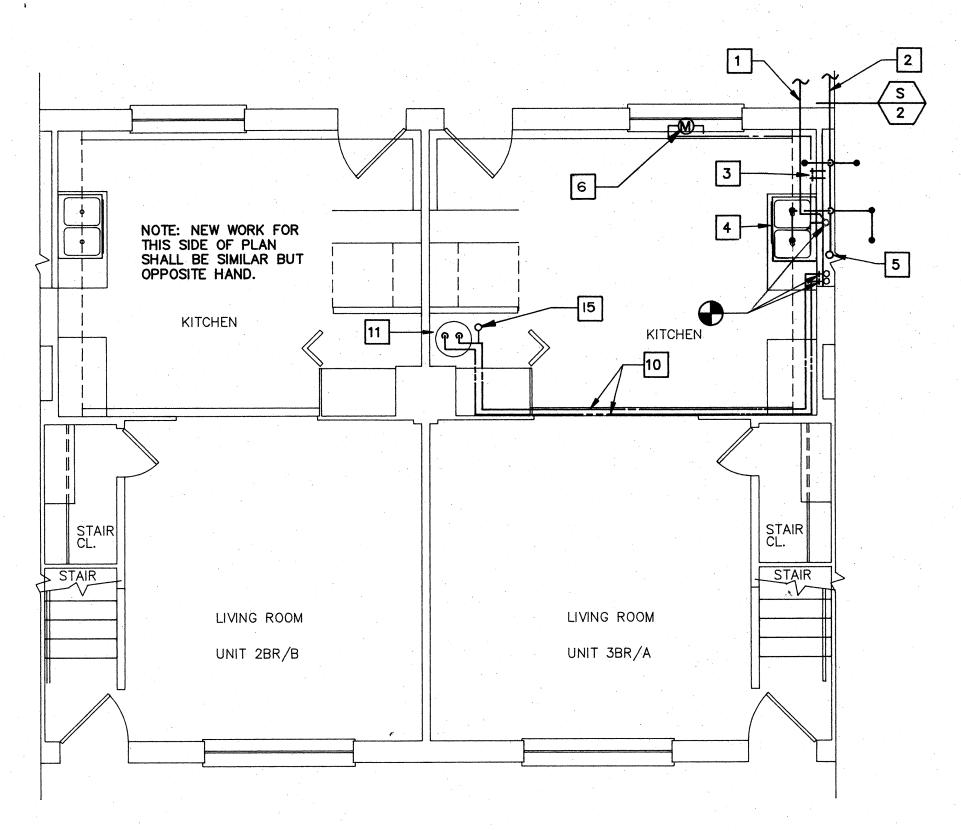

1ST FL. - UNIT 2BR/B & 3BR/A SCALE: 1/4" = 1'-0"

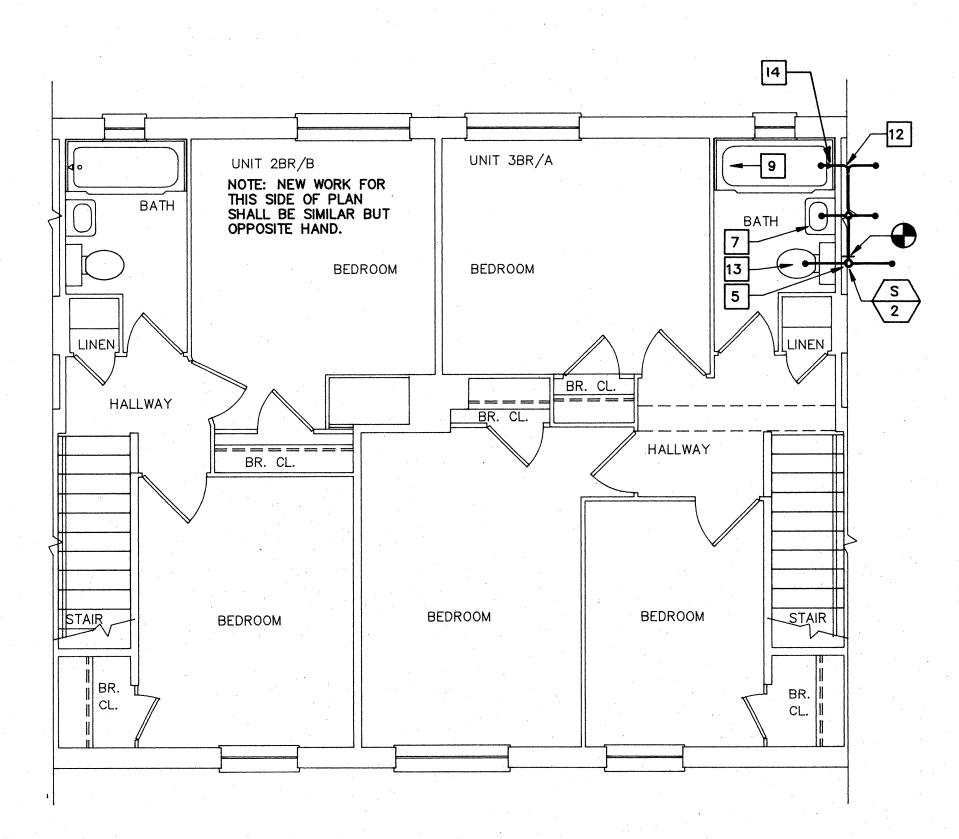

2ND FL. - UNIT 2BR/B & 3BR/A SCALE: 1/4" = 1'-0"

	PLUMBING FIXTURE CONNECTION SCHEDULE					
	MARK	FIXTURE	H.W.	C.W.	W	REMARKS
Ī	P-1	WATER CLOSET-18" HIGH SEE NOTE 3 BELOW		1/2"	4"	MANSFIELD 118-35; BENEKE 523 SEAT; BRIDGEPORT 2032 SUPPLY
	P-2	LAVATORY-WALL MOUNTED SEE NOTE 3 BELOW	1/2"	1/2"	1 1/2"	SUPPLY MANSFIELD 1917C; DELTA 520 TPM FAUCET; BRIDGEPORT 2032 SUPPLIES; AND 59 P-TRAP
	P-3	BATHTUB - 5'-0"	1/2"	1/2"	1 1/2"	MANSFIELD T-500; SWAN UB-58 TUBWALL DELTA 1693 SHOWER VALVE AND HANDSET
	P-4	WASHER CONNECTION BOX	1/2"	1/2"	2"	CP INDUSTRIES 4312-P SEE NOTE 5 BELOW
	P-5	WATER CLOSET-14" HIGH	######################################	1/2"	4"	MANSFIELD 128-8; BENEKE 523 SEAT; BRIDGEPORT 2032 SUPPLY
	P-6	URINAL	-	3/4"	2"	MANSFIELD 403; SLOAN 186 FLUSH VALVE
	P-7	LAVATORY-COUNTER MOUNTED	1/2"	1/2"	1 1/2"	MANSFIELD OL-2017-SR; DELTA 523 HDF FAUCET; BRIDGEPORT 2032 SUPPLIES AND 59 P-TRAP
	P-8	LAVATORY-COUNTER MOUNTED	1/2"	1/2"	1 1/2"	SAME AS P-7; SEE NOTE 3 BELOW
	P-9	MOP RECEPTOR	3/4"	3/4"	3"	FIAT MSB-2424; FIAT 830AA FAUCET
	P-10	WATER COOLER		1/2"	1 1/2"	OASIS OCP3M IN STANDARD FINISH; SEE NOTE 3 BELOW
	P-11	SHOWER VALVE	1/2"	1/2"		DELTA 641 VALVE, DIVERTER TUB SPOUT, SHOWER ARM & SHOWER HEAD
				*		
•			,			

- 1. COLOR OF FIXTURES TO BE WHITE UNLESS OTHERWISE NOTED.
- 2. SUPPLIES AND TRAPS SHALL BE CHROMIUM PLATED. LAVATORY TAILPIECE SHALL BE 16 GA. BRASS.
- 3. INSTALL FIXTURE IN ACCORDANCE WITH ANSI A117 HANDICAP ACCESSIBILITY REQUIREMENTS
- 4. BATHTUB IN D2 UNITS SHALL BE OUTFITTED WITH SWAN WTK-1 FIBERGLASS WINDOW TRIM KIT. SEE SHEET P-11.
- 5. PROVIDE 2" SANITARY TEE, CLEANOUT PLUG AND FLUSH STAINLESS STEEL COVER PLATE IN DRAIN PIPING BELOW SANITARY TEE CONNECTING WASHER CONNECTION BOX.

### ☐ NEW WORK NOTES


- 1. EXISTING COLD WATER SERVICE.
- 2. EXISTING UNDERGROUND SANITARY SEWER.
- 3. PROVIDE RECESSED WASHER CONNECTION BOX. CONNECT 2" DRAIN ROUGH IN TO EXISTING PIPING IN CHASE. CONNECT HOT AND COLD WATER PIPING TO EXISTING PIPING IN CHASE. SEE WASTE RISER DIAGRAM, THIS SHEET.
- 4. RE-INSTALL EXISTING 2-COMPARTMENT KITCHEN SINK TO NEW COUNTERTOP WITH NEW SCREW AND CLIPS. PROVIDE NEW P-TRAP, ANGLE SUPPLIES DRAIN ROUGH-IN AND MAKE ALL FINAL CONNECTIONS TO WATER AND DRAIN CONNECTIONS IN CHASE. SEE WASTE RISER DIAGRAM, SHEET P10.
- 5. EXISTING 3" WASTE STACK.
- 6. PROVIDE 3/4" METER IN ACCESS PANEL. SEE ARCHITECTURAL DRAWINGS FOR LOCATION. SEE WATER RISER DIAGRAM SHEET P-10. EXTEND PIPING FROM METER TO EXISTING PIPING AS INDICATED.
- RE-INSTALL EXISTING WALL-HUNG LAVATORY AND HANGER BRACKET. PROVIDE P-TRAP, ANGLE SUPPLIES, DRAIN ROUGH-IN, AND MAKE FINAL CONNECTION TO EXISTENCY WASTE RISER DIAGRAM, THIS SHEET.
- 8. NOT USED.
- 9. EXISTING BATH TUB.
- 10. PROVIDE NEW 3/4" HOT WATER AND COLD WATER PIPING FROM WATER HEATER TO POINTS INDICATED. RUN PIPING IN NEW SOFFIT SPACE.
- 11. PROVIDE VALVES AND FINAL CONNECTIONS TO WATER HEATER/HEATING UNIT AS INDICATED ON MECHANICAL DRAWINGS.
- 12. PROVIDE ROUGH-IN PIPING AND CONNECT TO EXISTING TUB WASTE AND EXTEND PIPING AS INDICATED. SEE WASTE RISER DIAGRAM, THIS SHEET.
- 13. RE-INSTALL WATER CLOSET AT COMPLETION OF NEW FLOOR FINISH WORK. PROVIDE WAX RING AND RE-SET TO EXISTING CLOSET FLANGE AND WATER SUPPLY.
- 14. PROVIDE TUB/SHOWER VALVE, FILL SPOUT, SHOWER ARM AND SHOWER HEAD. CONNECT TO EXISTING WATER ROUGH—IN. SEE FIXTURE CONNECTION SCHEDULE (P-11).
- 15. PROVIDE 1/2" UPRIGHT SPRINKLER HEAD, 3/4" CHECK VALVE AND 3/4" PIPING FROM SPRINKLER HEAD TO EXISTING COLD WATER PIPING. INSTALL IN ACCORDANCE WITH NFPA 13.

### NOTES THIS SHEET

- 1. FOR LEGEND, SEE SHEET P4.
- 2. FOR GENERAL NOTES, SEE SHEET P4.
- 3. FOR WATER HEATER/HEATING UNIT DETAIL, SEE SHEET M19.

COMPREHENSIVE RENOVATION VA 3-2 MARSHALL COURTS

NEWPORT NEWS, VA

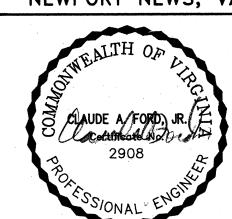

T.L.M. Designed D.P.M. Drawni C.A.F. Checked AS NOTED Scale

Date: JANUARY 31, 1992


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Project No: 90006


BUILDING TYPE B — FLOOR PLANS (NEW WORK)

Sheet No


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S WASTE RISER DIAGRAM
NOT TO SCALE

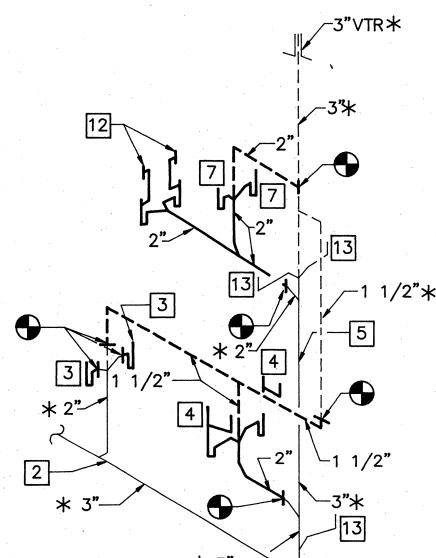


WASTE RISER DIAGRAM
NOT TO SCALE

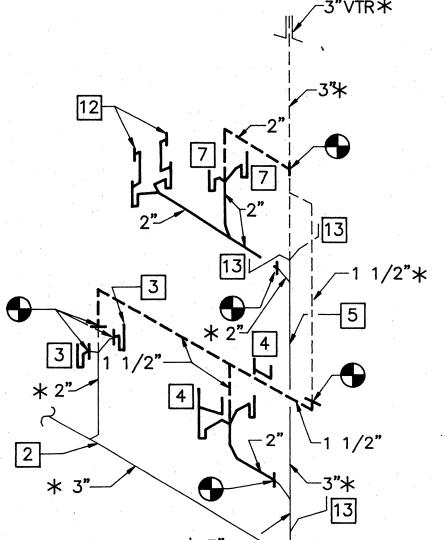


FLOOR PLAN - BUILDING D2 (DEMOLITION)

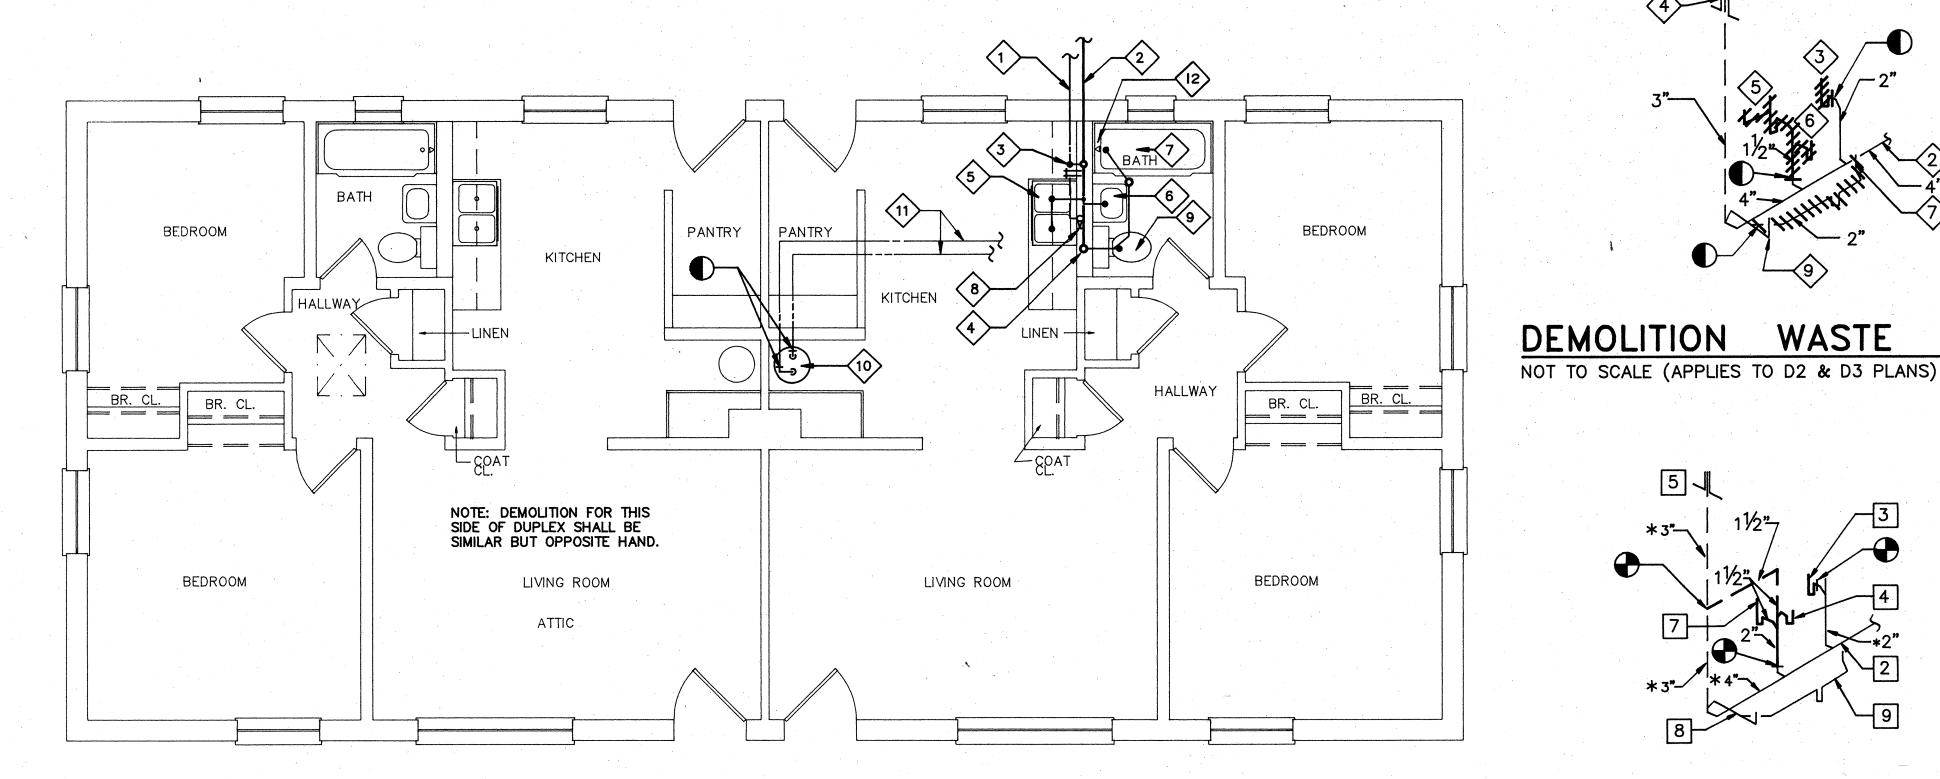SCALE: 1/4" = 1'-0"

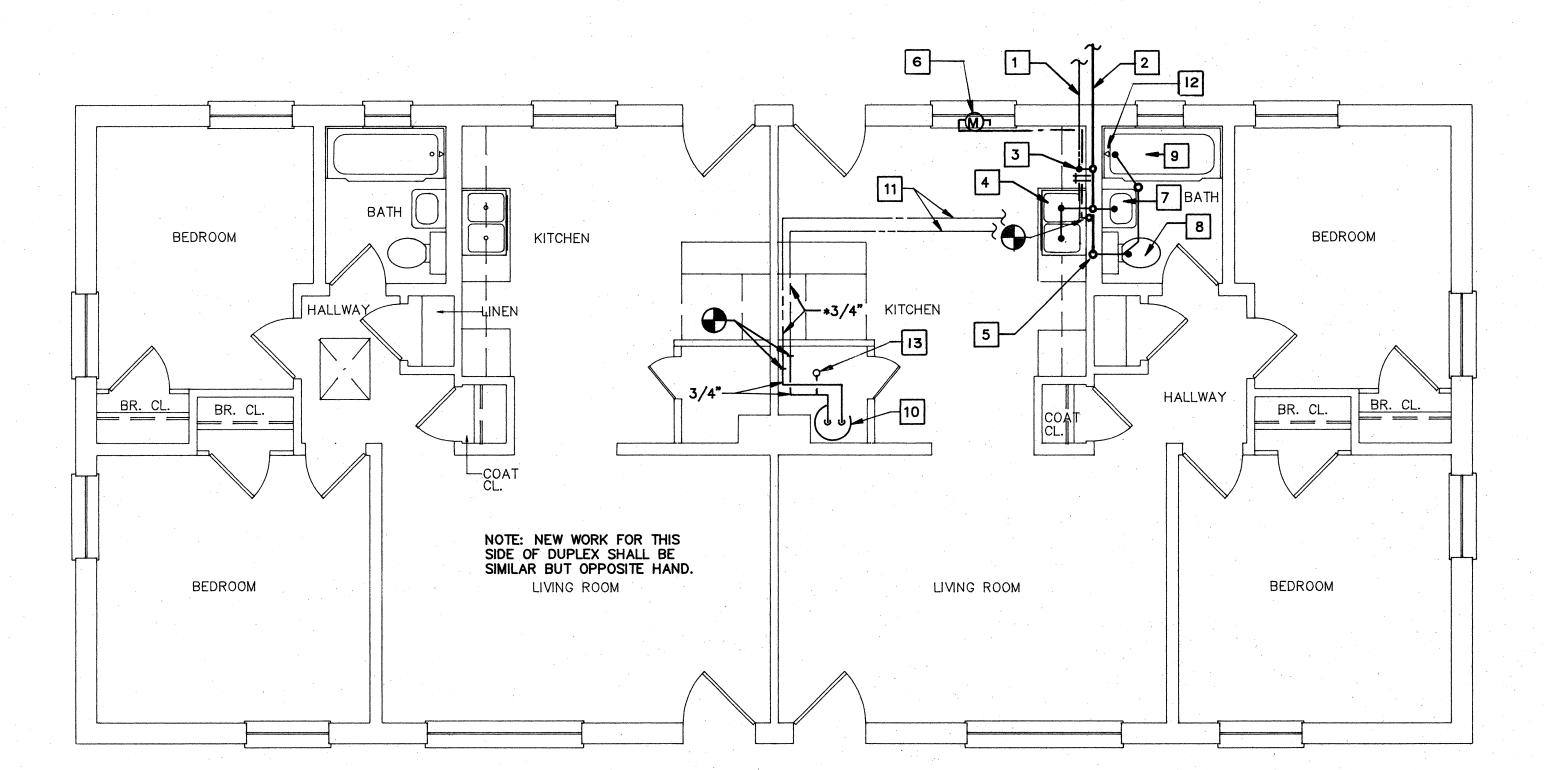

FLOOR PLAN - BUILDING D2 (NEW WORK)

SCALE: 1/4" = 1'-0"

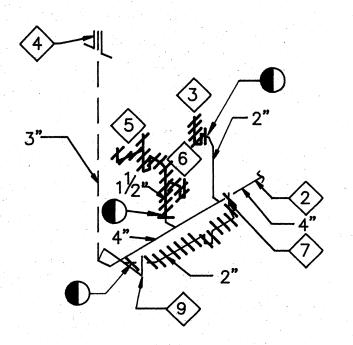

WASTE DIAGRAM RISER DEMOLITION

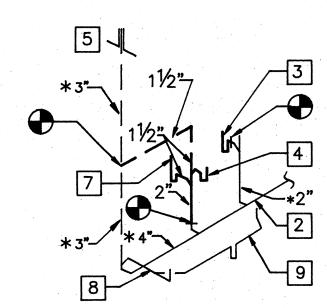


DIAGRAM NOT TO SCALE (APPLIES TO D2 & D3 PLANS)

### **DEMOLITION NOTES**

- 1. 3/4" COLD WATER SERVICE TO REMAIN.
- 2. 4" UNDERGROUND SANITARY SEWER TO REMAIN.
- 3. REMOVE HOT AND COLD WATER HOSE BIBBS AND STANDPIPE SERVING CLOTHES WASHER. TEMPORARILY CAP WATER AND DRAIN PIPING INSIDE WALL.
- 4. 3" VENT STACK TO REMAIN.
- REMOVE 2-COMPARTMENT KITCHEN SINK FROM CABINET. STORE FOR RE-USE. REMOVE WASTE, P-TRAP, SUPPLIES, SHUT-OFF AND GALVANIZED STEEL DRAIN ROUGH-IN PIPING TO CAST IRON. SEE WASTE DEMOLITION DIAGRAM THIS SHEET.
- REMOVE WALL-MOUNTED LAVATORY, HANGER BRACKET, TRAP, SUPPLIES AND GALVANIZED STEEL DRAIN ROUGH-IN PIPING TO CAST IRON. SEE WASTE DEMOLITION DIAGRAM THIS SHEET. STORE LAVATORY FOR RE-USE.
- 7. PLUMBING FIXTURE SHALL REMAIN.
- 8. REMOVE 3/4" VALVE IN RISER UNDER SINK AND CAP TEMPORARILY. SEE NEW WORK PLAN FOR ADDITIONAL WORK.
- REMOVE FLOOR MOUNTED FLUSH TANK WATER CLOSET TO ALLOW FOR NEW ARCHITECTURAL FLOOR FINISH. STORE FIXTURE FOR RE-USE. CLEAN WAX FROM FLOOR FLANGE. CAP WASTE PIPE TEMPORARILY.
- 10. REMOVE GAS FIRED WATER HEATER. SEE MECHANICAL DRAWINGS FOR GAS PIPE DEMOLITION. CAP HOT WATER AND COLD WATER PIPING TEMPORARILY FOR CONNECTION OF NEW WORK.
- 11. REMOVE ASBESTOS PIPE INSULATION FROM EXISTING WATER SUPPLY PIPING IN ATTIC AND KITCHEN PER SPECIFICATION SECTION 02080.
- 12. REMOVE TUB VALVE, SPOUT, SHOWER ARM AND SHOWER HEAD.

### WORK NOTES

- 1. EXISTING 3/4" COLD WATER SERVICE.
- 2. EXISTING UNDERGROUND SANITARY SEWER.
- PROVIDE RECESSED WASHER CONNECTION BOX. CONNECT 2" DRAIN, TO EXISTING CONNECTION IN WALL. CONNECT HOT AND COLD WATER PIPING TO EXISTING CONNECTIONS IN WALL. SEE FIXTURE CONNECTION SCHEDULE (P-4).
- RE-INSTALL EXISTING 2-COMPARTMENT KITCHEN SINK TO NEW COUNTERTOP WITH NEW SCREWS AND CLIPS. PROVIDE P-TRAP, ANGLE SUPPLIES, DRAIN ROUGH-IN AND MAKE FINAL CONNECTIONS TO EXISTING WATER AND DRAIN CONNECTIONS IN CHASE. SEE WASTE RISER DIAGRAM THIS SHEET.
- 5. EXISTING 3" VENT THRU ROOF.
- 6. PROVIDE 3/4" METER IN ACCESS PANEL. SEE ARCHITECTURAL DRAWINGS FOR LOCATION. SEE WATER RISER DIAGRAM SHEET P-10. EXTEND PIPING FROM METER TO EXISTING PIPING AS INDICATED.
- 7. RE-INSTALL EXISTING WALL-HUNG LAVATORY AND HANGER BRACKET. PROVIDE P-TRAP, ANGLE SUPPLIES, DRAIN ROUGH-IN, AND MAKE FINAL CONNECTIONS TO EXISTING WATER AND DRAIN CONNECTIONS IN CHASE. SEE WASTE RISER DIAGRAM
- 8. RE-INSTALL WATER CLOSET AT COMPLETION OF NEW FLOOR FINISH WORK. PROVIDE WAX RING AND RE-SET TO EXISTING CLOSET FLANGE AND WATER SUPPLY.
- 9. EXISTING BATHTUB.
- 10. PROVIDE VALVES AND FINAL CONNECTIONS TO WATER HEATER/HEATING
- UNIT AS INDICATED ON MECHANICAL DRAWINGS.
- 11. PROVIDE PIPE INSULATION FROM WATER HEATER CONNECTION TO KITCHEN AND BATH FIXTURE CONNECTIONS.
- 12. PROVIDE TUB/SHOWER VALVE, FILL SPOUT, SHOWER ARM AND SHOWER HEAD. CONNECT TO EXISTING WATER ROUGH-IN. SEE FIXTURE CONNECTION
- PROVIDE 1/2" UPRIGHT SPRINKLER HEAD, 3/4" CHECK VALVE AND 3/4" PIPING FROM SPRINKLER HEAD TO EXISTING COLD WATER PIPING. INSTALL IN ACCORDANCE WITH NFPA 13.

### NOTES THIS SHEET

- 1. FOR LEGEND, SEE SHEET P4.
- 2. FOR GENERAL NOTES, SEE SHEET P4.
- 3. FOR FIXTURE CONNECTION SCHEDULE, SEE SHEET P6.
- 4. FOR WATER HEATER/HEATING UNIT DETAIL, SEE SHEET M19.

### **ABATEMENT**

PLUMBING PIPE INSULATION HAS BEEN TESTED AND IS KNOWN TO CONTAIN ASBESTOS MATERIALS. ALL PIPES INDICATED FOR REMOVAL SHALL BE ABATED OF ASBESTOS MATERIAL IN ACCORDANCE WITH SPECIFICATION SECTION 02080 BY THE ABATEMENT CONTRACTOR.



COMPREHENSIVE RENOVATION VA 3-2 MARSHALL COURTS

NEWPORT NEWS, VA



T.L.M. Designed D.P.M. Drawni C.A.F. Checked


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File Noi

Project No: 90006


BUILDING TYPE D2 -FLOOR PLANS (DEMOLITION & NEW WORK)

Sheet No

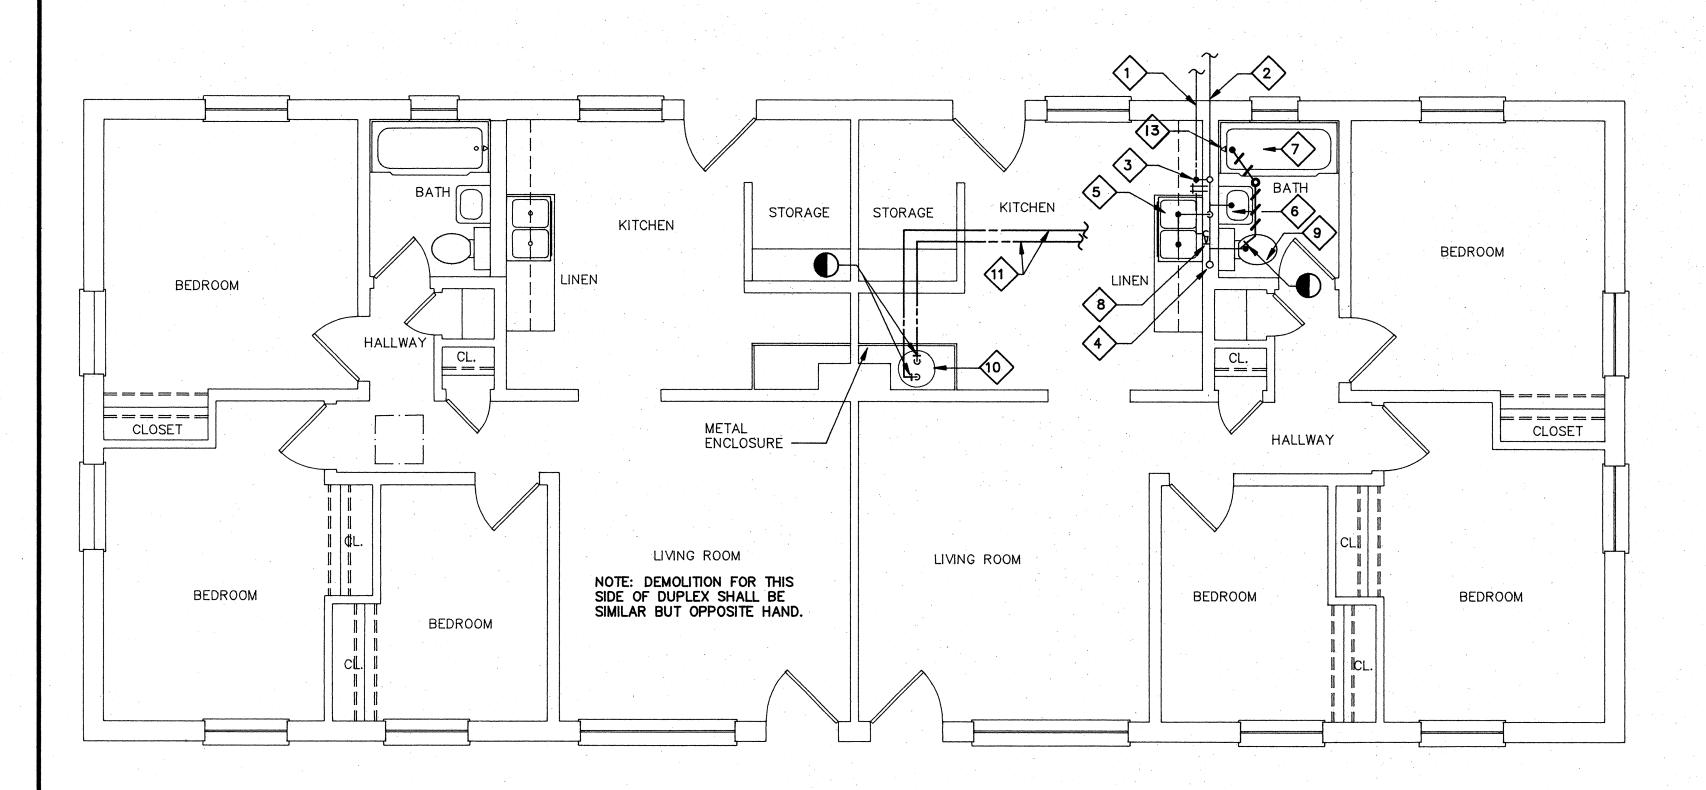

### FLOOR PLAN - BUILDING D3 (DEMOLITION)

SCALE: 1/4" = 1'-0"

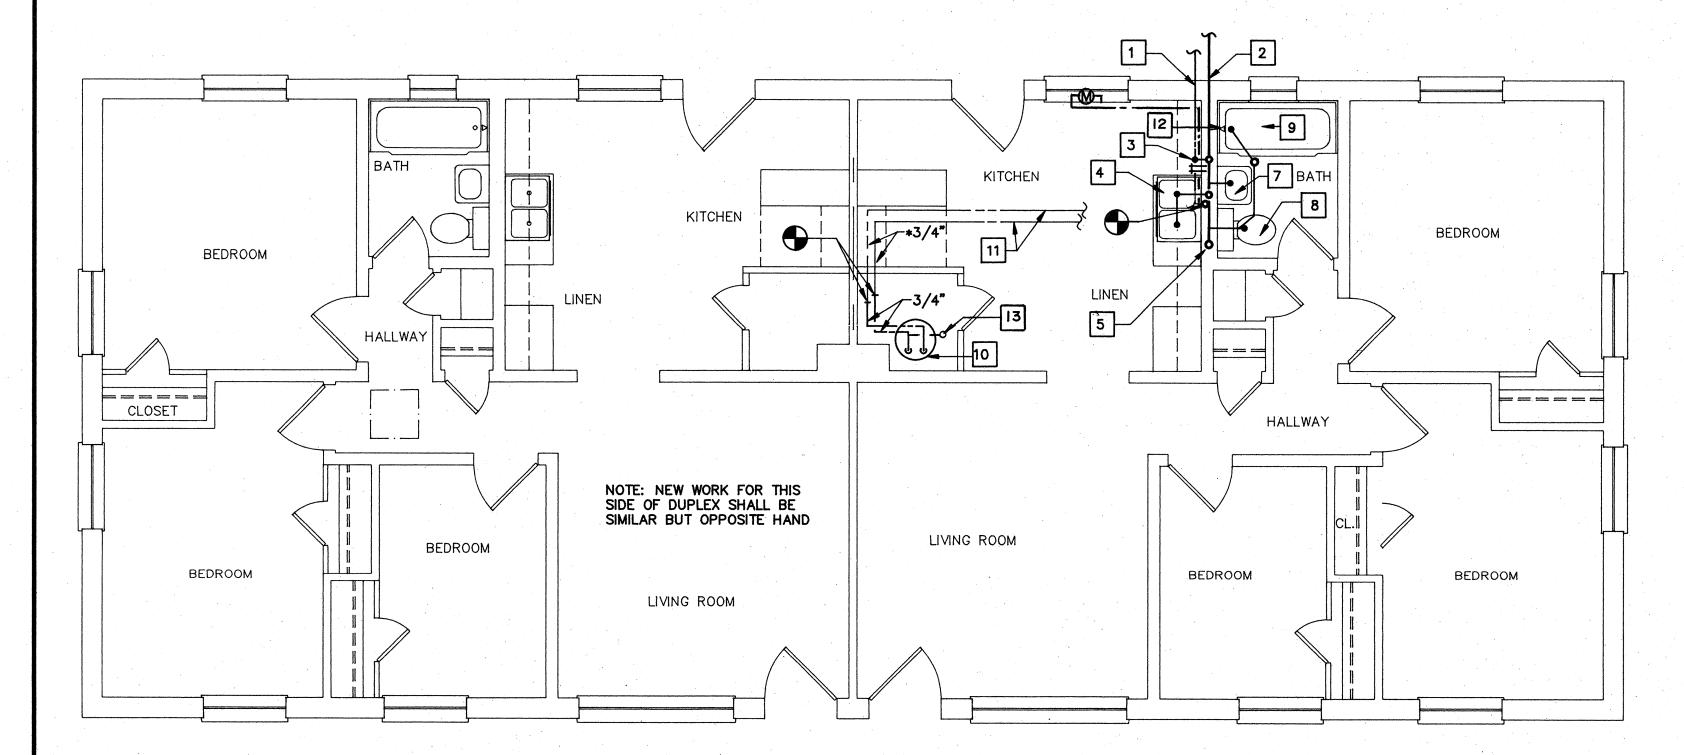

# FLOOR PLAN - BUILDING D3 (NEW WORK)

SCALE: 1/4" = 1'-0"

### DEMOLITION NOTES

- 1. 3/4" COLD WATER SERVICE TO REMAIN.
- 2. 4" UNDERGROUND SANITARY SEWER TO REMAIN.
- 3. REMOVE HOT AND COLD WATER HOSE BIBBS AND STANDPIPE SERVING CLOTHES WASHER. TEMPORARILY CAP WATER AND DRAIN PIPING INSIDE WALL.
- 4. 3" VENT STACK TO REMAIN.
- 5. REMOVE 2—COMPARTMENT KITCHEN SINK FROM CABINET. STORE FOR RE—USE. REMOVE WASTE, P—TRAP, SUPPLIES, SHUT—OFF AND GALVANIZED STEEL DRAIN ROUGH—IN PIPING TO CAST IRON. SEE WASTE DEMOLITION DIAGRAM, SHEET P7.
- 6. REMOVE WALL-MOUNTED LAVATORY, HANGER BRACKET, TRAP, SUPPLIES AND GALVANIZED STEEL DRAIN ROUGH-IN PIPING TO CAST IRON. SEE WASTE DEMOLITION DIAGRAM, SHEET P7. STORE LAVATORY FOR RE-USE.
- 7. PLUMBING FIXTURE SHALL REMAIN.
- 8. REMOVE 3/4" VALVE IN RISER UNDER SINK AND CAP TEMPORARILY. SEE NEW WORK PLAN FOR ADDITIONAL WORK.
- 9. REMOVE FLOOR MOUNTED FLUSH TANK WATER CLOSET TO ALLOW FOR NEW ARCHITECTURAL FLOOR FINISH. STORE FIXTURE FOR RE—USE. CLEAN WAX FROM FLOOR FLANGE. CAP WASTE PIPE TEMPORARILY.
- 10. REMOVE GAS FIRED WATER HEATER. SEE MECHANICAL DRAWINGS FOR GAS PIPE DEMOLITION. CAP HOT WATER AND COLD WATER PIPING TEMPORARILY FOR CONNECTION OF NEW WORK.
- 11. REMOVE ASBESTOS PIPE INSULATION FROM EXISTING WATER SUPPLY PIPING IN ATTIC AND KITCHEN PER SPECIFICATION SECTION 02080.
- 12. REMOVE CAST IRON BATHTUB, FAUCET, SHOWER HEAD, TUB WASTE, AND WATER AND DRAIN ROUGH—IN PIPING TO EXTENT SHOWN.
- 13. REMOVE TUB VALVE, SPOUT, SHOWER ARM AND SHOWER HEAD.

### NEW WORK NOTES

- 1. EXISTING 3/4" COLD WATER SERVICE.
- 2. EXISTING UNDERGROUND SANITARY SEWER.
- 3. PROVIDE RECESSED WASHER CONNECTION BOX. CONNECT 2" DRAIN TO EXISTING CONNECTION IN WALL. CONNECT HOT AND COLD WATER PIPING TO EXISTING CONNECTIONS IN WALL. SEE FIXTURE CONNECTION SCHEDULE (P-4).
- 4. RE-INSTALL EXISTING 2-COMPARTMENT KITCHEN SINK TO NEW COUNTERTOP WITH NEW SCREWS AND CLIPS. PROVIDE P-TRAP, ANGLE SUPPLIES, DRAIN ROUGH-IN AND MAKE FINAL CONNECTIONS TO EXISTING WATER AND DRAIN CONNECTIONS IN CHASE. SEE WASTE RISER DIAGRAM THIS SHEET.
- 5. EXISTING 3" VENT THRU ROOF.
- 6. PROVIDE 3/4" METER IN ACCESS PANEL. SEE ARCHITECTURAL DRAWINGS FOR LOCATION. SEE WATER RISER DIAGRAM SHEET P-10. EXTEND PIPING FROM METER TO EXISTING PIPING AS INDICATED.
- RE-INSTALL EXISTING WALL-HUNG LAVATORY AND HANGER BRACKET. PROVIDE P-TRAP, ANGLE SUPPLIES, DRAIN ROUGH-IN, AND MAKE FINAL CONNECTIONS TO EXISTING WATER AND DRAIN CONNECTIONS IN WALL. SEE WASTE RISER DIAGRAM, SHEET P7.
- 8. RE-INSTALL WATER CLOSET AT COMPLETION OF NEW FLOOR FINISH WORK. PROVIDE WAX RING AND RE-SET TO EXISTING CLOSET FLANGE AND WATER SUPPLY.
- 9. EXISTING BATHTUB.

SCHEDULE (P-11).


- 10. PROVIDE VALVES AND FINAL CONNECTIONS TO WATER HEATER/HEATING UNIT AS INDICATED ON MECHANICAL DRAWINGS.
- 11. PROVIDE PIPE INSULATION FROM WATER HEATER CONNECTION TO KITCHEN
- AND BATH FIXTURE CONNECTIONS.

  12. PROVIDE TUB/SHOWER VALVE, FILL SPOUT, SHOWER ARM AND SHOWER HEAD. CONNECT TO EXISTING WATER ROUGH—IN. SEE FIXTURE CONNECTION
- 13. PROVIDE 1/2" UPRIGHT SPRINKLER HEAD, 3/4" CHECK VALVE AND 3/4" PIPING FROM SPRINKLER HEAD TO EXISTING COLD WATER PIPING. INSTALL IN ACCORDANCE WITH NFPA 13.

# NNRHA

COMPREHENSIVE RENOVATION OF VA 3-2 MARSHALL COURTS

NEWPORT NEWS, VA

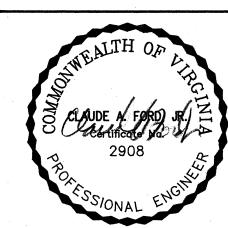

Designed:	T.L.M.
Drawn	DPM
Checked	C.A.F.
Scalei	AS NOTED

### NOTES THIS SHEET

- 1. FOR LEGEND, SEE SHEET P4.
- 2. FOR GENERAL NOTES, SEE SHEET P4.
- 3. FOR FIXTURE CONNECTION SCHEDULE, SEE SHEET P6.
- 4. FOR WATER HEATER/HEATING UNIT DETAIL, SEE SHEET M19.
- 5. FOR WASTE RISER DIAGRAMS, SEE SHEET P7.

### ABATEMENT NOTE

PLUMBING PIPE INSULATION HAS BEEN TESTED AND IS KNOWN TO CONTAIN ASBESTOS MATERIALS. ALL PIPES INDICATED FOR REMOVAL SHALL BE ABATED OF ASBESTOS MATERIAL IN ACCORDANCE WITH SPECIFICATION SECTION 02080 BY THE ABATEMENT CONTRACTOR.

Date: JANUARY 31, 1992


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Project No: 90006

BUILDING
TYPE D3 FLOOR PLANS
(DEMOLITION &
NEW WORK)


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Sheet No. P8




### FIRST FLOOR PLAN - BLDG. D4 (DEMOLITION)

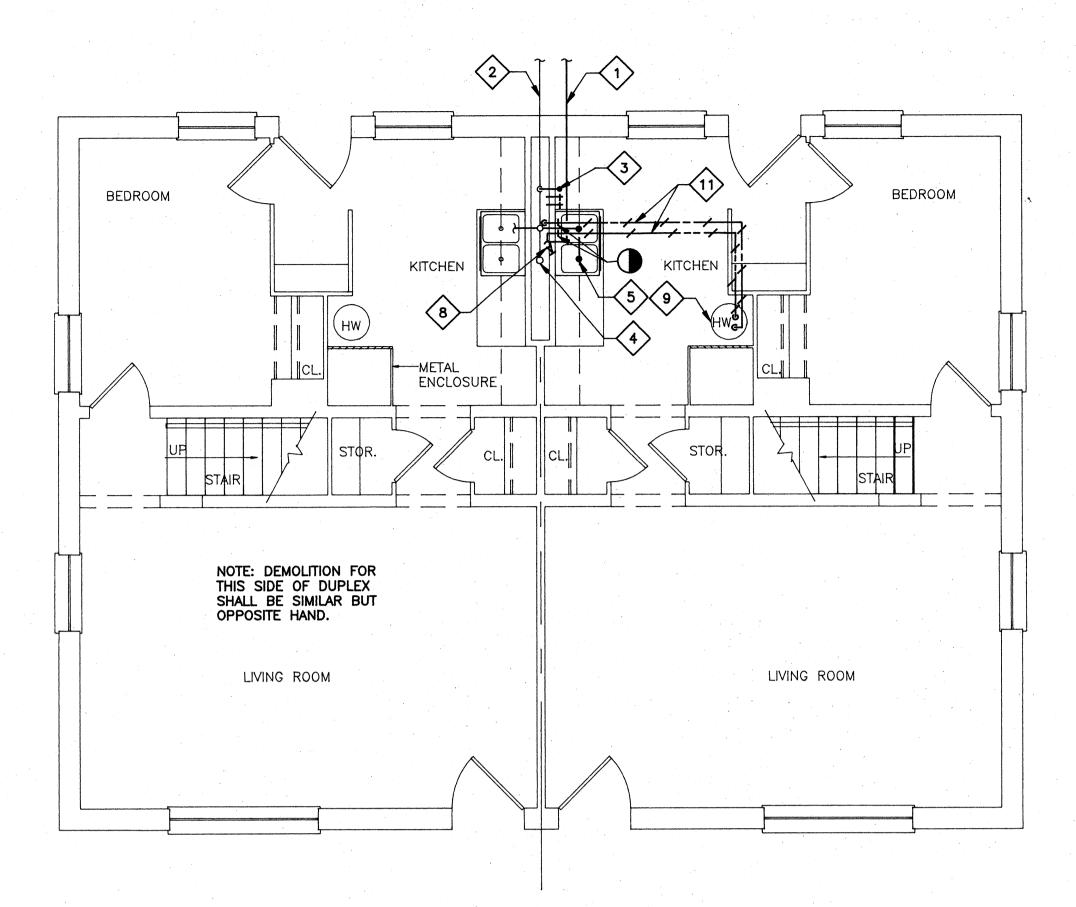SCALE: 1/4" = 1'-0"

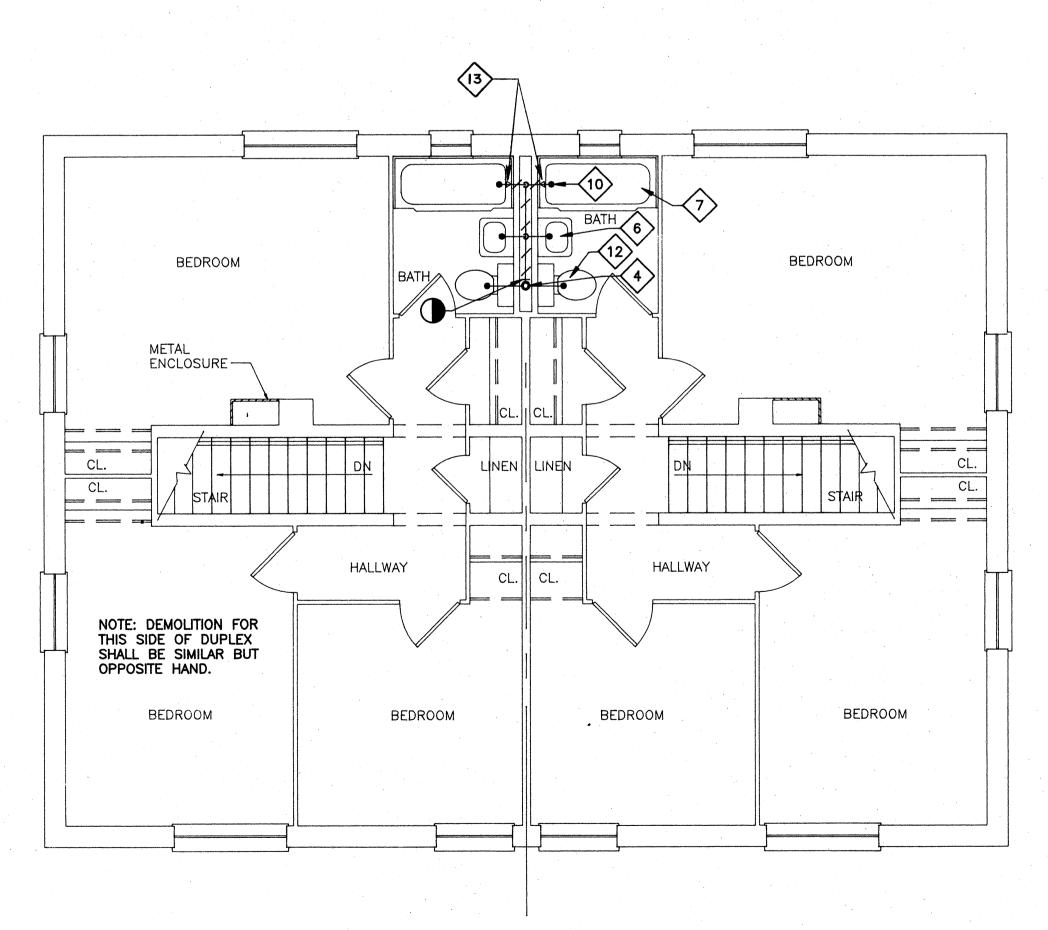


SECOND FLOOR PLAN - BLDG. D4 (DEMOLITION)

SCALE: 1/4" = 1'-0"

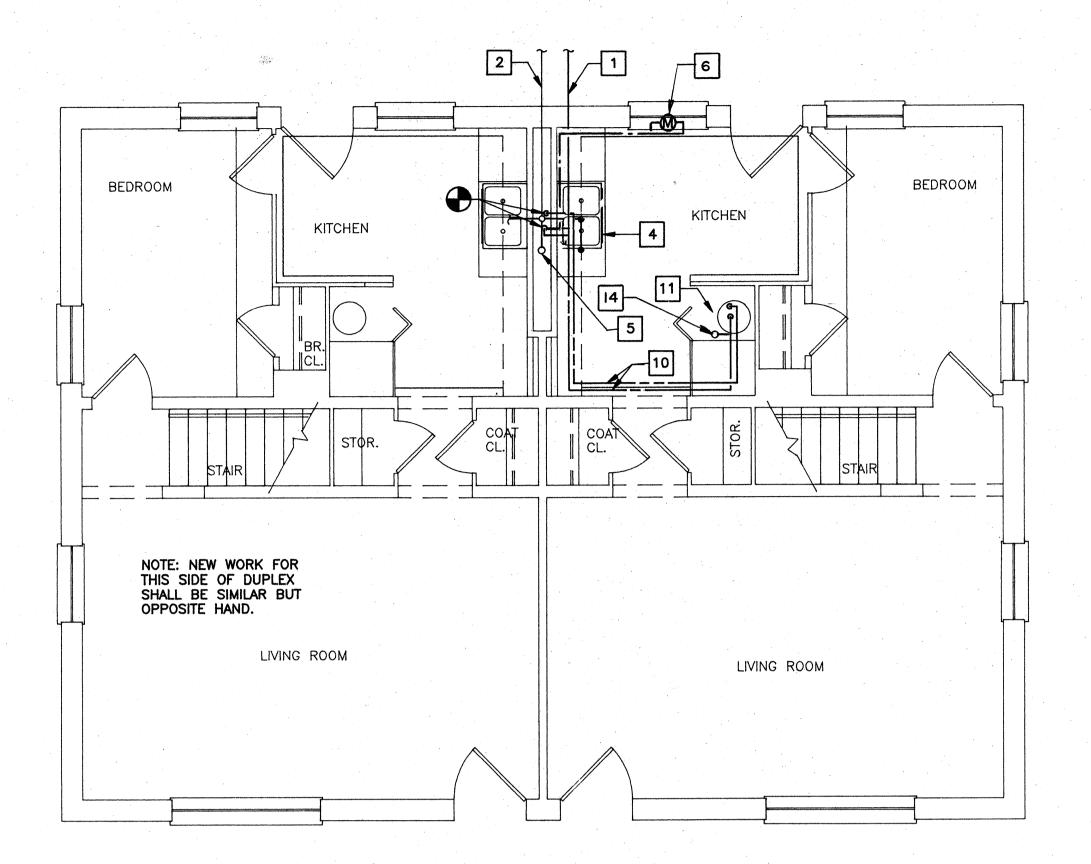

### FIRST FLOOR PLAN - BLDG. D4 (NEW WORK)

SCALE: 1/4" = 1'-0"

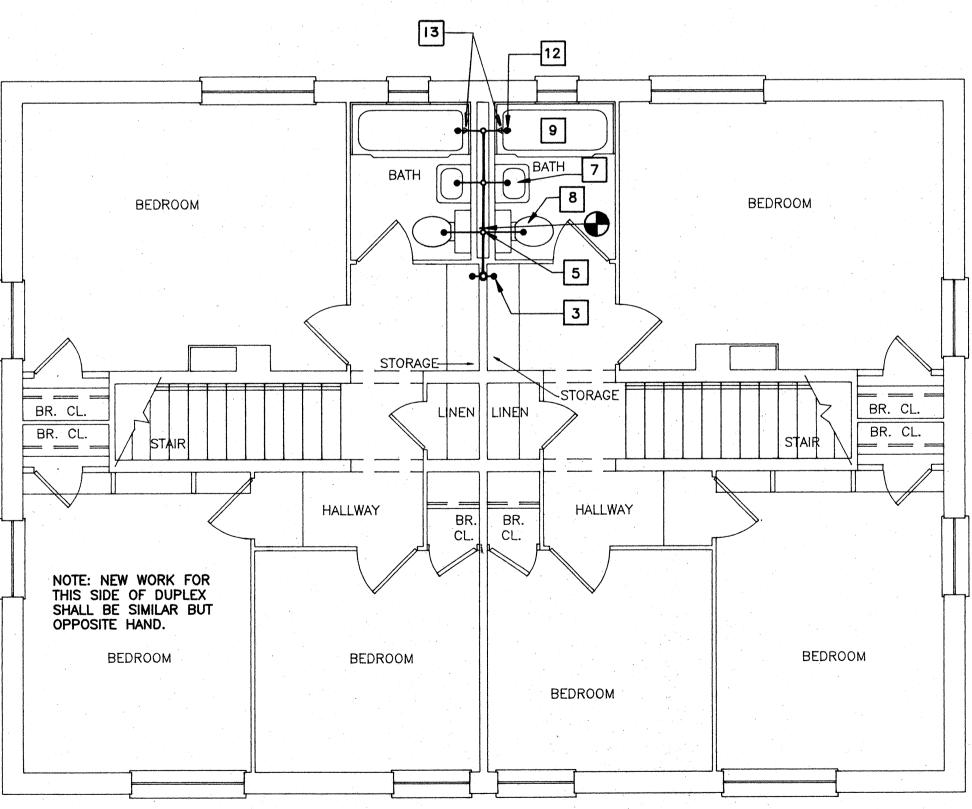

### SECOND FLOOR PLAN - BLDG. D4 (NEW WORK)

### DEMOLITION NOTES

- 3/4" COLD WATER SERVICE TO REMAIN.
- 4" UNDERGROUND SANITARY SEWER TO REMAIN.
- REMOVE HOT AND COLD WATER HOSE BIBBS AND STANDPIPE SERVING CLOTHES WASHER. CAP WATER AND DRAIN PIPING INSIDE WALL.
- 4. 3" WASTE STACK TO REMAIN.
- REMOVE 2-COMPARTMENT KITCHEN SINK FROM CABINET. STORE FOR RE-USE. REMOVE WASTE, P-TRAP, SUPPLIES, SHUT-OFF AND GALVANIZED STEEL DRAIN ROUGH-IN PIPING TO CAST IRON. SEE WASTE DEMOLITION DIAGRAM SHEET, P14.
- REMOVE WALL-MOUNTED LAVATORY, HANGER BRACKET, TRAP, SUPPLIES AND GALVANIZED STEEL DRAIN ROUGH-IN PIPING TO CAST IRON. SEE WASTE DEMOLITION DIAGRAM SHEET, P14. STORE LAVATORY FOR RE-USE.
- 7. PLUMBING FIXTURE SHALL REMAIN.
- REMOVE 3/4" VALVE IN RISER UNDER SINK AND CAP TEMPORARILY. SEE NEW WORK PLAN FOR ADDITIONAL WORK.
- REMOVE GAS FIRED WATER HEATER. SEE MECHANICAL DRAWINGS FOR GAS PIPE DEMOLITION.
- REMOVE TRAP AND GALVANIZED STEEL DRAIN PIPING FOR TUB WASTE TO WASTE STACK, TUB WASTE AND OVERFLOW TO REMAIN, SEE WASTE DEMOLITION DIAGRAM, SHEET P14.
- REMOVE WATER PIPING AND ASBESTOS PIPE INSULATION AT CEILING TO POINTS INDICATED.
- REMOVE FLOOR MOUNTED FLUSH TANK WATER CLOSET TO ALLOW FOR NEW ARCHITECTURAL FLOOR FINISH. STORE FIXTURE FOR RE-USE. CLEAN WAX FROM FLOOR FLANGE. CAP WASTE PIPE TEMPORARILY.
- 3. REMOVE TUB VALVE, SPOUT, SHOWER ARM AND SHOWER HEAD.

### NEW WORK NOTES

- 1. EXISTING 3/4" COLD WATER SERVICE.
- 2. EXISTING 4" UNDERGROUND SANITARY SEWER.
- 3. PROVIDE RECESSED WASHER CONNECTION BOX. CONNECT 2" DRAIN TO PIPING IN CHASE. CONNECT HOT AND COLD WATER PIPING TO EXISTING CONNECTIONS IN CHASE. SEE FIXTURE CONNECTION SCHEDULE (P4). SEE WASTE RISER DIAGRAM SHEET, P14.
- RE-INSTALL EXISTING 2-COMPARTMENT KITCHEN SINK TO NEW COUNTERTOP WITH NEW SCREWS AND CLIPS. PROVIDE P-TRAP, ANGLE SUPPLIES, DRAIN ROUGH-IN AND MAKE FINAL CONNECTIONS TO EXISTING WATER AND DRAIN CONNECTIONS IN CHASE. SEE WASTE RISER DIAGRAM SHEET, P14.
- 5. EXISTING 3" WASTE STACK.
- 6. PROVIDE 3/4" METER IN ACCESS PANEL. SEE ARCHITECTURAL DRAWINGS FOR LOCATION. SEE WATER RISER DIAGRAM SHEET P-10. EXTEND PIPING FROM METER TO EXISTING PIPING AS INDICATED.
- . RE-INSTALL EXISTING WALL-HUNG LAVATORY AND HANGER BRACKET. PROVIDE P-TRAP, ANGLE SUPPLIES, DRAIN ROUGH-IN, AND MAKE FINAL CONNECTION TO EXISTING WATER AND DRAIN CONNECTIONS IN CHASE. SEE WASTE RISER DIAGRAM
- 8. RE-INSTALL WATER CLOSET AT COMPLETION OF FLOOR FINISH WORK. PROVIDE WAX RING AND RE-SET TO EXISTING CLOSET FLANGE AND WATER SUPPLY.
- 9. EXISTING BATHTUB.

SCHEDULE (P-11).

- 10. PROVIDE 3/4" HOT WATER AND COLD WATER PIPING FROM WATER HEATER TO POINTS INDICATED. RUN PIPING IN NEW SOFFIT SPACE.
- PROVIDE VALVES AND FINAL CONNECTIONS TO WATER HEATER/HEATING UNIT AS INDICATED ON MECHANICAL DRAWINGS.
- 12. PROVIDE ROUGH-IN PIPING AND CONNECT TO EXISTING TUBWASTE AND EXTEND
- PIPING AS INDICATED. SEE WASTE RISER DIAGRAM, SHEET P14. 13. PROVIDE TUB/SHOWER VALVE, FILL SPOUT, SHOWER ARM AND SHOWER HEAD. CONNECT TO EXISTING WATER ROUGH—IN. SEE FIXTURE CONNECTION
- PROVIDE 1/2" UPRIGHT SPRINKLER HEAD, 3/4" CHECK VALVE AND 3/4" PIPING FROM SPRINKLER HEAD TO EXISTING COLD WATER PIPING. INSTALL IN ACCORDANCE WITH NFPA 13.

#### THIS SHEET NOTES

- 1. FOR LEGEND, SEE SHEET P4.
- 2. FOR GENERAL NOTES, SEE SHEET P4.
- 3. FOR FIXTURE CONNECTION SCHEDULE, SEE SHEET P6.
- 4. FOR WATER HEATER/HEATING UNIT DETAIL, SEE SHEET M19.
- 5. FOR WASTE RISER DIAGRAMS, SEE SHEET P14.


#### NOTE **ABATEMENT**

PLUMBING PIPE INSULATION HAS BEEN TESTED AND IS KNOWN TO CONTAIN ASBESTOS MATERIALS. ALL PIPES INDICATED FOR REMOVAL SHALL BE ABATED OF ASBESTOS MATERIAL IN ACCORDANCE WITH SPECIFICATION SECTION 02080 BY THE ABATEMENT CONTRACTOR.



COMPREHENSIVE RENOVATION VA 3-2MARSHALL COURTS

NEWPORT NEWS, VA

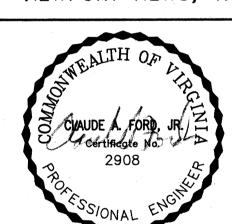


	Designed	T.L.M.
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	Checked	C.A.F.
	Scale	AS NOTED
	Date	JANUARY 31, 199

File No: Project No: 90006


> BUILDING TYPE D4 -FLOOR PLANS (DEMOLITION & NEW WORK)

Sheet No:

Sheets

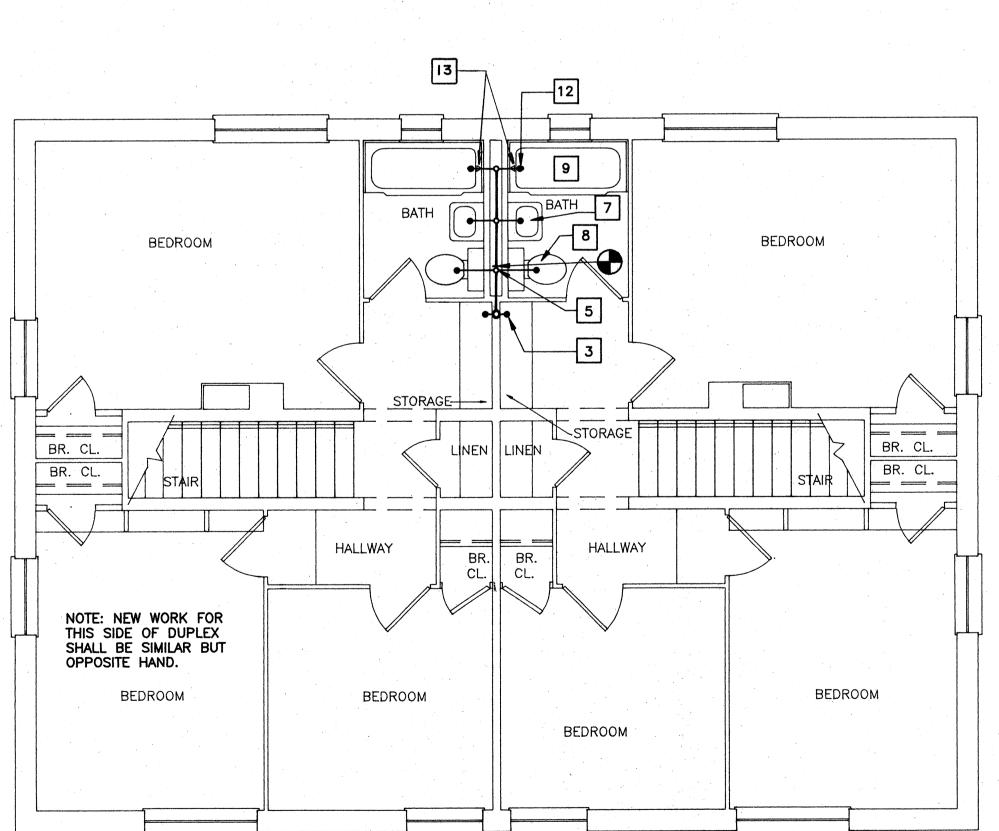


SCALE: 1/4" = 1'-0"

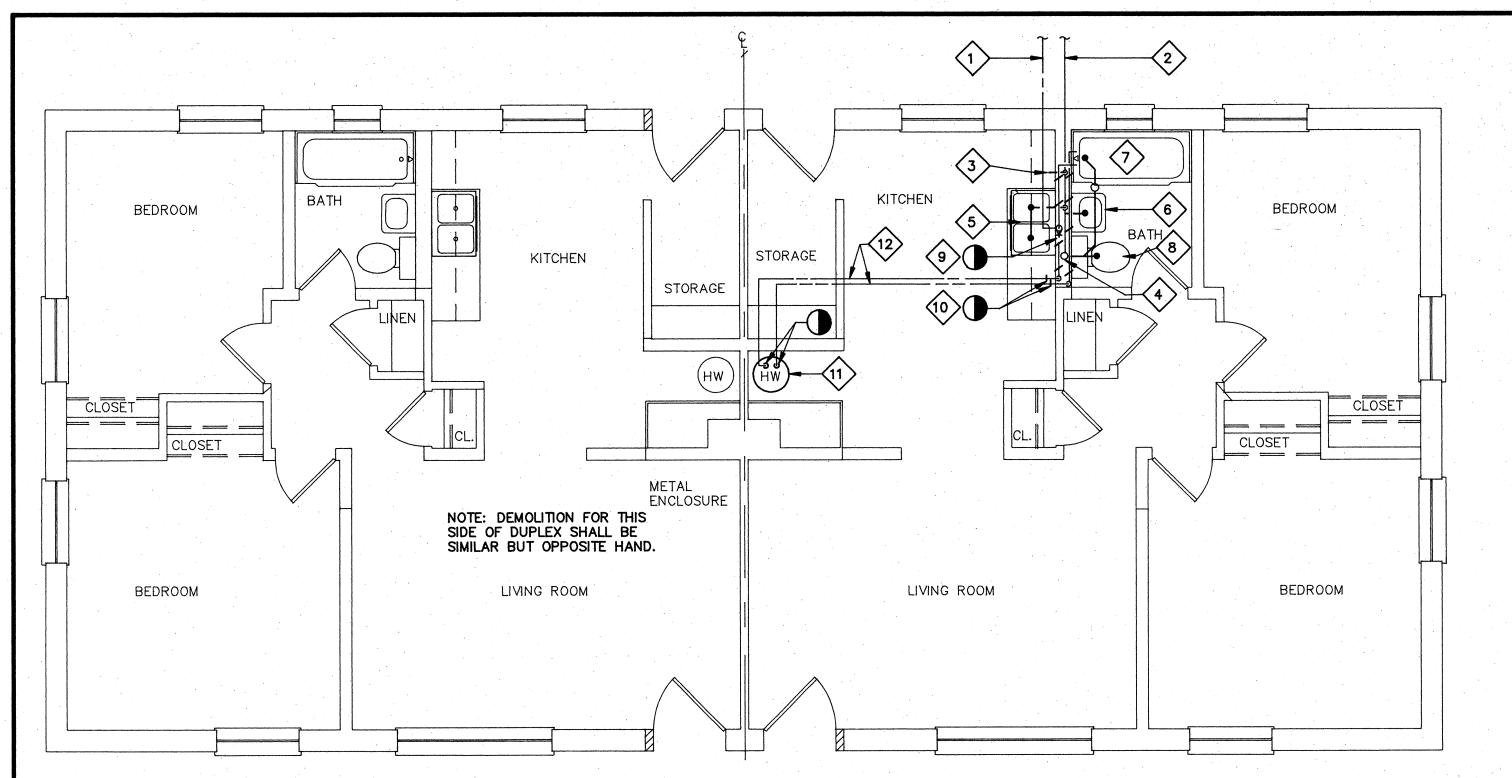


### FLOOR PLAN - BUILDING D2 / 1BR HANDICAPPED CONVERSION (DEMOLITION)

SCALE: 1/4" = 1'-0"

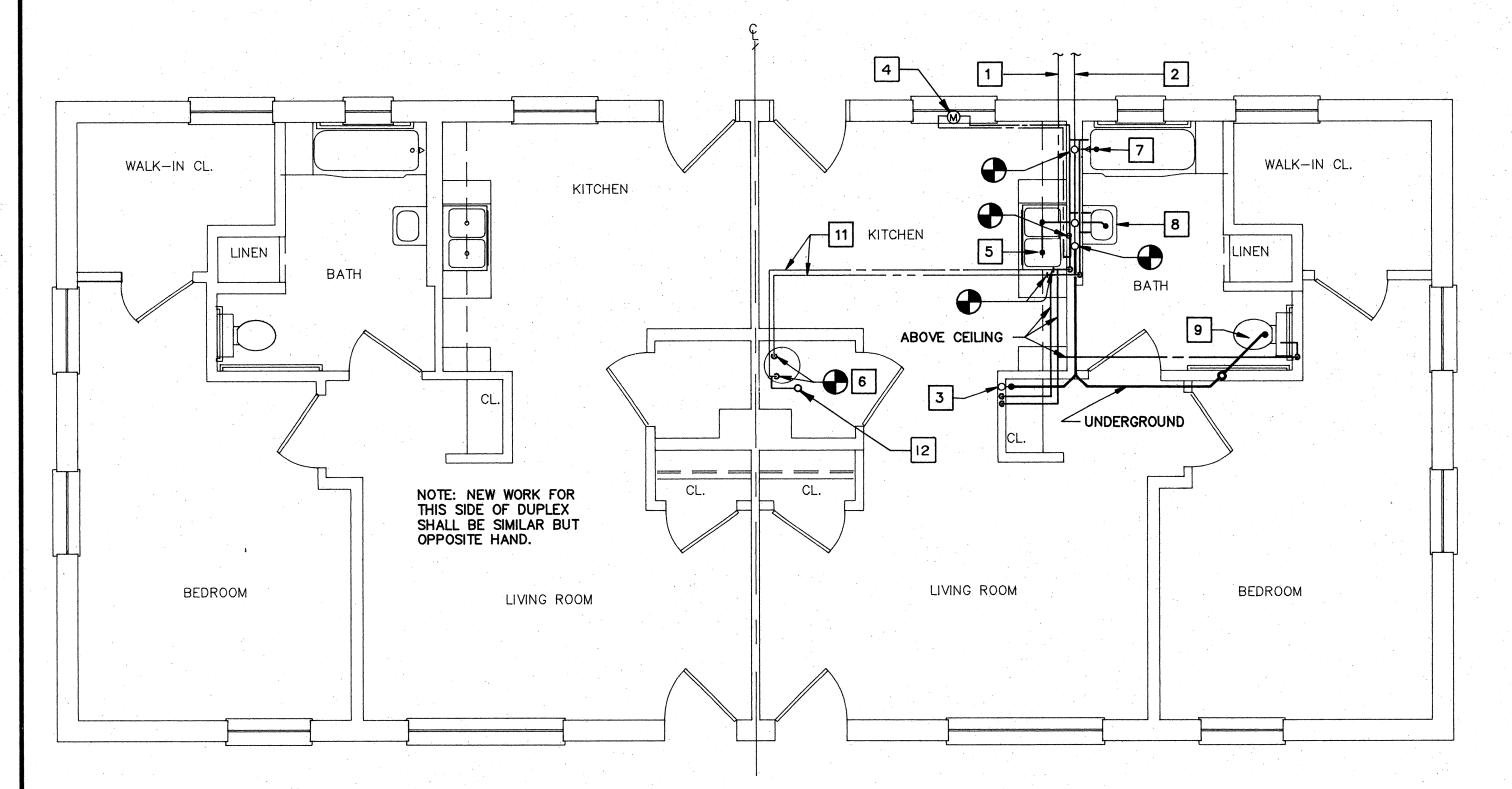


FLOOR PLAN - BUILDING D2 / 1BR HANDICAPPED CONVERSION (NEW WORK)


SCALE: 1/4" = 1'-0"

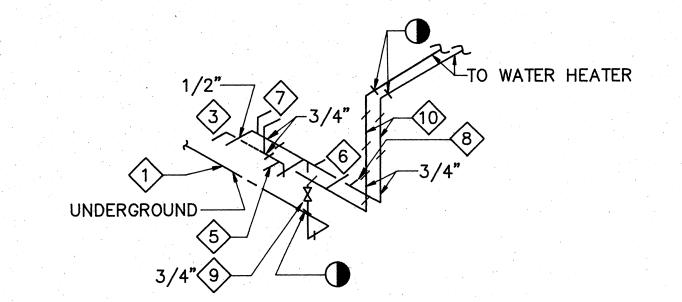

WATER RISER **DIAGRAM** 

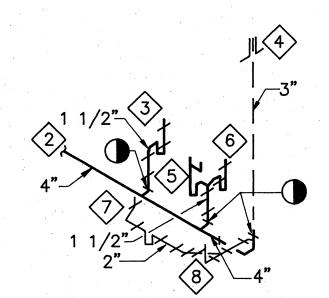

DEMOLITION NO SCALE WASTE RISER DIAGRAM

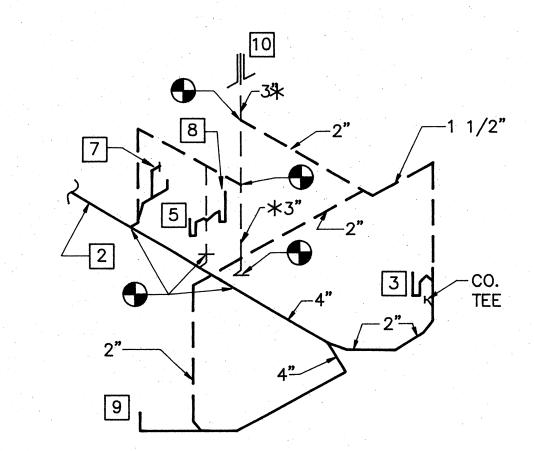

RISER DIAGRAM WASTE

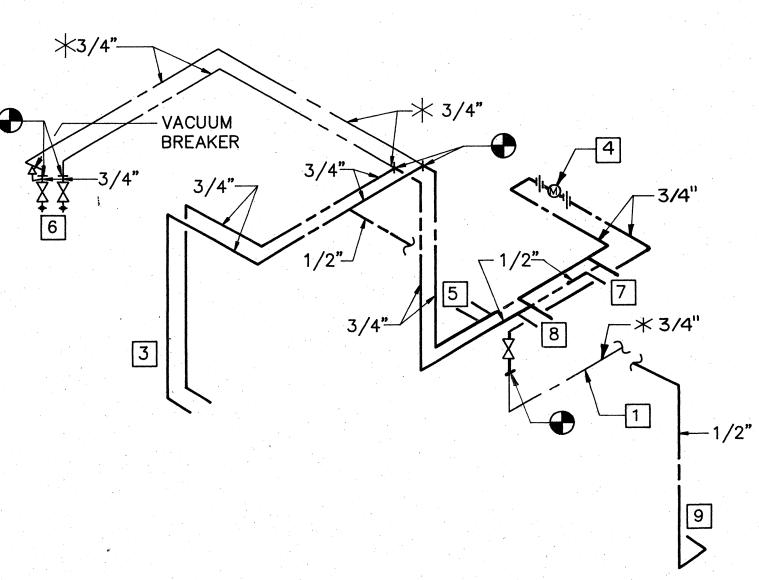


DIAGRAM WATER RISER NO SCALE

### DEMOLITION NOTES

- 1. 3/4" COLD WATER SERVICE TO REMAIN.
- 2. 4" UNDERGROUND SANITARY SEWER TO REMAIN.
- 3. REMOVE HOT AND COLD WATER HOSE BIBBS, WATER AND DRAIN ROUGH—IN PIPING, AND STANDPIPE SERVING CLOTHES WASHER.
- 4. 3" VENT STACK TO REMAIN.
- 5. REMOVE 2-COMPARTMENT KITCHEN SINK FROM CABINET. STORE FOR RE-USE. REMOVE P-TRAP, SUPPLIES, AND WATER AND DRAIN ROUGH-IN PIPING IN WALL TO
- 6. REMOVE WALL-MOUNTED LAVATORY, HANGER BRACKET AND WATER AND DRAIN ROUGH-IN PIPING IN WALL TO EXTENT SHOWN.
- REMOVE CAST IRON BATHTUB, FAUCET, SHOWER HEAD, TUB WASTE, AND WATER AND DRAIN ROUGH-IN PIPING TO EXTENT SHOWN.
- 8. REMOVE FLUSH TANK WATER CLOSET AND WATER SUPPLY PIPING IN WALL TO EXTENT SHOWN. REMOVE CLOSET FLANGE AND CAP WASTE PIPING BELOW FLOOR. PATCH FLOOR TO MATCH SURROUNDING FINISH.
- 9. REMOVE 3/4" VALVE IN RISER BELOW SINK. CAP WATER SERVICE TEMPORARILY FOR CONNECTION OF NEW WORK.
- 10. REMOVE HOT AND COLD WATER PIPING IN WALL FROM FIXTURES TO EXTENT SHOWN.
- 11. REMOVE GAS FIRED WATER HEATER. SEE MECHANICAL DRAWINGS FOR GAS PIPE DEMOLITION. CAP HOT AND COLD WATER PIPING TEMPORARILY FOR CONNECTION OF
- 12. REMOVE ASBESTOS PIPE INSULATION FROM EXISTING WATER SUPPLY PIPING IN ATTIC AND KITCHEN PER SPECIFICATION SECTION 02080.

### ☐ NEW WORK NOTES

- EXISTING 3/4" COLD WATER SERVICE.
- EXISTING 4" UNDERGROUND SANITARY SEWER.
- PROVIDE RECESSED WASHER CONNECTION BOX AND HOT WATER, COLD WATER AND DRAIN ROUGH—IN PIPING AS INDICATED. SEE FIXTURE CONNECTION
- PROVIDE 3/4" METER IN ACCESS PANEL. SEE ARCHITECTURAL DRAWINGS FOR LOCATION. SEE WATER RISER DIAGRAM SHEET P-10. EXTEND PIPING FROM METER TO EXISTING PIPING AS INDICATED.
- RE-INSTALL EXISTING 2-COMPARTMENT KITCHEN SINK TO NEW COUNTERTOP WITH NEW SCREWS AND CLIPS. PROVIDE P-TRAP, ANGLE SUPPLIES, HOT AND COLD WATER ROUGH-IN, DRAIN ROUGH-IN AND MAKE FINAL CONNECTION TO SINK.
- PROVIDE VALVES AND FINAL CONNECTIONS TO WATER HEATER/HEATING UNIT AS INDICATED ON MECHANICAL DRAWINGS.
- PROVIDE 5'-0" LONG BATHTUB, SHOWER FAUCET, TUB WASTE, AND HOT WATER AND COLD WATER ROUGH-IN PIPING. SEE FIXTURE CONNECTION SCHEDULE (P-3).
- PROVIDE WALL MOUNTED LAVATORY, FAUCET P-TRAP, ANGLE SUPPLIES, HOT WATER AND COLD WATER ROUGH-IN PIPING AND DRAIN ROUGH-IN PIPING. SEE
- PROVIDE 18" HIGH FLOOR MOUNTED, FLUSH TANK WATER CLOSET, SEAT, ANGLE SUPPLY, COLD WATER ROUGH—IN AND DRAIN ROUGH—IN PIPING. SEE FIXTURE CONNECTION SCHEDULE (P-1).
- 10. EXISTING 3" VENT THRU ROOF.

FIXTURE CONNECTION SCHEDULE (P-2).

- PROVIDE PIPE INSULATION FROM WATER HEATER CONNECTION TO KITCHEN AND BATH FIXTURE CONNECTIONS.
- 12. PROVIDE 1/2" UPRIGHT SPRINKLER HEAD, 3/4" CHECK VALVE AND 3/4" PIPING FROM SPRINKLER HEAD TO EXISTING COLD WATER PIPING. INSTALL IN ACCORDANCE WITH NFPA 13.

### NOTES THIS SHEET


- 1. FOR LEGEND, SEE SHEET P4.
- 2. FOR GENERAL NOTES, SEE SHEET P4.
- 3. FOR FIXTURE CONNECTION SCHEDULE, SEE SHEET P6.
- 4. FOR WATER HEATER/HEATING UNIT DETAIL, SEE SHEET M19.

#### **ABATEMENT** NOTE

PLUMBING PIPE INSULATION HAS BEEN TESTED AND IS KNOWN TO CONTAIN ASBESTOS MATERIALS. ALL PIPES INDICATED FOR REMOVAL SHALL BE ABATED OF ASBESTOS MATERIAL IN ACCORDANCE WITH SPECIFICATION SECTION 02080 BY THE ABATEMENT CONTRACTOR.

COMPREHENSIVE RENOVATION VA 3-2 MARSHALL COURTS

NEWPORT NEWS, VA

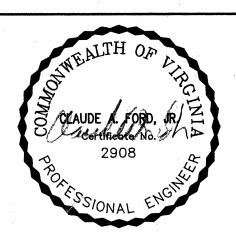

T.L.M. Designed: D.P.M.

C.A.F. Checked AS NOTED Scale

JANUARY 31, 1992


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Project No: 90006

BUILDING TYPE D2 -FLOOR PLANS AND DIAGRAMS (DEMOLITION & NEW WORK / **HANDICAPPED** CONVERSION)

Sheet No:



### ♦ DEMOLITION NOTES

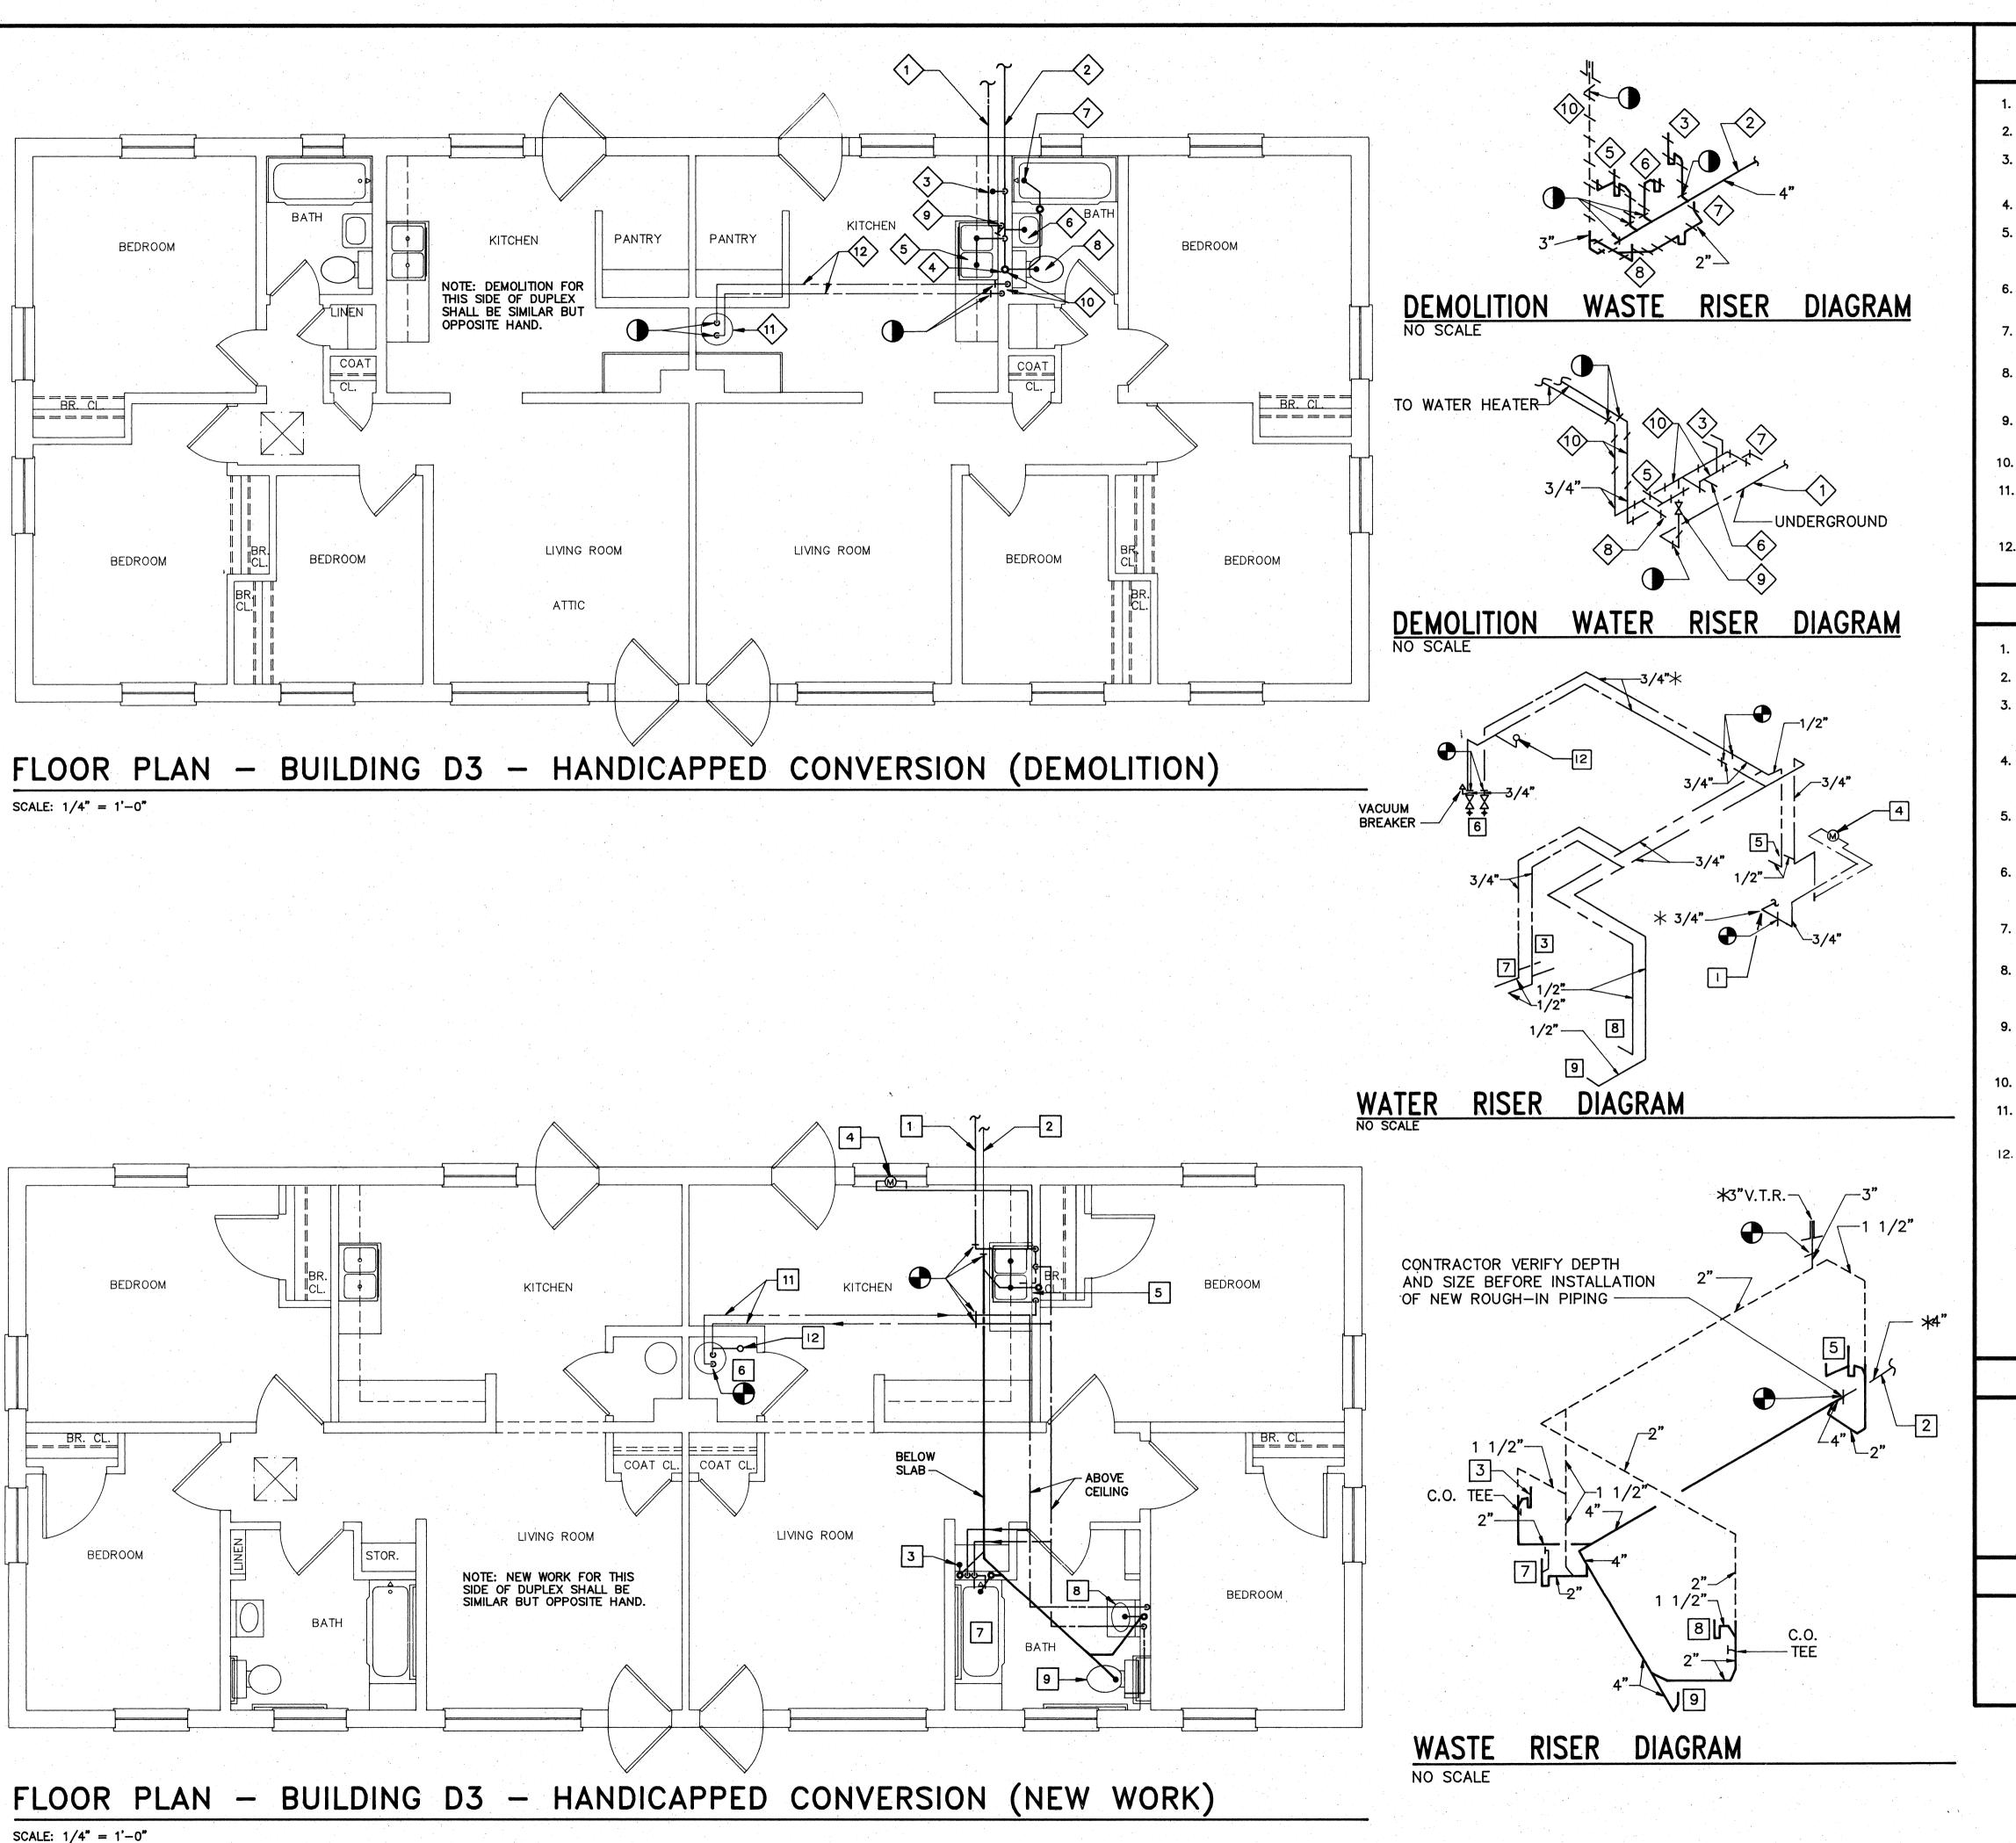- 1. 3/4" COLD WATER SERVICE TO REMAIN.
- 2. 4" UNDERGROUND SANITARY SEWER TO REMAIN.
- 3. REMOVE HOT, AND COLD WATER HOSE BIBBS, WATER AND DRAIN ROUGH—IN PIPING, AND STANDPIPE SERVING CLOTHES WASHER.
- 4. 3" VENT STACK TO REMAIN.
- 5. REMOVE 2—COMPARTMENT KITCHEN SINK FROM CABINET. STORE FOR RE—USE. REMOVE P—TRAP, SUPPLIES, AND WATER AND DRAIN ROUGH—IN PIPING IN WALL TO EXTENT SHOWN.
- 6. REMOVE WALL-MOUNTED LAVATORY, HANGER BRACKET AND WATER AND DRAIN ROUGH-IN PIPING IN WALL TO EXTENT SHOWN.
- 7. REMOVE CAST IRON BATHTUB, FAUCET, SHOWER HEAD, TUB WASTE, AND WATER AND DRAIN ROUGH—IN PIPING TO EXTENT SHOWN.
- 8. REMOVE FLUSH TANK WATER CLOSET AND WATER SUPPLY PIPING IN WALL TO EXTENT SHOWN. REMOVE CLOSET FLANGE AND CAP WASTE PIPING BELOW FLOOR. PATCH FLOOR TO MATCH SURROUNDING FINISH.
- 9. REMOVE 3/4" VALVE IN RISER BELOW SINK. CAP WATER SERVICE TEMPORARILY FOR CONNECTION OF NEW WORK.
- 10. REMOVE HOT AND COLD WATER PIPING IN WALL FROM FIXTURES TO EXTENT SHOWN.
- 11. REMOVE GAS FIRED WATER HEATER. SEE MECHANICAL DRAWINGS FOR GAS PIPE DEMOLITION. CAP HOT AND COLD WATER PIPING TEMPORARILY FOR CONNECTION OF NEW WORK
- 12. REMOVE ASBESTOS PIPE INSULATION FROM EXISTING WATER SUPPLY PIPING IN ATTIC AND KITCHEN PER SPECIFICATION SECTION 02080.

### ☐ NEW WORK NOTES

- 1. EXISTING 3/4" COLD WATER SERVICE.
- . EXISTING 4" UNDERGROUND SANITARY SEWER.
- B. PROVIDE RECESSED WASHER CONNECTION BOX AND HOT WATER, COLD WATER AND DRAIN ROUGH—IN PIPING AS INDICATED. SEE FIXTURE CONNECTION SCHEDULE (P-4)
- PROVIDE 3/4" METER IN ACCESS PANEL. SEE ARCHITECTURAL DRAWINGS FOR LOCATION. SEE WATER RISER DIAGRAM SHEET P-10. EXTEND PIPING FROM METER TO EXISTING PIPING AS INDICATED.
- 5. RE-INSTALL EXISTING 2-COMPARTMENT KITCHEN SINK TO NEW COUNTERTOP WITH NEW SCREWS AND CLIPS. PROVIDE P-TRAP, ANGLE SUPPLIES, HOT AND COLD WATER ROUGH-IN, DRAIN ROUGH-IN AND MAKE FINAL CONNECTION TO SINK.
- PROVIDE VALVES AND FINAL CONNECTIONS TO WATER HEATER/HEATING UNIT AS INDICATED ON MECHANICAL DRAWINGS. MODIFY EXISTING PIPING AS NECESSARY TO SUIT ROUGH—IN REQUIREMENTS OF NEW UNIT.
- 7. PROVIDE 5'-0" LONG BATHTUB, SHOWER FAUCET, TUB WASTE, AND HOT WATER AND COLD WATER ROUGH-IN PIPING. SEE FIXTURE CONNECTION SCHEDULE (P-3).
- 8. PROVIDE WALL-MOUNTED LAVATORY, FAUCET, P-TRAP, ANGLE SUPPLIES, HOT WATER AND COLD WATER ROUGH-IN PIPING AND DRAIN ROUGH-IN PIPING. SEE FIXTURE CONNECTION SCHEDULE (P-2).
- 9. PROVIDE 18" HIGH FLOOR MOUNTED, FLUSH TANK WATER CLOSET, SEAT ANGLE SUPPLY, COLD WATER ROUGH—IN AND DRAIN ROUGH—IN PIPING. SEE FIXTURE CONNECTION SCHEDULE (P—11).
- 10. EXISTING 3" VENT THRU ROOF.


IN ACCORDANCE WITH NFPA 13.

- PROVIDE PIPE INSULATION FROM WATER HEATER CONNECTION TO KITCHEN AND BATH FIXTURE CONNECTIONS.
- PROVIDE 1/2" UPRIGHT SPRINKLER HEAD, 3/4" CHECK VALVE AND 3/4" PIPING FROM SPRINKLER HEAD TO EXISTING COLD WATER PIPING. INSTALL

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COMPREHENSIVE RENOVATION OF VA 3-2 MARSHALL COURTS

NEWPORT NEWS, VA

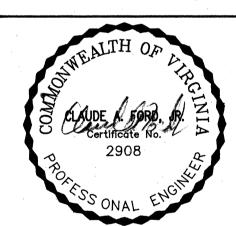

T.L.M.

### NOTES THIS SHEET

- 1. FOR LEGEND SEE SHEET P4.
- 2. FOR GENERAL NOTES, SEE SHEET P4.
- 3. FOR FIXTURE CONNECTION SCHEDULE, SEE SHEET P6.
- 4. FOR WATER HEATER/HEATING UNIT DETAIL, SEE SHEET M19.

### ABATEMENT NOTE

PLUMBING PIPE INSULATION HAS BEEN TESTED AND IS KNOWN TO CONTAIN ASBESTOS MATERIALS. ALL PIPES INDICATED FOR REMOVAL SHALL BE ABATED OF ASBESTOS MATERIAL IN ACCORDANCE WITH SPECIFICATION SECTION 02080 BY THE ABATEMENT CONTRACTOR.

Drawn: D.P.M.

Checked: C.A.F.

Scale: AS NOTED

Date: JANUARY 31, 1992

File No:


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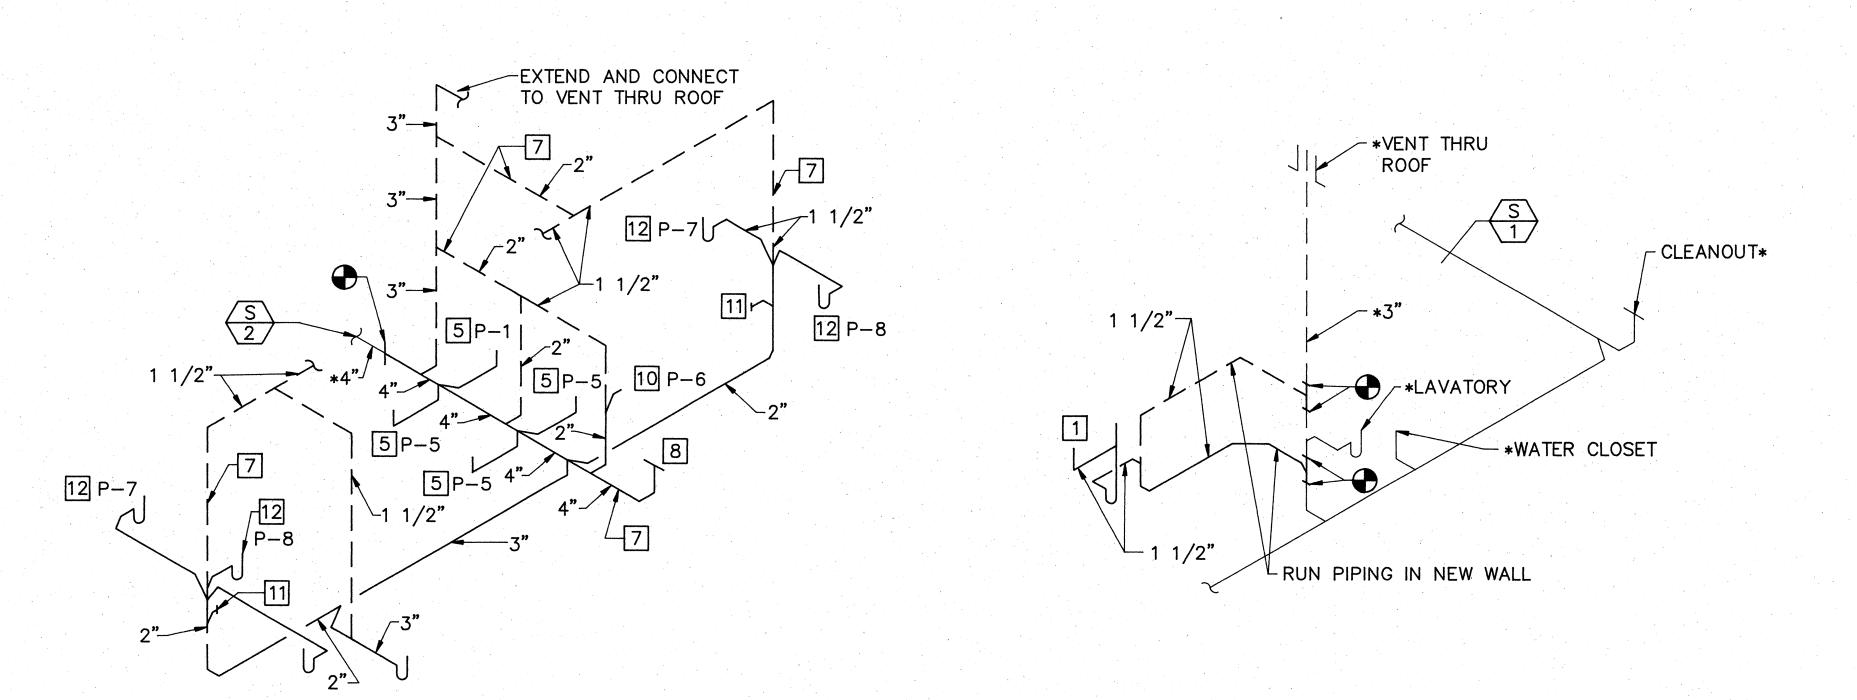
Project No: 90006

BUILDING TYPE D3 FLOOR PLANS
(DEMOLITION &
NEW WORK /
HANDICAPPED
CONVERSION)


Sheet No:

P12
Sheets




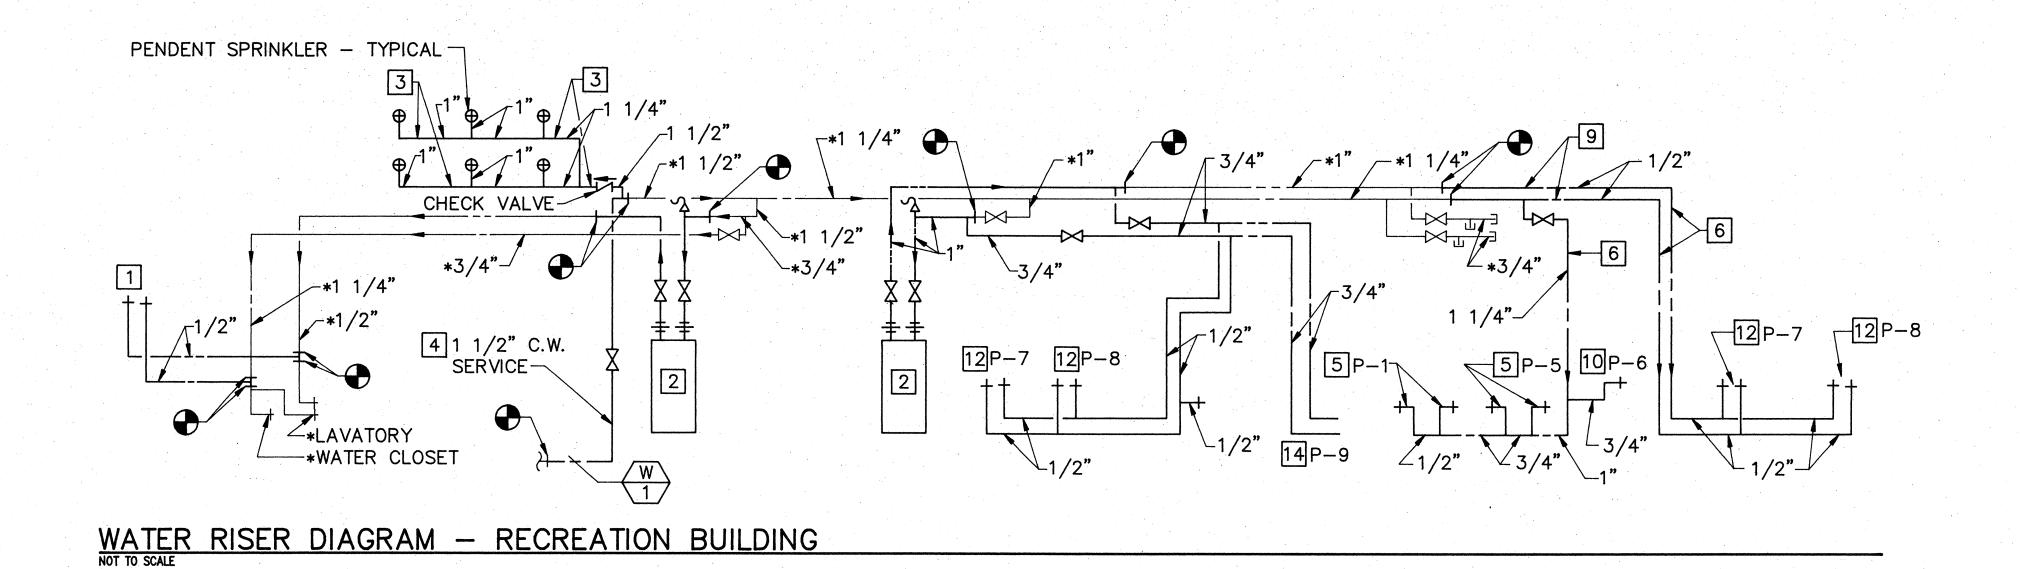

## WASTE RISER DIAGRAMS RECREATION BUILDING

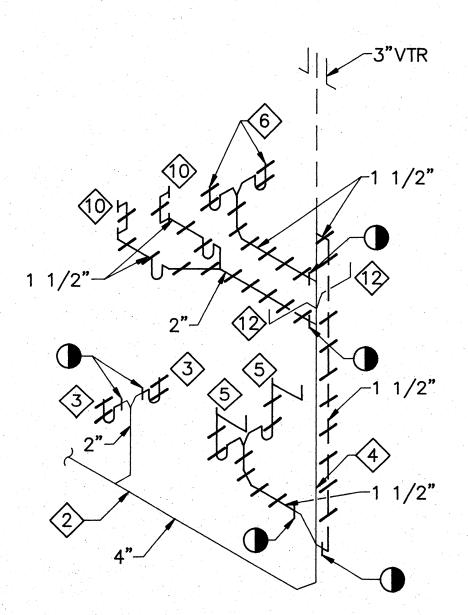

WASTE DEMOLITION DIAGRAM — BUILDING D4
NOT TO SCALE

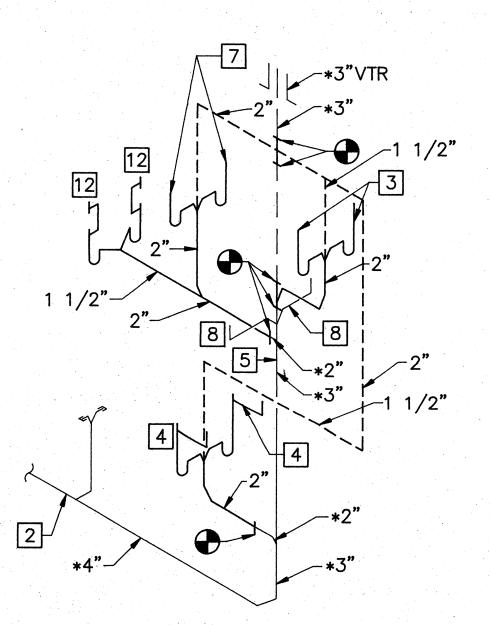

WASTE RISER DIAGRAM — BUILDING D4
NOT TO SCALE

### NOTES THIS SHEET


- 1. FOR LEGEND, SEE SHEET P4.
- 2. FOR GENERAL NOTES, SEE SHEET P4.
- 3. FOR FIXTURE CONNECTION SCHEDULE, SEE SHEET P6.
- 4. FOR WATER HEATER/HEATING UNIT SCHEDULE, SEE SHEET M19.
- 6. SEE SHEETS P9 & P20 FOR PLUMBING FLOOR PLAN BUILDING D4.





COMPREHENSIVE RENOVATION OF VA 3-2 MARSHALL COURTS

NEWPORT NEWS, VA

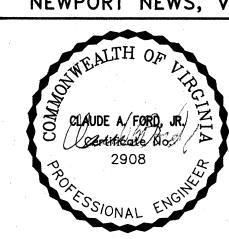


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Date	JANUARY 31	199
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Project No: 90006

RECREATION BUILDING & TYPE D4 RISER DIAGRAMS


Sheet No:

P14

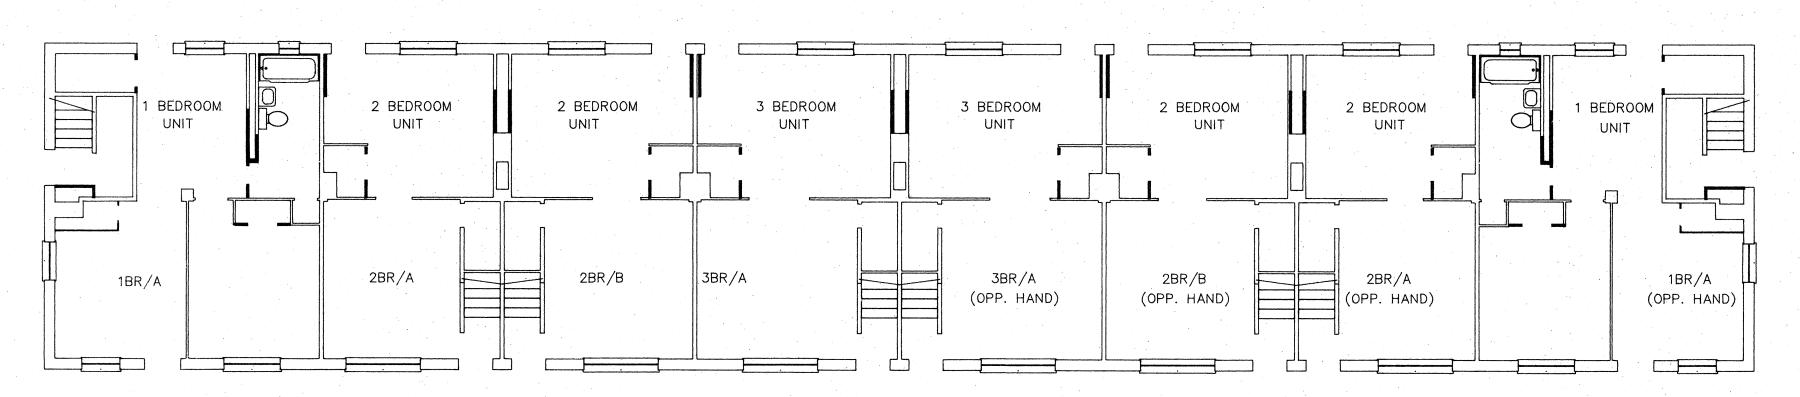


### FIRST FLOOR PLAN - BUILDING "B"

SCALE: 1/8" = 1'-0"

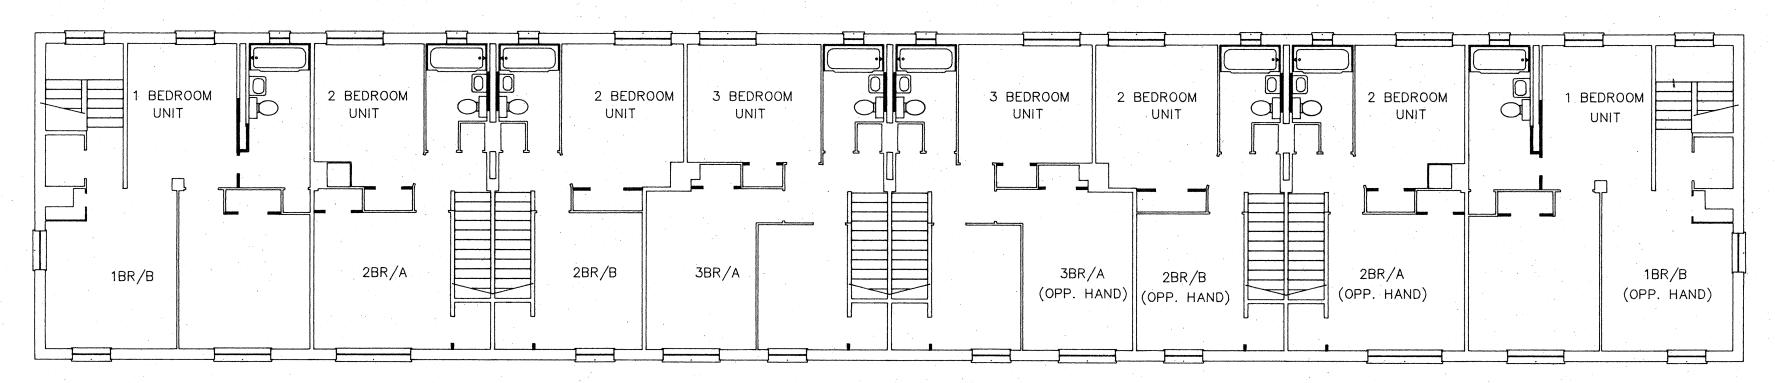


### SECOND FLOOR PLAN - BUILDING "B"


SCALE: 1/8" = 1'-0"

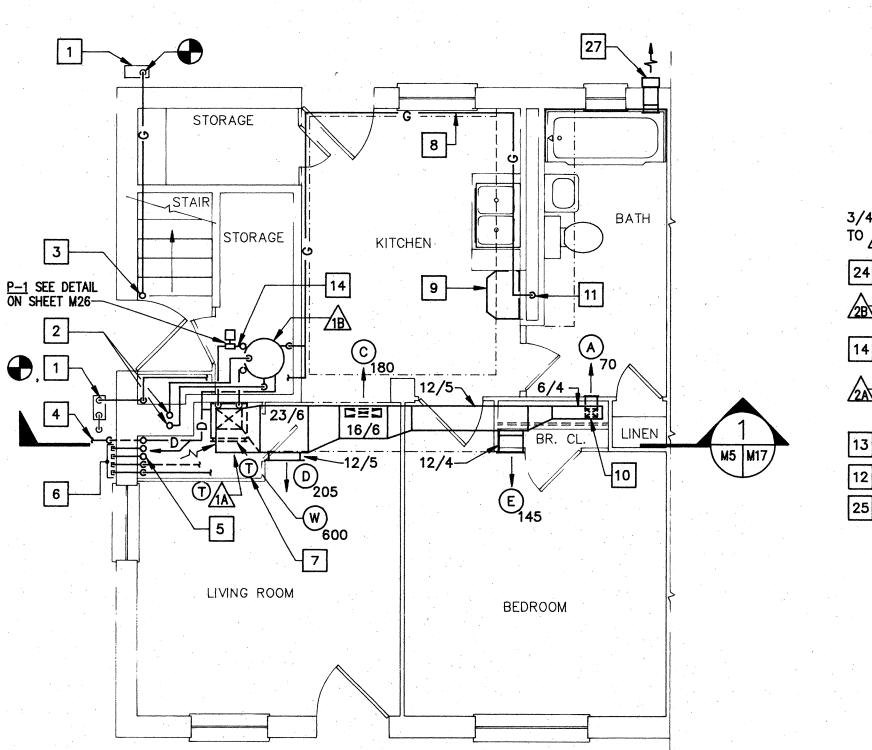

1ST FL. - UNIT 1BR/A SCALE: 1/4" = 1'-0"

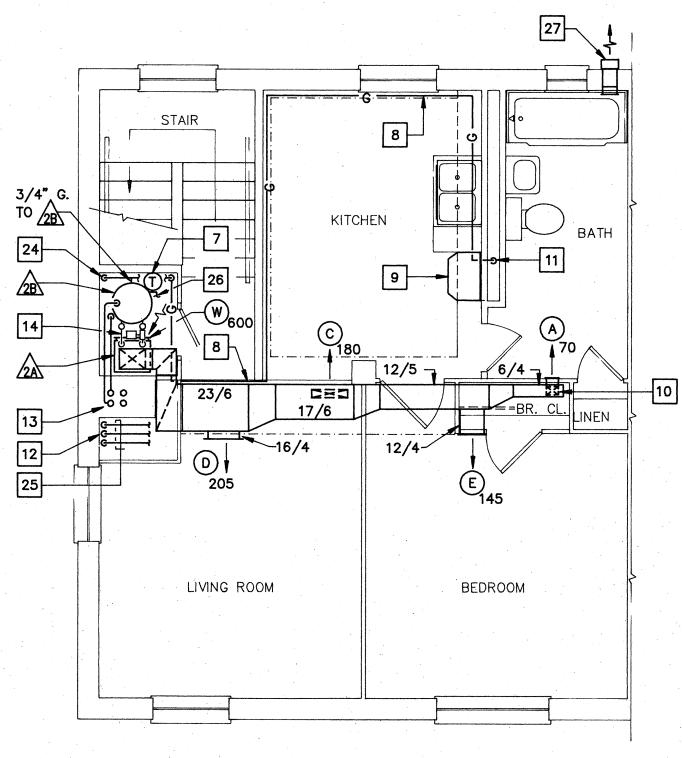

2ND FL. - UNIT 1BR/B SCALE: 1/4" = 1'-0"

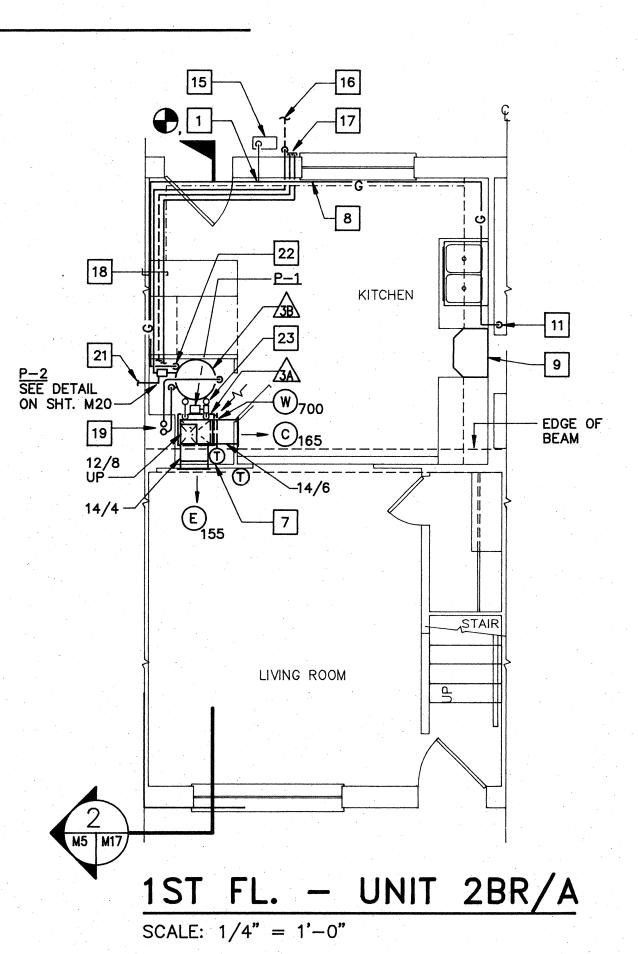


### NEW WORK NOTES

- CONNECT 3/4" GAS PIPING TO EXISTING GAS METER AT POINT INDICATED.
- 2. 2" PLASTIC FLUE AND INTAKE PIPING UP IN EXISTING CHIMNEY. SEE 2ND FLOOR - UNIT 1BR/B FLOOR PLAN FOR CONTINUATION. SEE DETAIL ON SHEET A7.
- 3. 3/4" GAS PIPING UP TO SECOND FLOOR ALONG WALL. SEE 2ND FLOOR - UNIT 1BR/B FLOOR PLAN FOR CONTINUATION.
- 3/4" CONDENSATE DRAIN PIPING UNDERGROUND TO DRY WELL. SEE DETAIL ON SHEET M20.
- 3/4" DRAIN, 3/8" O.D. RL AND 5/8" O.D. RS UP. SEE 2ND FLOOR UNIT 1BR/B FLOOR PLAN FOR CONTINUATION.
- 6. CAP 2 EACH 3/8" O.D. RL AND 2 EACH 5/8" O.D. RS AT EXTERIOR FACE OF WALL.
- 7. PROVIDE WALL MOUNTED TEMPERATURE CONTROLLER. SEE DETAIL ON SHEET M19.
- 8. RUN 3/4" GAS LINE IN SOFFIT.
- 9. PROVIDE STAINLESS STEEL DUCTLESS RANGE EXHAUST HOOD WITH 2 SPEED FAN AND LAMP.
- 10. TURN DUCT DOWN UNDER BEAM. BOTTOM OF BEAM IS 7'-2".
- 3/4" GAS DOWN IN CHASE. CONNECT TO EXISTING GAS RANGE STOVE. PROVIDE GAS COCK AND FLEXIBLE PIPE CONNECTOR.
- 12. 3/4" CONDENSATE DRAIN, 3/8" O.D. RL AND 5/8" O.D. RS PIPING DOWN TO 1ST FLOOR. SEE 1ST FL - UNIT 1BR/A FOR CONTINUATION.
- 13. 2" PLASTIC FLUE AND INTAKE PIPING UP IN EXISTING CHIMNEY. TERMINATE 36" ABOVE ROOF LINE. SEE DETAIL SHEET A7.
- 14. 3/4" HS AND HR, TO FAN COIL UNIT. SEE DETAIL ON SHEET M19.
- 15. EXISTING GAS METER.
- 3/4" PUMPED CONDENSATE DRAIN PIPING UNDERGROUND TO DRY WELL. SEE DETAIL ON SHEET M17.
- 17. CAP 3/8" O.D. RL AND 5/8" O.D. RS AT EXTERIOR FACE OF WALL. SEE DETAIL ON SHEET M20.
- 18. 3/4" PUMPED CONDENSATE DRAIN, 3/8" O.D. RL, 5/8" O.D. RS AND 3/4" GAS IN SOFFIT.
- 19. 2" PLASTIC FLUE AND INTAKE PIPING UP IN EXISTING CHIMNEY. SEE 2ND FL. - UNIT 2BR/A FLOOR PLAN FOR CONTINUATION.
- 20. 2" PLASTIC FLUE AND INTAKE PIPING UP IN EXISTING CHIMNEY. TERMINATE 36" ABOVE ROOF LINE. SEE DETAIL ON SHEET A7.
- 21. 3/4" CONDENSATE DRAIN FROM ADJACENT UNIT TO CONDENSATE PUMP. SEE DETAIL ON SHEET M20.
- 22. 3/4" GAS PIPE DOWN. CONNECT TO WATER HEATER.
- 23. 3/4" HS & HR PIPING TO HOT WATER COIL. SEE DETAIL ON SHEET M19.
- 24. 3/4" GAS DOWN.
- 25. 3/4" CONDENSATE DRAIN, 3/8" O.D. RL AND 5/8" O.D. RS PIPING RUN BEHIND METAL ENCLOSURE AND CONNECT TO FAN COIL UNIT.
- 26. 3/4" D. CONNECT TO FAN COIL UNIT DRAIN. SEE DETAIL ON SHEET M19.
- 27. EF-6, SEE DETAIL ON SHEET M-17.

### GENERAL NOTES

- 1. REFER TO SHEET M18 FOR LEGEND.
- ENLARGED 1/4" FLOOR PLANS INDICATE TYPICAL WORK FOR ALL SIMILAR AND OPPOSITE HAND UNITS. REFER TO FLOOR PLANS FOR UNIT TYPES.

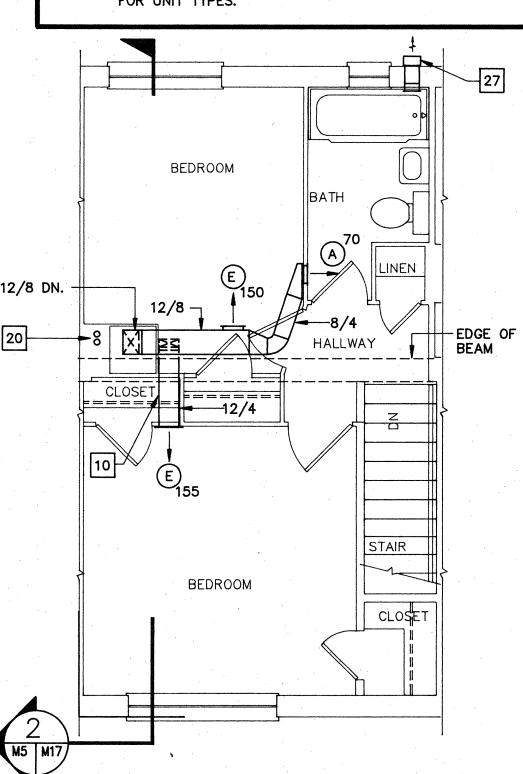

2ND FL. - UNIT 2BR/A


SCALE: 1/4" = 1'-0"



COMPREHENSIVE RENOVATION

VA 3-2 MARSHALL COURTS

NEWPORT NEWS, VA

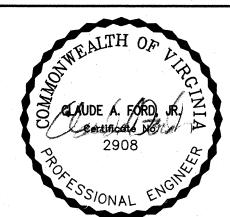


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Project No: 90006


BUILDING TYPE B -FLOOR PLANS (NEW WORK)

Sheet No:

M5 Sheets

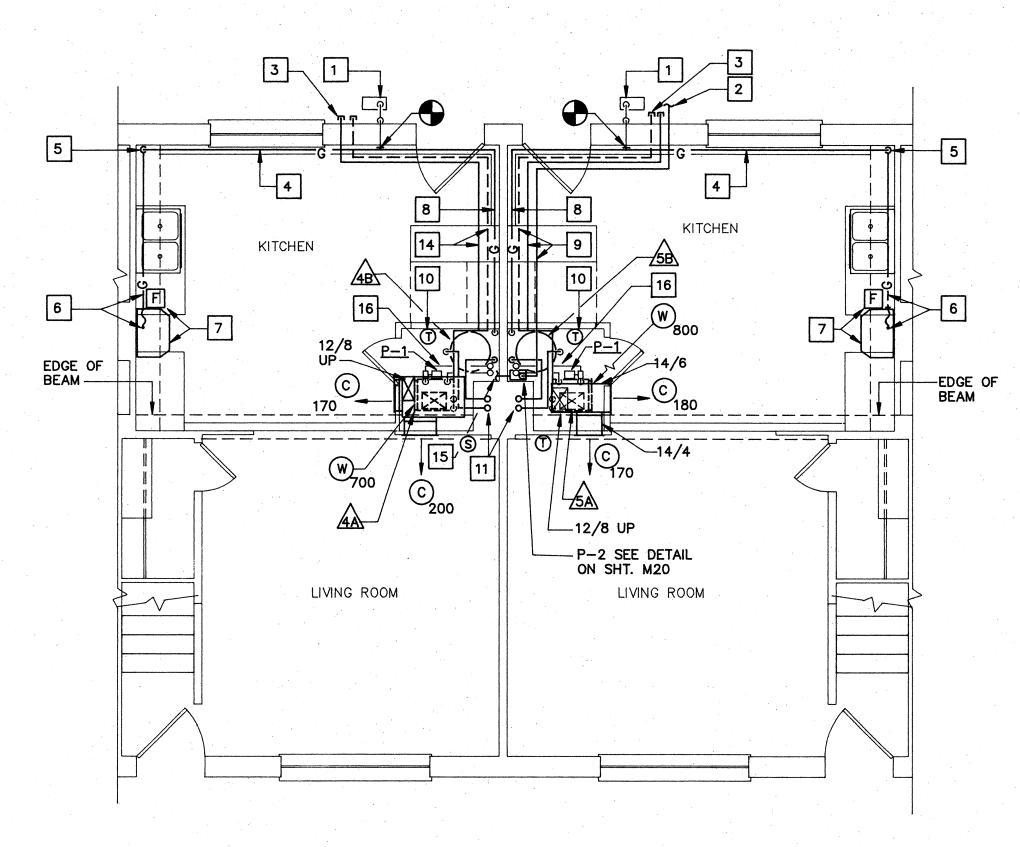

1ST FL. - UNIT 2BR/B & 3BR/A

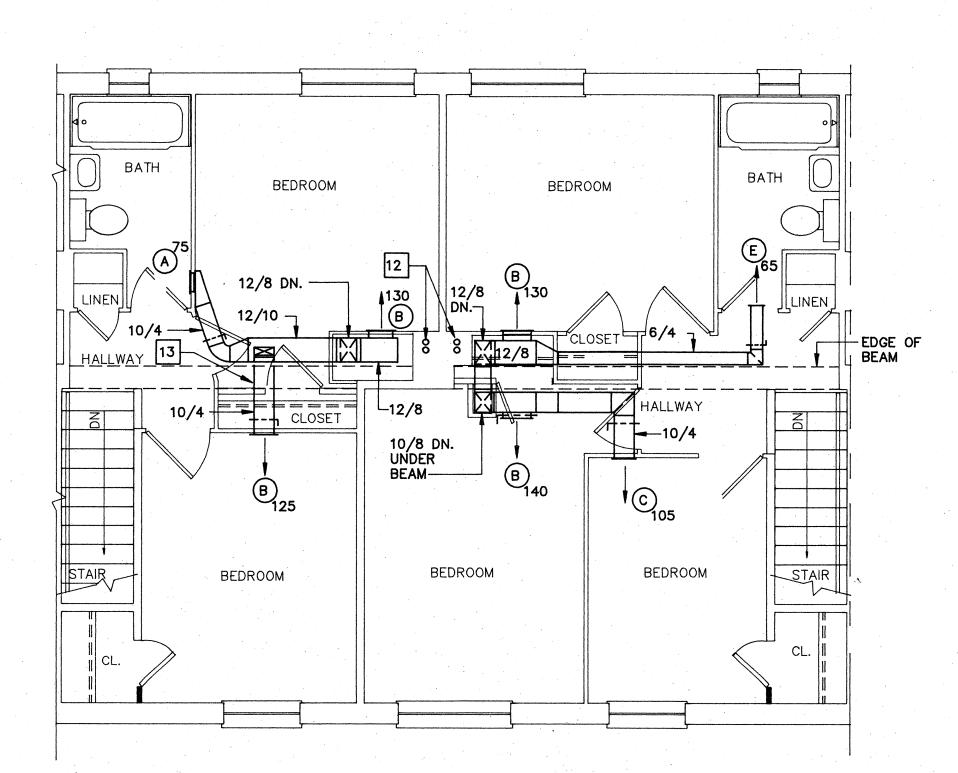

2ND FL. - UNIT 2BR/B & 3BR/A

SCALE: 1/4" = 1'-0"

### ☐ NEW WORK NOTES

- 1. CONNECT 3/4" GAS PIPING TO EXISTING GAS PIPING AT POINT INDICATED.
- 2. 3/4" CONDENSATE DRAIN PIPING UNDERGROUND TO DRY WELL. SEE DETAIL ON SHEET M26.
- 3. CAP 3/8" O.D. RL AND 5/8" O.D. RS AT EXTERIOR FACE OF WALL. SEE DETAIL ON SHEET M20.
- 4. RUN 3/4" GAS PIPING IN SOFFIT.
- 5. 3/4" GAS DN. IN CORNER.
- 6. RUN 3/4" GAS PIPING ALONG WALL BEHIND COUNTER. CONNECT TO EXISTING GAS RANGE STOVE. PROVIDE GAS COCK AND FLEXIBLE PIPE CONNECTOR.
- 7. PROVIDE STAINLESS STEEL DUCTLESS RANGE EXHAUST HOOD. 2 SPEED FAN AND LAMP. MOUNT UNDER CABINET.
- 8. RUN 3/4" GAS PIPING IN SOFFIT AND CONNECT TO WATER HEATER.
- 9. RUN 3/8" O.D. RL, 5/8" O.D. RS AND 3/4" PUMPED CONDENSATE DRAIN PIPING IN SOFFIT AT CEILING. SEE DETAIL ON SHEET M20.
- 10. PROVIDE WALL MOUNTED SEE DETAIL ON SHEET M19.
- TEMPERATURE CONTROLLER.
- 11. 2" PLASTIC FLUE AND INTAKE PIPING UP
  IN EXISTING CHIMNEY. SEE 2ND FL. UNIT 2BR/B AND 3BR/A
  FLOOR PLAN FOR CONTINUATION.
- 12. 2" PLASTIC FLUE AND INTAKE PIPING UP IN EXISTING CHIMNEY. TERMINATE 36" ABOVE ROOF LINE. SEE DETAIL ON SHEET A7.
- 13. TURN 10"x 4" DUCT DOWN UNDER BEAM. HOLD TIGHT TO UNDERSIDE OF BEAM.
- 14. RUN 3/8" O.D. RL & 5/8" O.D. RS IN SOFFIT AT CEILING.
- 15. 3/4" CONDENSATE DRAIN TO CONDENSATE PUMP.
- 16. 3/4" HS & HR PIPING TO HOT WATER COIL. SEE DETAIL ON SHEET M19.
- 17. EF-6, SEE DETAIL ON SHEET M-17.

### GENERAL NOTES

- 1. REFER TO SHEET M18 FOR LEGEND.
- 2. ENLARGED 1/4" FLOOR PLANS INDICATE TYPICAL WORK FOR ALL SIMILAR AND OPPOSITE HAND UNITS. REFER TO FLOOR PLANS FOR UNIT TYPES.

### ABATEMENT NOTE


1. MECHANICAL EXPOSED PAINTED DUCTWORK HAS BEEN TESTED AND IS KNOWN TO CONTAIN LEAD BASED PAINT. ALL EXPOSED DUCTWORK INDICATED FOR REMOVAL SHALL BE REMOVED IN ACCORDANCE WITH SPECIFICATION SECTION 02090 BY THE ABATEMENT CONTRACTOR.



COMPREHENSIVE RENOVATION OF

VA 3-2 MARSHALL COURTS

NEWPORT NEWS, VA

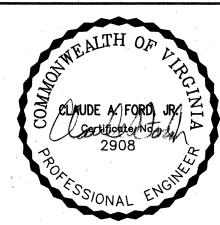

Designed: MAC

Drawn: BKS

Checked: CAF

Scale: NOTED

Date: JANUARY **3**1, 1992


File No:

Project No: 90006

BUILDING
TYPE B —
FLOOR PLANS
(NEW WORK)


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M6

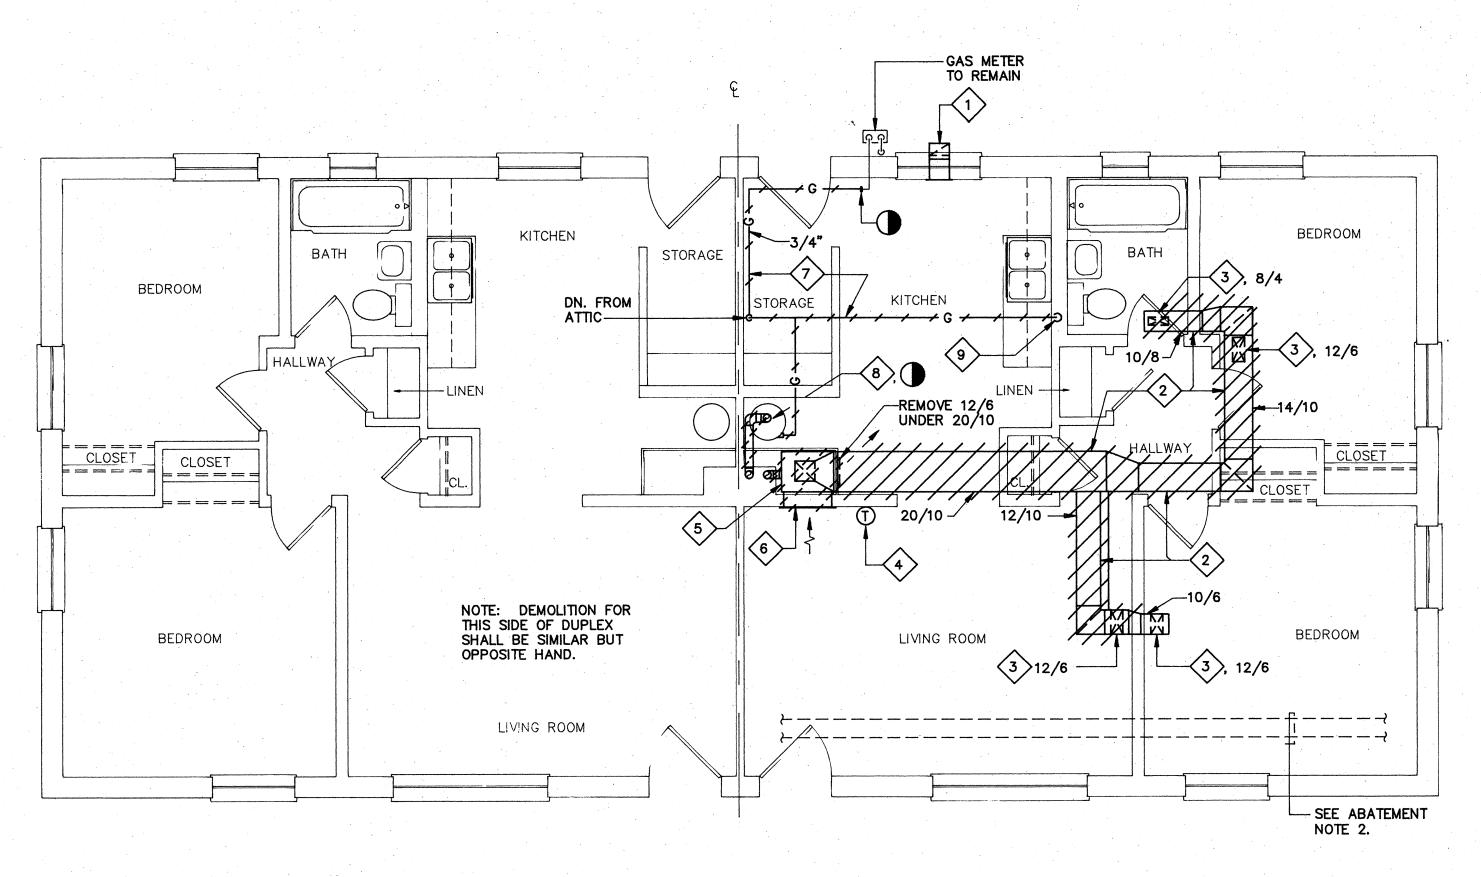

### FLOOR PLAN - BUILDING D2 (DEMOLITION)

SCALE: 1/4" = 1'-0"

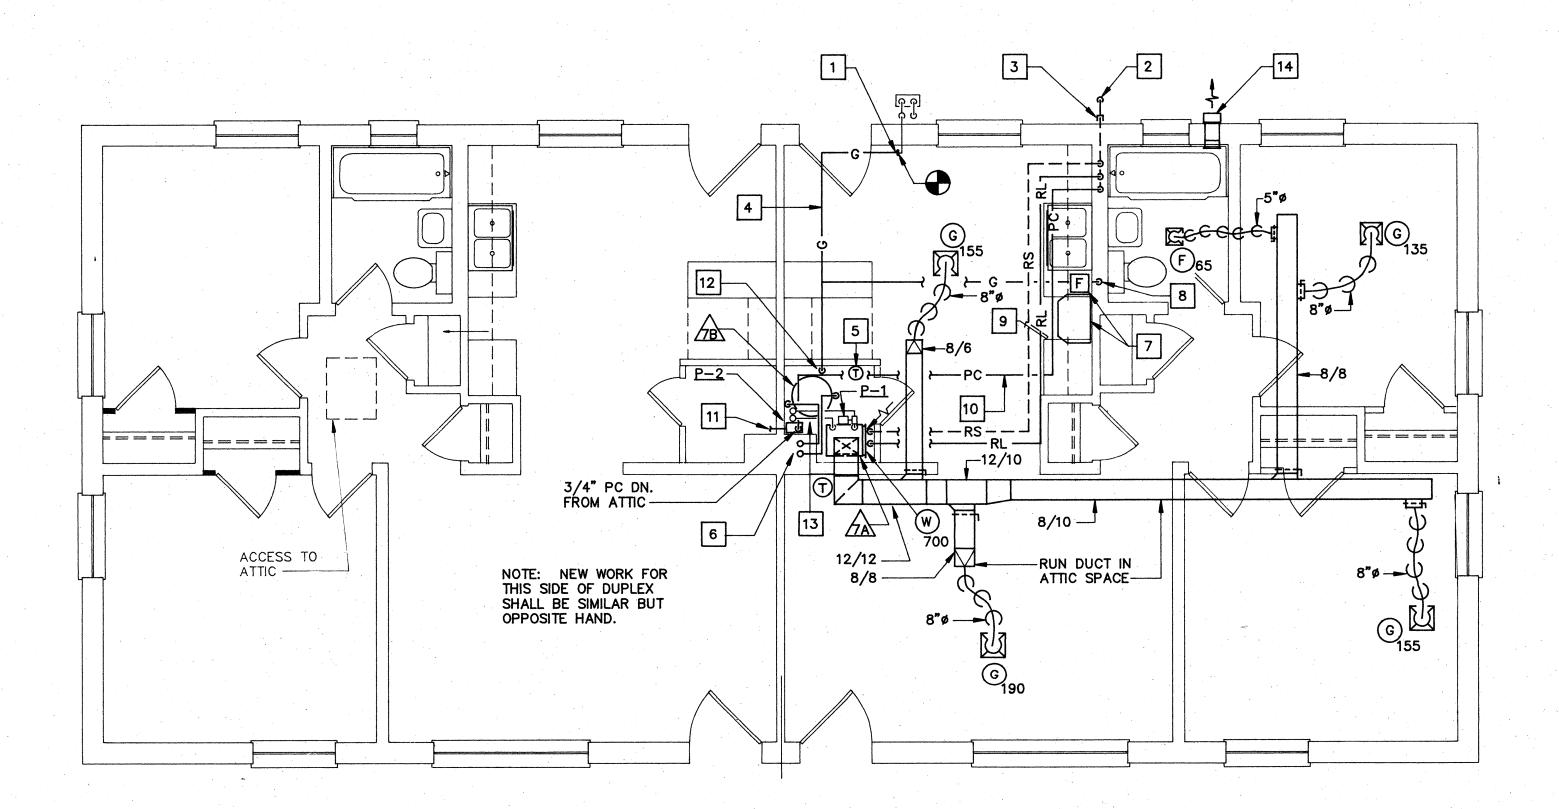

### FLOOR PLAN - BUILDING D2 (NEW WORK)

SCALE: 1/4" = 1'-0"

### O DEMOLITION NOTES

- . REMOVE COMBUSTION AIR INTAKE GRILLE & DUCT.
- 2. REMOVE SUPPLY DUCTWORK IN ATTIC SPACE. DUCT SIZES ARE APPROXIMATE.
- 3. REMOVE SUPPLY REGISTER SIZED AS MARKED.
- 4. REMOVE WALL MOUNTED THERMOSTAT AND WIRING.
- 5. REMOVE FURNACE & FLUE COMPLETE WITH ASSOCIATED EQUIPMENT.
- 6. REMOVE 24/14 RETURN REGISTER.
- . REMOVE 3/4" GAS PIPING AS INDICATED.
- 8. REMOVE 3/4" GAS PIPING & FLUE COMPLETE FROM DOMESTIC WATER HEAER.
- 9. REMOVE 3/4" GAS PIPING DOWN IN CHASE AND COMPLETE FROM RANGE.

### ☐ NEW WORK NOTES

- 1. CONNECT 3/4" GAS PIPING TO EXISTING 3/4" GAS PIPING AT POINT INDICATED.
- 2. 3/4" CONDENSATE DRAIN PIPING UNDERGROUND TO DRYWELL. SEE DETAIL ON SHEET M20.
- 3. CAP 3/8" O.D. RL AND 5/8" O.D. RS AT EXTERIOR FACE OF WALL. SEE DETAIL ON SHEET M17.
- 4. RUN 3/4" GAS PIPING IN ATTIC SPACE.
- 5. PROVIDE WALL MOUNTED TEMPERATURE CONTROLLER. SEE DETAIL ON SHEET M19.
- 6. 2" PLASTIC FLUE AND INTAKE PIPING UP IN EXISTING CHIMNEY. TERMINATE 36" ABOVE ROOF LINE. SEE DETAIL ON SHEET A7.
- 7. PROVIDE STAINLESS STEEL DUCTLESS RANGE EXHAUST HOOD 2—SPEED FAN AND LAMP. MOUNT UNDER CABINET.
- 8. 3/4" GAS PIPING TURN DOWN IN WALL. CONNECT TO EXISTING GAS RANGE STOVE. PROVIDE GAS COCK AND FLEXIBLE PIPE CONNECTOR.
- 9. RUN 3/8" O.D. RL AND 5/8" O.D. RS ABOVE CEILING. TURN DOWN ALONG WALL AND CONNECT TO FAN COIL UNIT.
- 10. RUN 3/4" PUMPED CONDENSATE DRAIN IN ATTIC SPACE.
- 11. 3/4" CONDENSATE DRAIN FROM ADJACENT UNIT TO CONDENSATE PUMP. SEE DETAIL ON SHEET M20.
- 12. 3/4" GAS PIPE DOWN CONNECT TO WATER HEATER.
- 13. 3/4" HS & HR PIPING TO HOT WATER COIL. SEE DETAIL ON SHEET M19.
- 14. EF-6, SEE DETAIL ON SHEET M17.

### GENERAL NOTES

- 1. REFER TO SHEET M18 FOR LEGEND.
- 2. ENLARGED 1/4" FLOOR PLANS INDICATE TYPICAL WORK FOR ALL SIMILAR AND OPPOSITE HAND UNITS. REFER TO FLOOR PLANS FOR UNIT TYPES.

### ABATEMENT NOTES


- MECHANICAL EXPOSED PAINTED DUCTWORK HAS BEEN TESTED AND IS KNOWN TO CONTAIN LEAD BASED PAINT. ALL EXPOSED DUCTWORK INDICATED FOR REMOVAL SHALL BE REMOVED IN ACCORDANCE WITH SPECIFICATION SECTION 02090 BY THE ABATEMENT CONTRACTOR.
- 2. REMOVE ASBESTOS INSULATION FROM ABANDONED HYDRONIC HEATING PIPING IN ATTIC PER SPECIFICATION SECTION 02080. PIPING SHALL REMAIN IN ATTIC AND SHALL BE ENCAPSULATED PER SECTION 02080. WORK SHALL BE PERFORMED BY THE ABATEMENT CONTRACTOR.





COMPREHENSIVE RENOVATION OF VA 3-2 MARSHALL COURTS

NEWPORT NEWS, VA

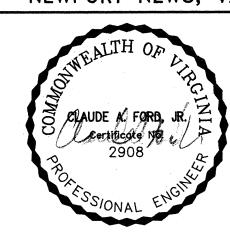

Designed: MAC

Drawn: BKS

Checked: CAF

Scale: NDTED

Date: JANUARY **3**1, 1992


File No:

Project No: 90006

BUILDING
TYPE D2 FLOOR PLANS
(DEMOLITION &
NEW WORK)


Sheet No

M7 Sheets

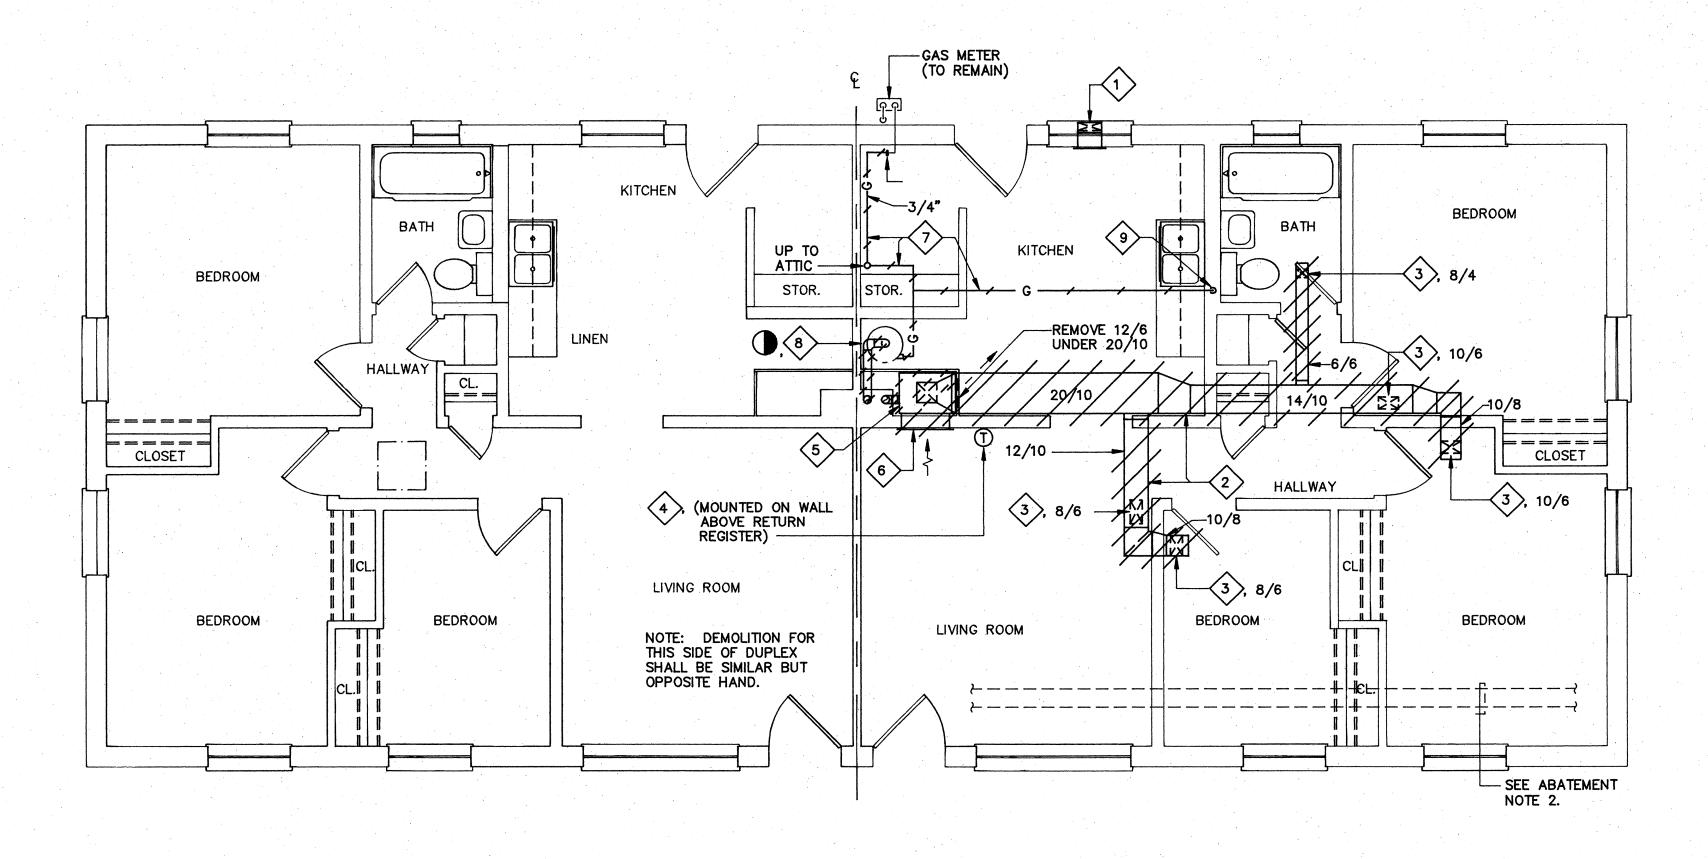

### FLOOR PLAN - BUILDING D3 (DEMOLITION)

SCALE: 1/4" = 1'-0"

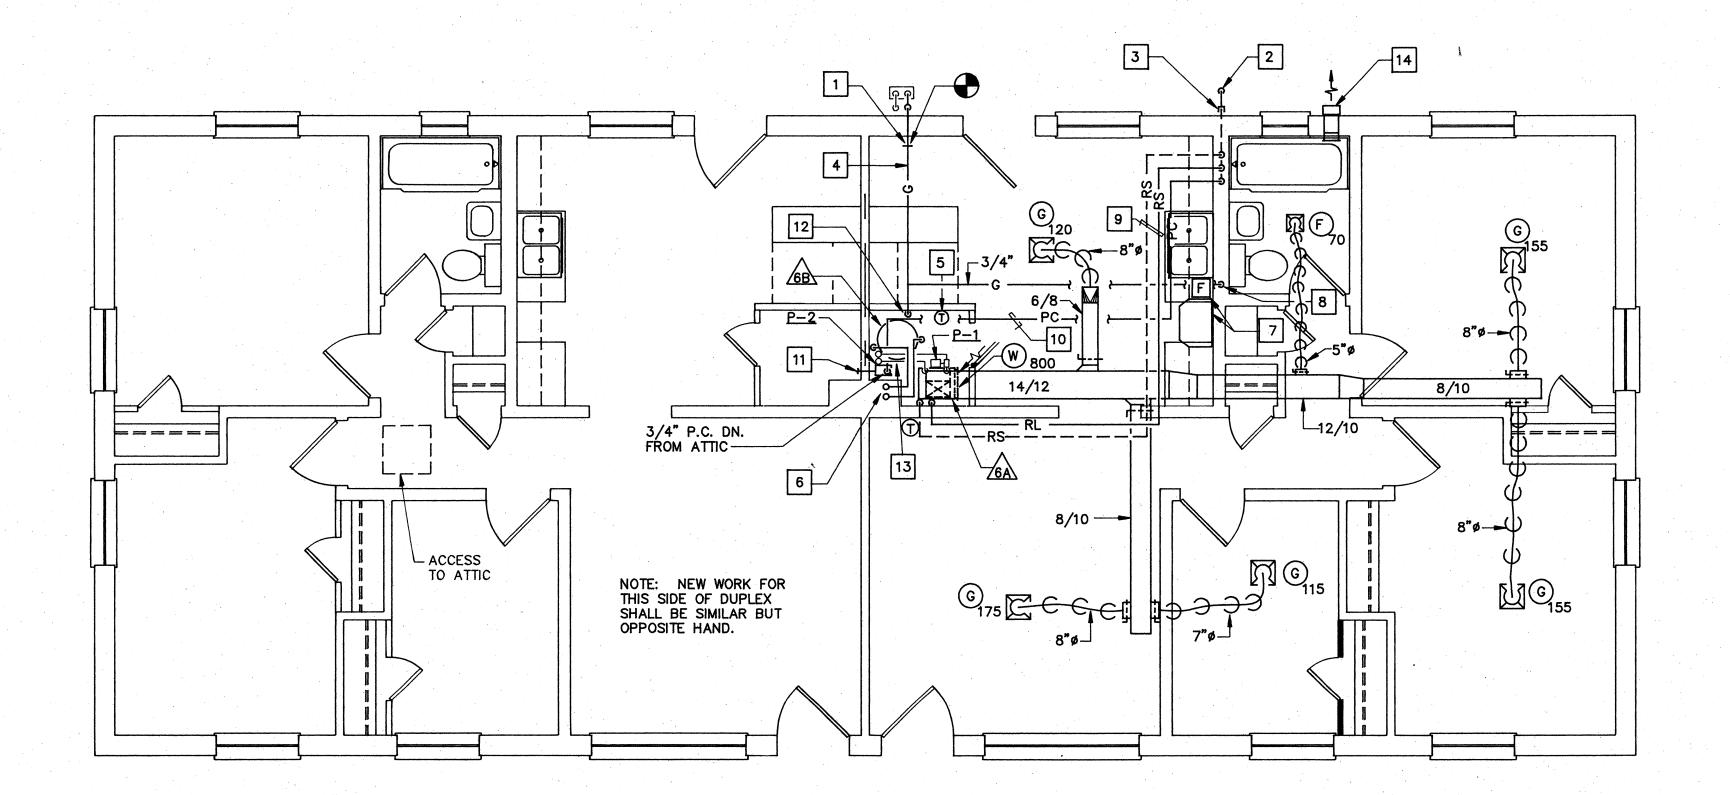

### FLOOR PLAN - BUILDING D3 (NEW WORK)

SCALE: 1/4" = 1'-0"

### □ DEMOLITION NOTES

- 1. REMOVE COMBUSTION AIR INTAKE DUCT AND GRILLE.
- 2. REMOVE SUPPLY DUCTWORK IN ATTIC SPACE DUCT SIZES ARE APPROXIMATE.
- 3. REMOVE SUPPLY REGISTER SIZED AS MARKED.
- 4. REMOVE WALL MOUNTED THERMOSTAT AND WIRING COMPLETE.
- 5. REMOVE FURNACE & FLUE COMPLETE WITH ASSOCIATED EQUIPMENT.
- 6. REMOVE 24/14 RETURN REGISTER.
- 7. REMOVE 3/4" GAS PIPING AS INDICATED.
- 8. REMOVE 3/4" GAS PIPING & FLUE COMPLETE FROM DOMESTIC WATER
- 9. REMOVE 3/4" GAS PIPING DN. IN WALL TO GAS RANGE.

### ☐ NEW WORK NOTES

- CONNECT 3/4" GAS PIPING TO EXISTING 3/4" GAS PIPING AT POINT
- 2. 3/4" CONDENSATE DRAIN PIPING UNDERGROUND TO DRYWELL. SEE DETAIL ON SHEET M20.
- 3. CAP 3/8" O.D. RL & 5/8" O.D. RL AT EXTERIOR FACE OF WALL. SEE DETAIL ON SHEET M17.
- 4. RUN 3/4" GAS PIPING IN ATTIC SPACE.
- PROVIDE WALL MOUNTED TEMPERATURE CONTROLLER. SEE DETAIL ON SHEET MI9.
- 6. 2" PLASTIC FLUE AND INTAKE PIPING UP IN EXISTING CHIMNEY. TERMINATE 36" ABOVE ROOF LINE. SEE DETAIL
- 7. PROVIDE STAINLESS STEEL DUCTLESS RANGE EXHAUST HOOD 2—SPEED FAN AND LAMP. MOUNT UNDER CABINET.
- 8. 3/4" GAS PIPING TURN DOWN IN WALL. CONNECT TO EXISTING GAS RANGE STOVE. PROVIDE GAS COCK AND FLEXIBLE PIPE CONNECTOR.
- 9. RUN 3/8" O.D. RL AND 5/8" O.D. RS ABOVE CEILING. TURN DOWN ALONG WALL AND CONNECT TO FAN COIL UNIT.
- 10. RUN 3/4" PUMPED CONDENSATE DRAIN IN ATTIC SPACE.
- 11. 3/4" CONDENSATE DRAIN FROM ADJACENT UNIT TO CONDENSATE PUMP. SEE DETAIL ON SHEET M20.
- 12. 3/4" GAS PIPE DOWN. CONNECT TO WATER HEATER.
- 13. 3/4" HS & HR PIPING TO HOT WATER COIL. SEE DETAIL ON SHEET M19.
- 14. EF-6, SEE DETAIL ON SHEET M17.

ON SHEET A7.

### GENERAL NOTES

- 1. REFER TO SHEET M18 FOR LEGEND.
- 2. ENLARGED 1/4" FLOOR PLANS INDICATE TYPICAL WORK FOR ALL SIMILAR AND OPPOSITE HAND UNITS. REFER TO FLOOR PLANS FOR UNIT TYPES.

### ABATEMENT NOTES

- 1. MECHANICAL EXPOSED PAINTED DUCTWORK HAS BEEN TESTED AND IS KNOWN TO CONTAIN LEAD BASED PAINT. ALL EXPOSED DUCTWORK INDICATED FOR REMOVAL SHALL BE REMOVED IN ACCORDANCE WITH SPECIFICATION SECTION 02090 BY THE ABATEMENT CONTRACTOR.
- REMOVE ASBESTOS INSULATION FROM ABANDONED HYDRONIC HEATING PIPING IN ATTIC PER SPECIFICATION SECTION 02080. PIPING SHALL REMAIN IN ATTIC AND SHALL BE ENCAPSULATED PER SECTION 02080. WORK SHALL BE PERFORMED BY THE ABATEMENT CONTRACTOR.


### DAY CARE CENTER

1. MECHANICAL DEMOLITION AND NEW WORK INDICATED ON THIS SHEET SHALL BE TYPICAL OF THE DEMOLITION AND NEW WORK REQUIRED FOR THE DAY CARE CENTER LOCATED AT 770A AND 7709 35th STREET.



COMPREHENSIVE RENOVATION OF VA 3-2 MARSHALL COURTS

NEWPORT NEWS, VA

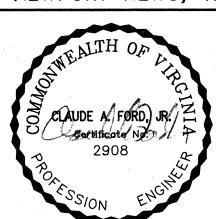

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	Checked	CAF
	Scale	NOTED

Date: JANUARY 31, 1992


File No:

Project No: 90006


BUILDING
TYPE D3 FLOOR PLANS
(DEMOLITION &
NEW WORK)

Sheet No:

M8 Sheets

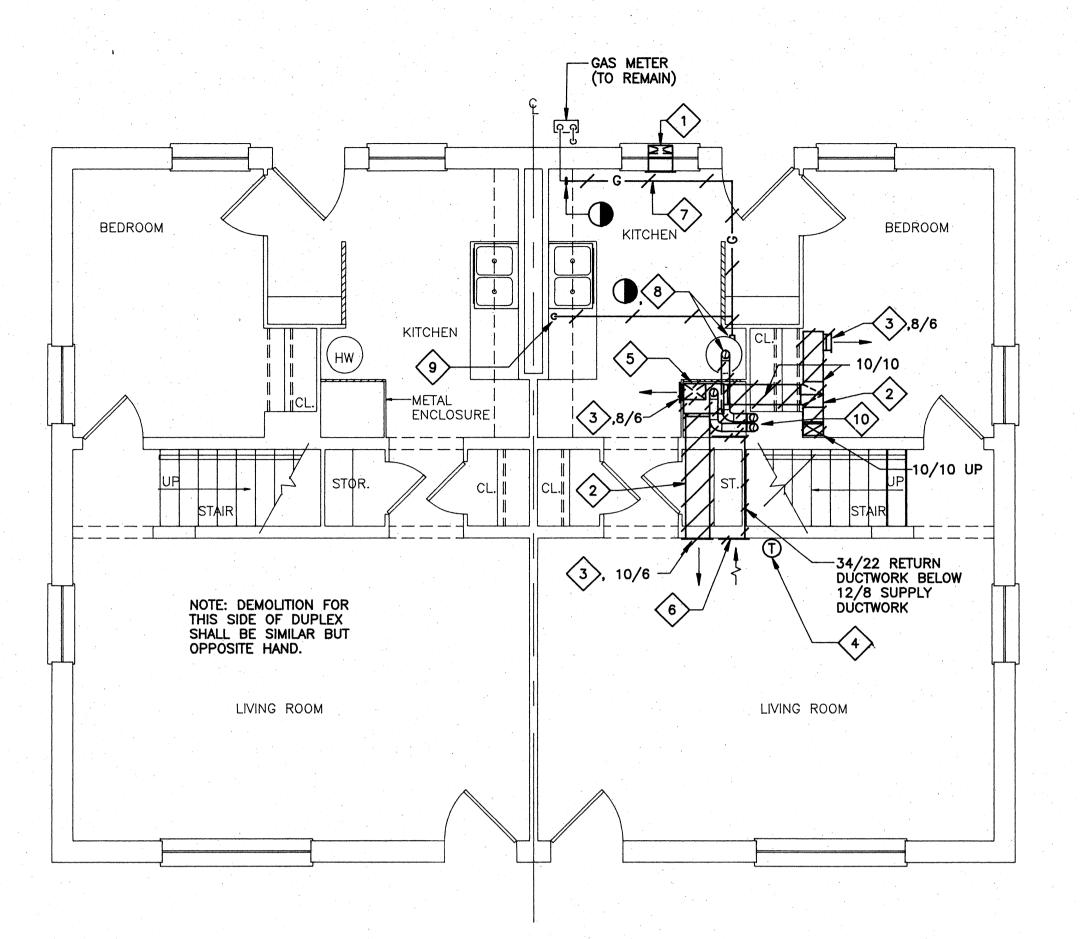


FIRST FLOOR PLAN - BLDG. D4 (DEMOLITION)

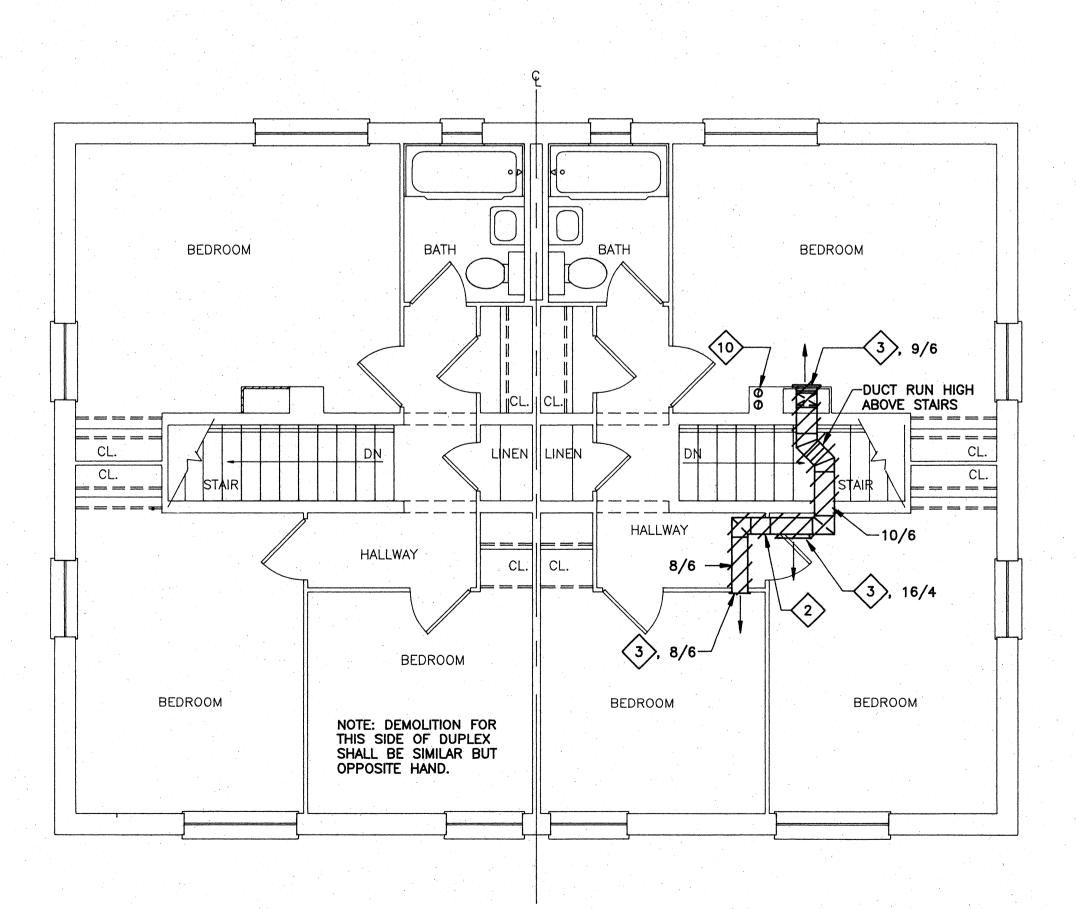


SECOND FLOOR PLAN - BLDG. D4 (DEMOLITION)

SCALE: 1/4" = 1'-0"

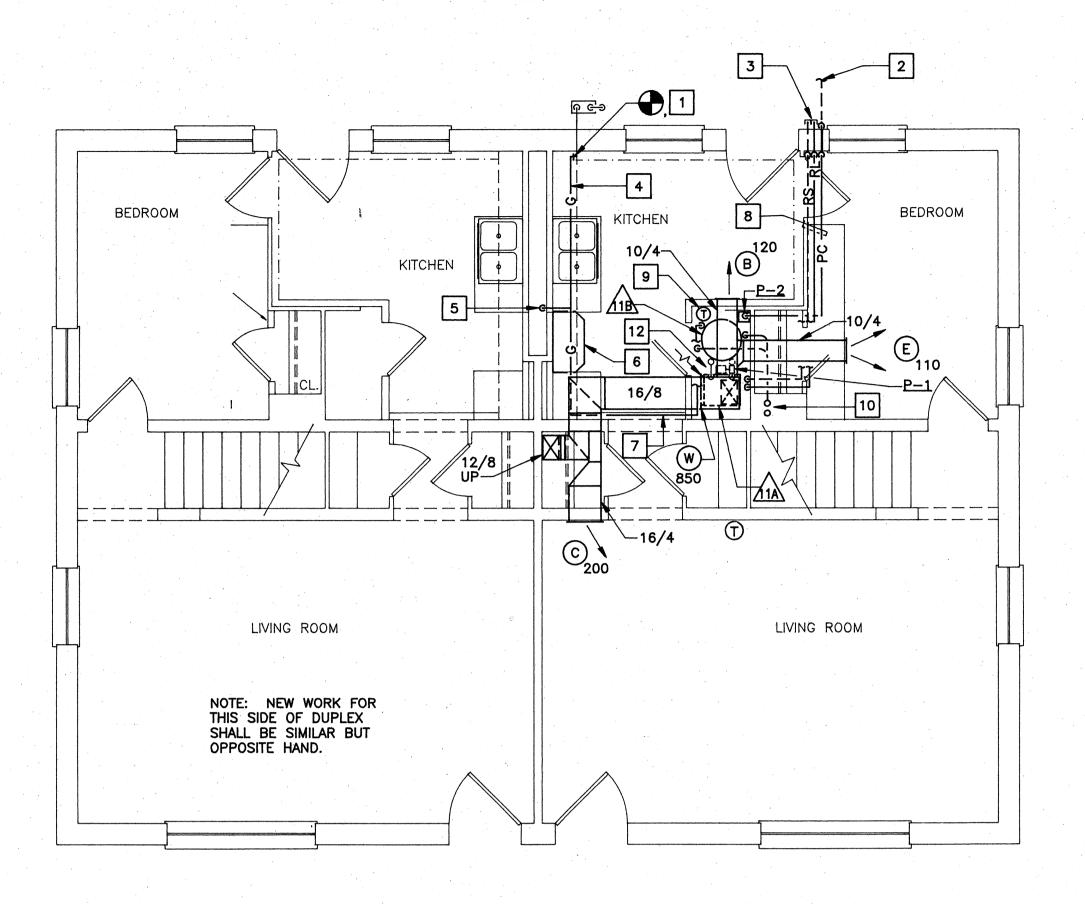

### FIRST FLOOR PLAN - BLDG. D4 (NEW WORK)

SCALE: 1/4" = 1'-0"

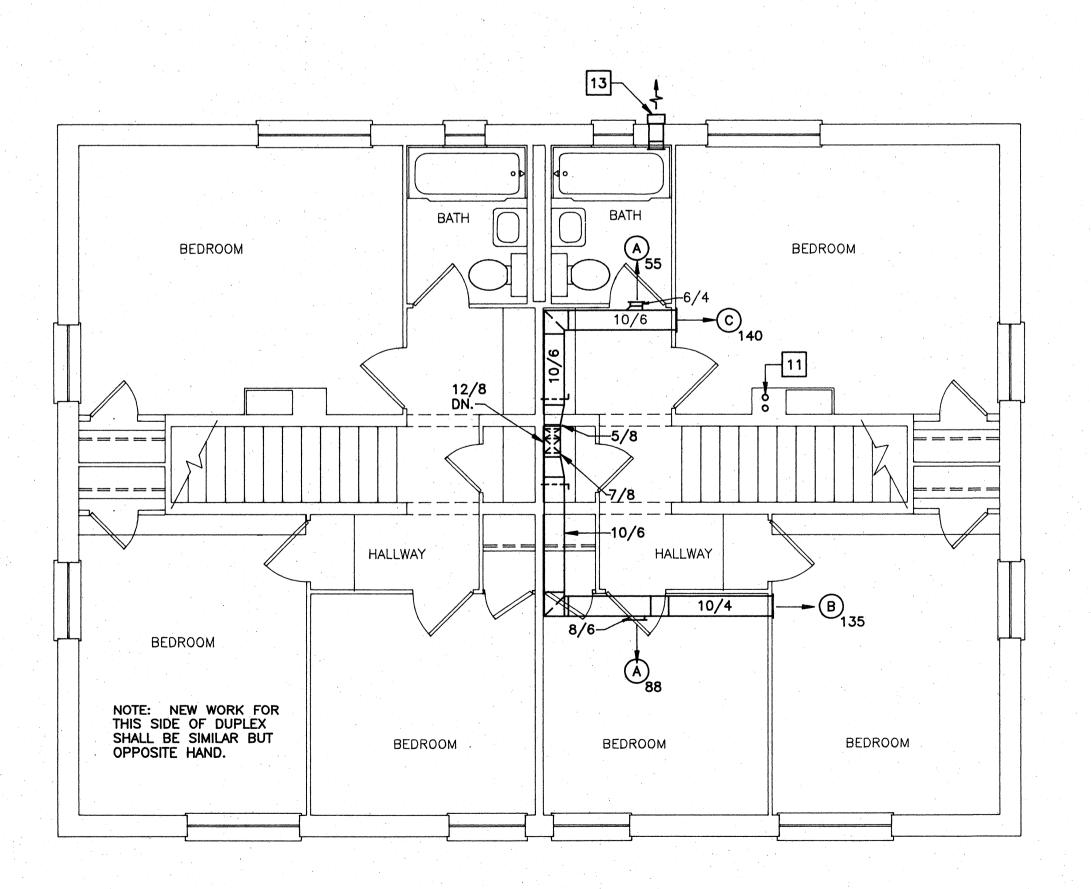

SECOND FLOOR PLAN - BLDG. D4 (NEW WORK)

SCALE: 1/4" = 1'-0"

### DEMOLITION NOTES

- 1. REMOVE COMBUSTION AIR INTAKE DUCT AND GRILLE.
- 2. REMOVE SUPPLY DUCTWORK.
- 3. REMOVE SUPPLY REGISTER SIZED AS MARKED.
- 4. REMOVE THERMOSTAT AND WIRING.
- 5. REMOVE FURNACE FLUE COMPLETE WITH ASSOCIATED EQUIPMENT.
- 6. REMOVE 24/14 RETURN REGISTER.
- 7. REMOVE 3/4" GAS PIPING AS INDICATED.
- . REMOVE 3/4" GAS PIPING & FLUE COMPLETE FROM DOMESTIC WATER HEATER.
- . REMOVE 3/4" GAS PIPING DOWN TO RANGE.
- 10. REMOVE 4" Ø FLUE UP THRU CHASE TO ROOF.

### NEW WORK NOTES

- 1. CONNECT 3/4" GAS PIPING TO EXISTING 3/4" GAS PIPING AT POINT INDICATED.
- 2. 3/4" CONDENSATE DRAIN PIPING UNDERGROUND TO DRY WELL. SEE DETAIL ON SHEET M20.
- 3. CAP 3/8" O.D. RL AND 5/8" O.D. RS AT EXTERIOR FACE OF WALL. SEE DETAIL ON SHEET M17.
- . RUN 3/4" GAS PIPING IN SOFFIT.
- . RUN 3/4" GAS PIPING DOWN IN CHASE. CONNECT TO EXISTING GAS RANGE STOVE. PROVIDE GAS COCK AND FLEXIBLE PIPE CONNECTOR.
- 6. PROVIDE STAINLESS STEEL DUCTLESS RANGE EXHAUST HOOD. 2 SPEED FAN AND LAMP. MOUNT UNDER CABINET.
- 7. RUN 3/4" GAS PIPING IN SOFFIT AND CONNECT TO WATER HEATER.
- 8. RUN 3/8" O.D. RL, 5/8" O.D. RS AND 3/4" PUMPED CONDENSATE DRAIN PIPING IN SOFFIT.
- 9. PROVIDE WALL MOUNTED TEMPERATURE CONTROLLER. SEE DETAIL ON SHEET M19.
- 10. 2" PLASTIC FLUE AND INTAKE PIPING UP
  IN EXISTING CHIMNEY. SEE SECOND FLOOR PLAN BLDG. D4
  (NEW WORK) FOR CONTINUATION.
- 11. 2" PLASTIC FLUE AND INTAKE PIPING UP IN EXISTING CHIMNEY. TERMINATE 36" ABOVE ROOF LINE. SEE DETAIL ON
- 12. 3/4" HS & HR PIPING TO HOT WATER COIL. SEE DETAIL ON SHEET M19.
- 13. EF-6, SEE DETAIL ON SHEET M17.

### GENERAL NOTES


. REFER TO SHEET M18 FOR LEGEND.

2. ENLARGED 1/4" FLOOR PLANS INDICATE TYPICAL WORK FOR ALL SIMILAR AND OPPOSITE HAND UNITS. REFER TO FLOOR PLANS FOR UNIT TYPES.

# COMPREHENSIVE RENOVATION OF VA 3-2 MARSHALL COURTS

### ABATEMENT NOTE NEWPORT NEWS, VA

1. MECHANICAL EXPOSED PAINTED DUCTWORK HAS BEEN TESTED AND IS KNOWN TO CONTAIN LEAD BASED PAINT. ALL EXPOSED DUCTWORK INDICATED FOR REMOVAL SHALL BE REMOVED IN ACCORDANCE WITH SPECIFICATION SECTION 02090 BY THE ABATEMENT CONTRACTOR.

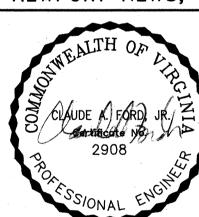

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Date: JANUARY 31, 1992


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Project No: 90006


BUILDING
TYPE D4 FLOOR PLANS
(DEMOLITION &
NEW WORK)

Sheet No

M9

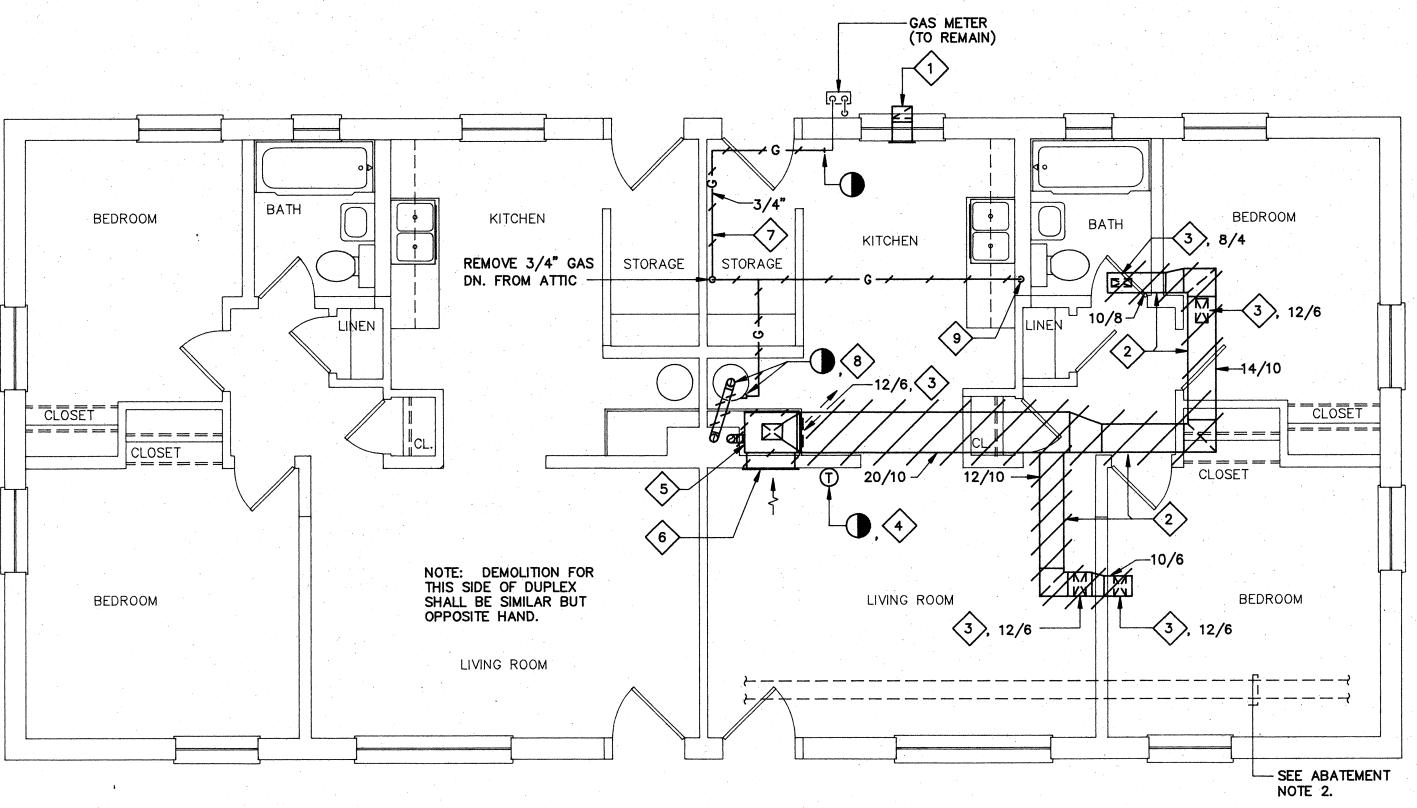

### FLOOR PLAN - BUILDING D2 / 1BR HANDICAPPED CONVERSION (DEMOLITION) SCALE: 1/4" = 1'-0"

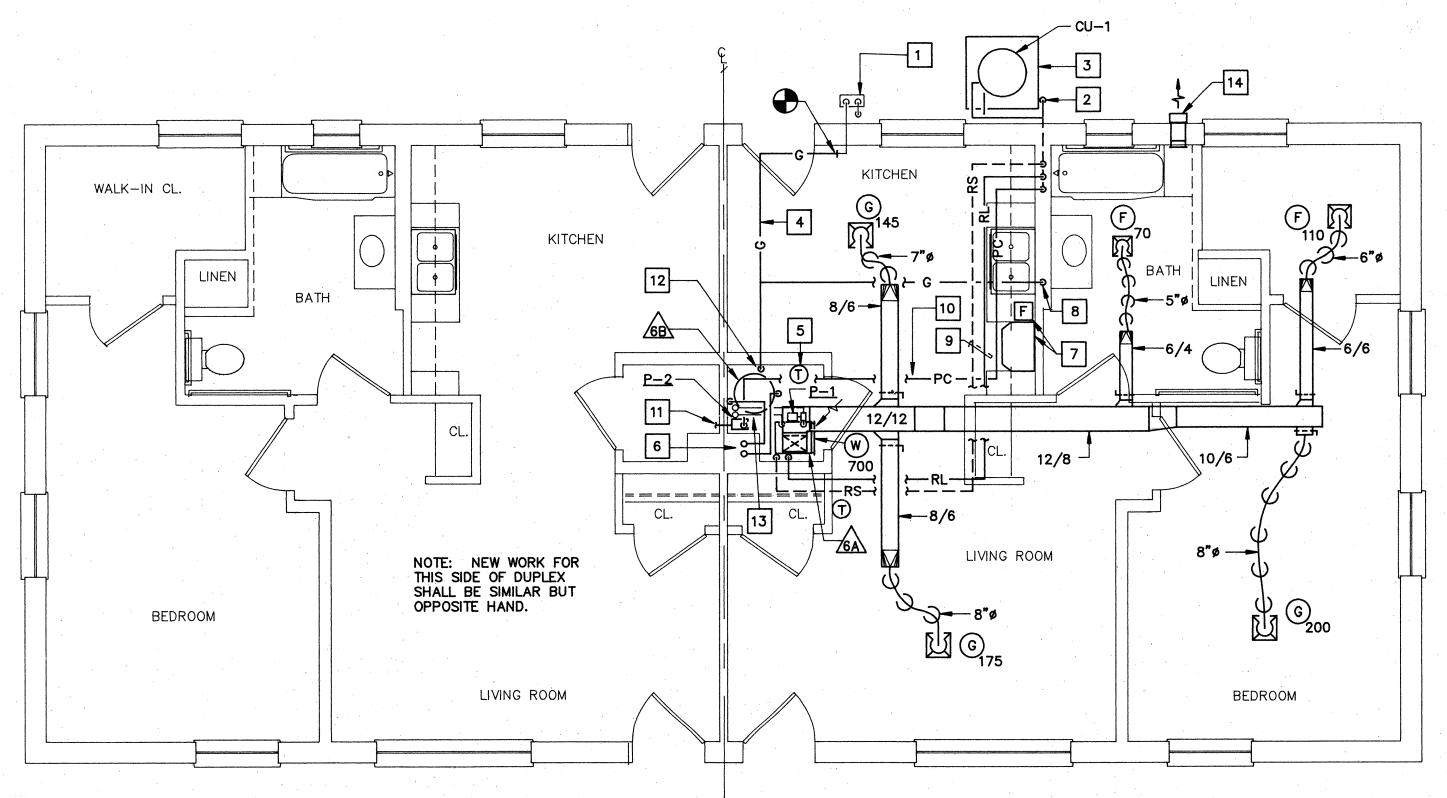

1BR HANDICAPPED CONVERSION (NEW WORK) FLOOR PLAN - BUILDING D2 / SCALE: 1/4" = 1'-0"

### DEMOLITION NOTES

- REMOVE COMBUSTION AIR INTAKE DUCT AND GRILLE.
- REMOVE SUPPLY DUCTWORK IN ATTIC SPACE DUCT SIZES ARE APPROXIMATE.
- REMOVE SUPPLY REGISTER SIZED AS MARKED.
- REMOVE WALL MOUNTED THERMOSTAT AND WIRING COMPLETE.
- REMOVE FURNACE & FLUE COMPLETE WITH ASSOCIATED EQUIPMENT.
- REMOVE 24/14 RETURN REGISTER.
- REMOVE 3/4" GAS PIPING AS INDICATED.
- REMOVE 3/4" GAS PIPING & FLUE COMPLETE FROM DOMESTIC WATER
- REMOVE 3/4" GAS PIPING DN. IN WALL TO GAS RANGE.

### NEW WORK NOTES

- CONNECT 3/4" GAS PIPING TO EXISTING 3/4" GAS PIPING AT POINT INDICATED.
- 2. 3/4" CONDENSATE DRAIN PIPING UNDERGROUND TO DRYWELL. SEE DETAIL ON SHEET M20.
- 3. PROVIDE 36"x 36"x 4" CONCRETE PAD.
- 4. RUN 3/4" GAS PIPING IN ATTIC SPACE.
- TEMPERATURE CONTROLLER. SEE DETAIL ON SHT. M19.
- 2" PLASTIC FLUE AND INTAKE PIPING UP IN EXISTING CHIMNEY. TERMINATE 36" ABOVE ROOF LINE. SEE DETAIL
- PROVIDE STAINLESS STEEL DUCTLESS RANGE EXHAUST HOOD WITH CABINET MOUNTED 2-SPEED FAN AND LAMP SWITCH. MOUNT UNDER CABINET.
- 8. 3/4" GAS PIPING TURN DOWN IN WALL. CONNECT TO EXISTING GAS RANGE STOVE. PROVIDE GAS COCK AND FLEXIBLE PIPE CONNECTOR.
- RUN 3/8" O.D. RL AND 5/8" O.D. RS ABOVE CEILING. TURN DOWN ALONG WALL AND CONNECT TO FAN COIL UNIT.
- 10. RUN 3/4" PUMPED CONDENSATE IN ATTIC SPACE.
- 11. 3/4" CONDENSATE DRAIN FROM ADJACENT UNIT TO CONDENSATE PUMP. SEE DETAIL ON SHEET M20.
- 12. 3/4" GAS PIPE DOWN. CONNECT TO WATER HEATER.
- 13. 3/4" HS & HR PIPING TO HOT WATER COIL SEE DETAIL ON SHT. M19.
- 14. EF-6, SEE DETAIL ON SHEET M17.

### GENERAL NOTES

- REFER TO SHEET M18 FOR LEGEND.
- 2. ENLARGED 1/4" FLOOR PLANS INDICATE TYPICAL WORK FOR ALL FOR UNIT TYPES.


### ABATEMENT NOTES

- MECHANICAL EXPOSED PAINTED DUCTWORK HAS BEEN TESTED AND IS KNOWN TO CONTAIN LEAD BASED PAINT. ALL EXPOSED DUCTWORK INDICATED FOR REMOVAL SHALL BE REMOVED IN ACCORDANCE WITH SPECIFICATION SECTION 02090 BY THE ABATEMENT CONTRACTOR.
- REMOVE ASBESTOS INSULATION FROM ABANDONED HYDRONIC HEATING PIPING IN ATTIC PER SPECIFICATION SECTION 02080. PIPING SHALL REMAIN IN ATTIC AND SHALL BE ENCAPSULATED PER SECTION 02080. WORK SHALL BE PERFORMED BY THE ABATEMENT CONTRACTOR.



COMPREHENSIVE RENOVATION VA 3-2 MARSHALL COURTS

NEWPORT NEWS, VA

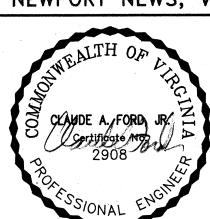


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	Date	JANUARY	31,	1992


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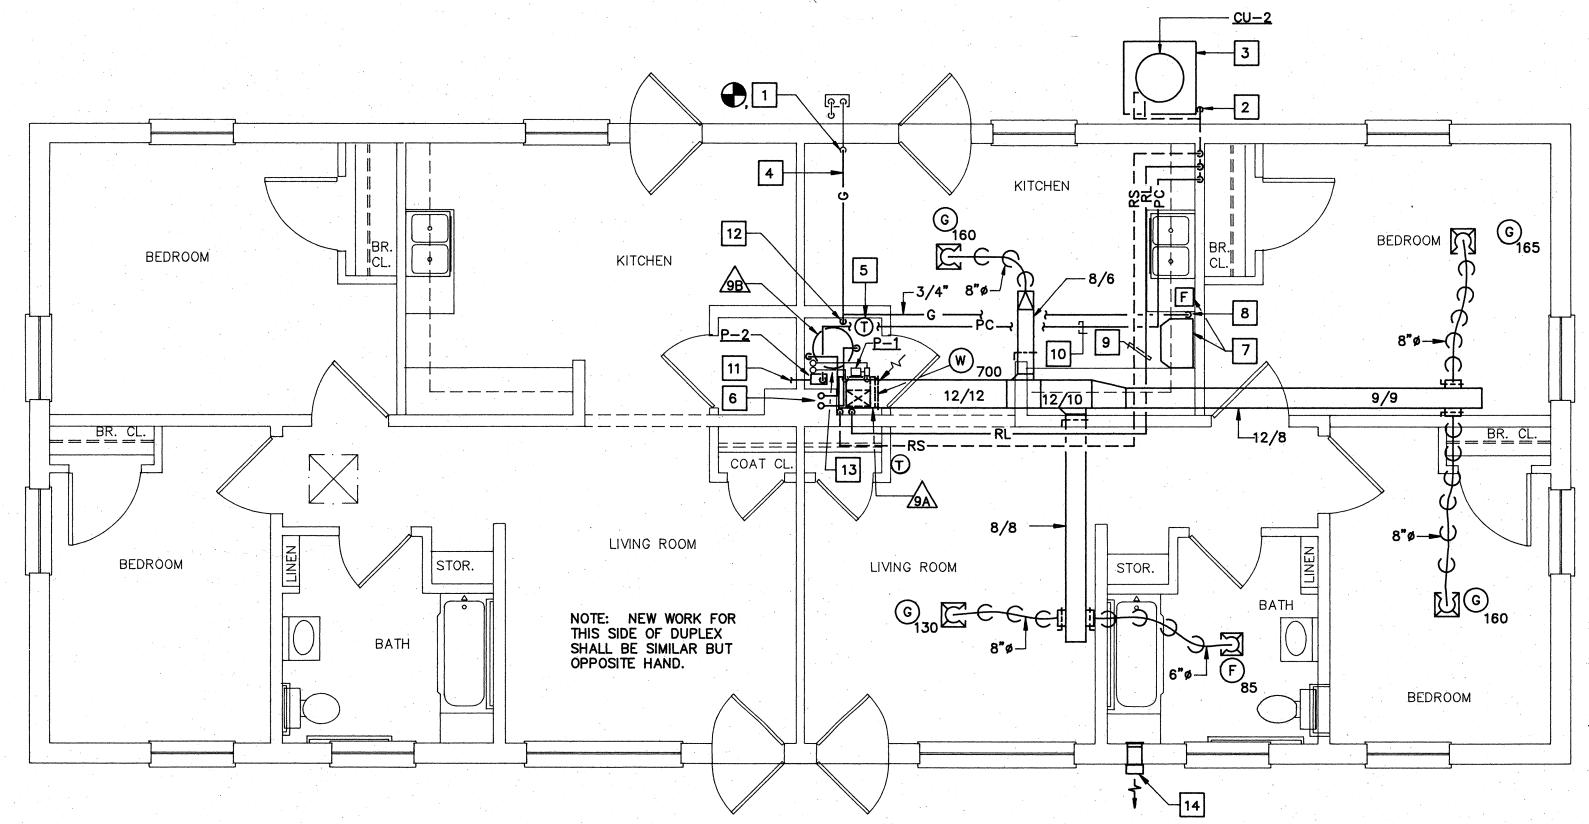
BUILDING TYPE D2 -FLOOR PLANS (DEMOLITION & NEW WORK / HANDICAPPED CONVERSION)

Sheet No:



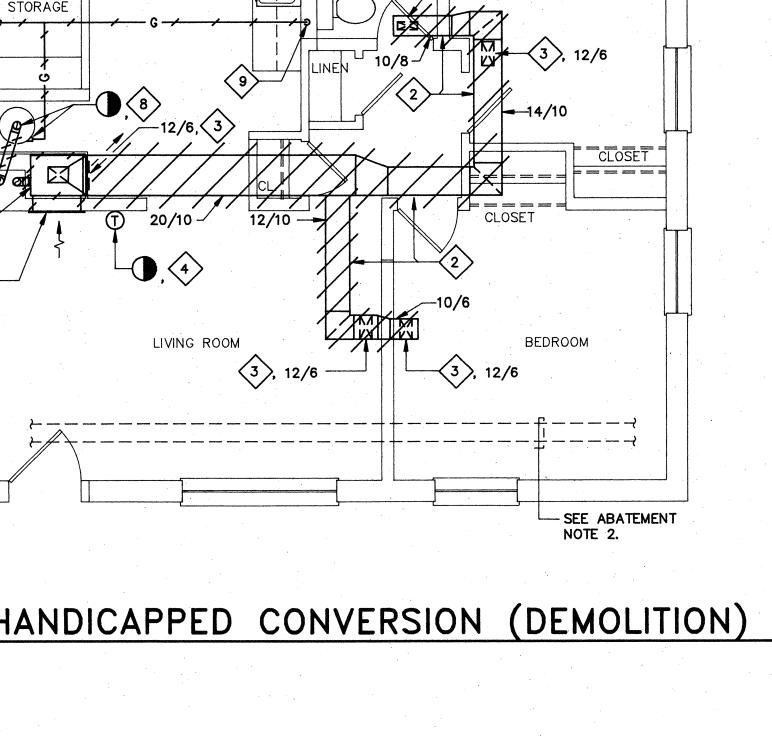

FLOOR PLAN - BUILDING D3 - HANDICAPPED CONVERSION (DEMOLITION)

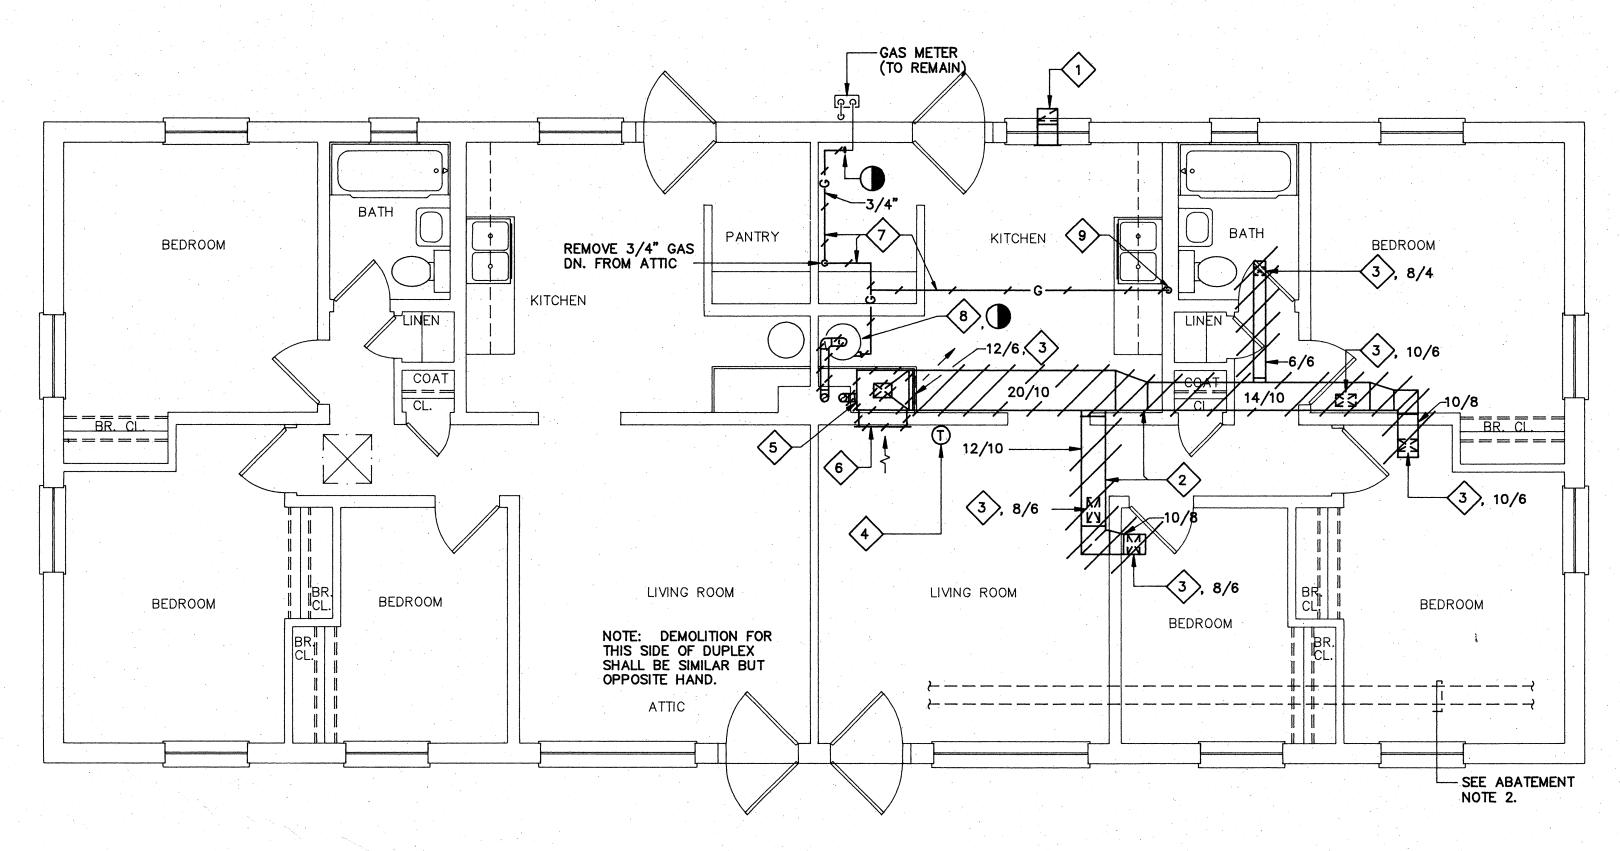

FLOOR PLAN - BUILDING D3 - HANDICAPPED CONVERSION (NEW WORK)

SCALE: 1/4" = 1'-0"

### DEMOLITION NOTES

- REMOVE COMBUSTION AIR INTAKE DUCT AND GRILLE.
- REMOVE SUPPLY DUCTWORK IN ATTIC SPACE DUCT SIZES ARE APPROXIMATE
- 3. REMOVE SUPPLY REGISTER SIZED AS MARKED.
- 4. REMOVE WALL MOUNTED THERMOSTAT AND WIRING COMPLETE.
- 5. REMOVE FURNACE & FLUE COMPLETE WITH ASSOCIATED EQUIPMENT.
- 6. REMOVE 24/14 RETURN REGISTER.
- 7. REMOVE 3/4" GAS PIPING AS INDICATED.
- 8. REMOVE 3/4" GAS PIPING & FLUE COMPLETE FROM DOMESTIC WATER
- 9. REMOVE 3/4" GAS PIPING DN. IN WALL TO GAS RANGE.

### ☐ NEW WORK NOTES

- CONNECT 3/4" GAS PIPING TO EXISTING 3/4" GAS PIPING AT POINT INDICATED.
- 2. 3/4" CONDENSATE DRAIN PIPING UNDERGROUND TO DRYWELL. SEE DETAIL ON SHEET M20.
- 3. PROVIDE 36"x 36"x 4" CONCRETE PAD.
- 4. RUN 3/4" GAS PIPING IN ATTIC SPACE.
- PROVIDE WALL MOUNTED SEE DETAIL ON SHEET M19.
- TEMPERATURE CONTROLLER.
- 2" PLASTIC FLUE AND INTAKE PIPING UP IN EXISTING CHIMNEY. TERMINATE 36" ABOVE ROOF LINE. SEE DETAIL
- PROVIDE STAINLESS STEEL DUCTLESS RANGE EXHAUST HOOD WITH CABINET MOUNTED 2-SPEED FAN AND LAMP SWITCH. MOUNT HOOD UNDER CABINET.
- 3/4" GAS PIPING TURN DOWN IN WALL. CONNECT TO EXISTING GAS RANGE STOVE. PROVIDE GAS COCK AND FLEXIBLE PIPE CONNECTOR.
- 9. RUN 3/8" O.D. RL AND 5/8" O.D. RS ABOVE CEILING. TURN DOWN ALONG WALL AND CONNECT TO FAN COIL UNIT.
- 10. RUN 3/4" PUMPED CONDENSATE DRAIN IN ATTIC SPACE.
- 11. 3/4" CONDENSATE DRAIN FROM ADJACENT UNIT TO CONDENSATE PUMP. SEE DETAIL ON SHEET M20.
- 12. 3/4" GAS PIPE DOWN. CONNECT TO WATER HEATER.
- 13. 3/4" HS & HR PIPING TO HOT WATER COIL. SEE DETAIL ON SHEET M19.
- 14. EF-6, SEE DETAIL ON SHEET M17.

### GENERAL NOTES

- REFER TO SHEET M18 FOR LEGEND.
- ENLARGED 1/4" FLOOR PLANS INDICATE TYPICAL WORK FOR ALL SIMILAR AND OPPOSITE HAND UNITS. REFER TO FLOOR PLANS FOR UNIT TYPES.

### ABATEMENT NOTES


- MECHANICAL EXPOSED PAINTED DUCTWORK HAS BEEN TESTED AND IS KNOWN TO CONTAIN LEAD BASED PAINT. ALL EXPOSED DUCTWORK INDICATED FOR REMOVAL SHALL BE REMOVED IN ACCORDANCE WITH SPECIFICATION SECTION 02090 BY THE ABATEMENT CONTRACTOR.
- REMOVE ASBESTOS INSULATION FROM ABANDONED HYDRONIC HEATING PIPING IN ATTIC PER SPECIFICATION SECTION 02080. PIPING SHALL REMAIN IN ATTIC AND SHALL BE ENCAPSULATED PER SECTION 02080. WORK SHALL BE PERFORMED BY THE ABATEMENT CONTRACTOR.



COMPREHENSIVE

RENOVATION OF VA 3-2 MARSHALL COURTS

NEWPORT NEWS, VA

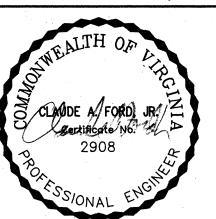

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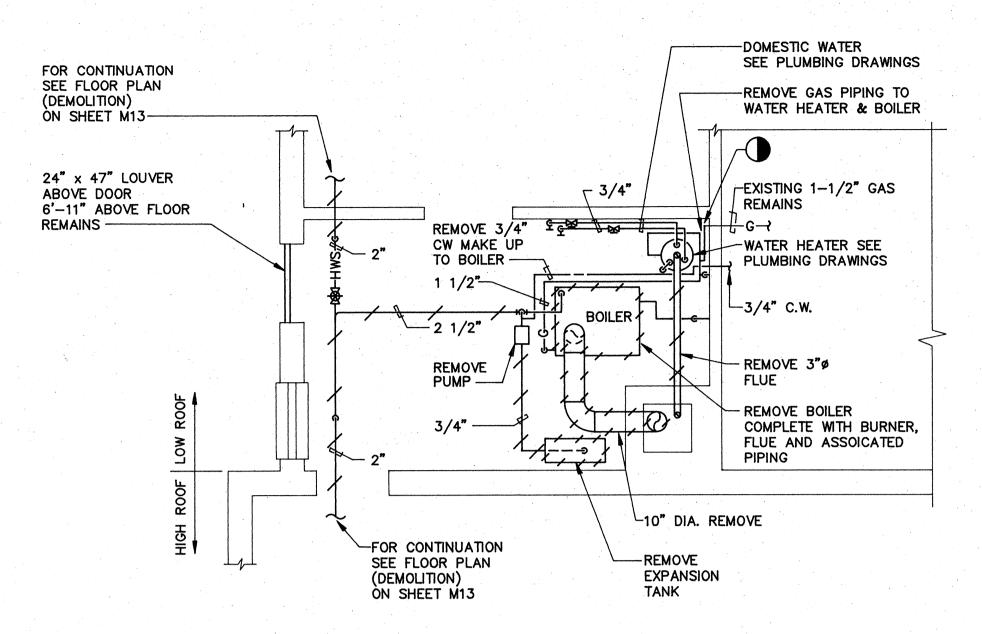
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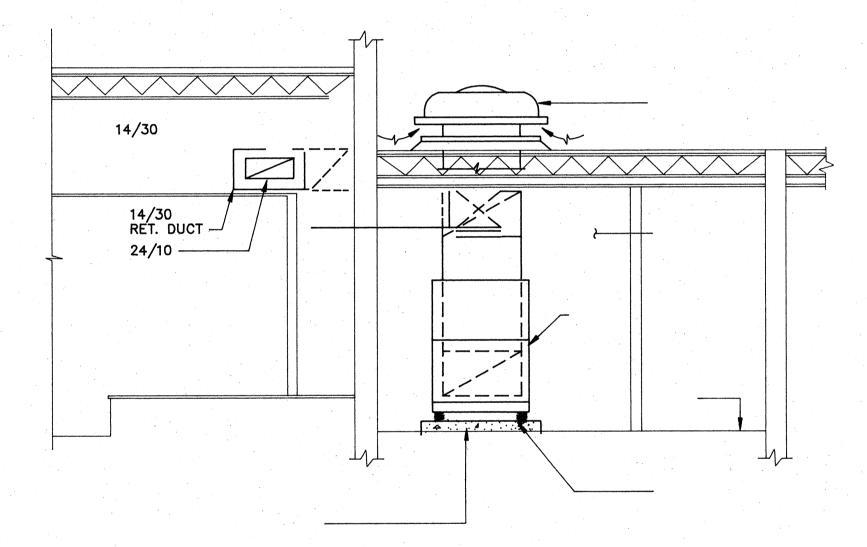
BUILDING TYPE D3 -FLOOR PLANS (DEMOLITION & NEW WORK / HANDICAPPED CONVERSION)

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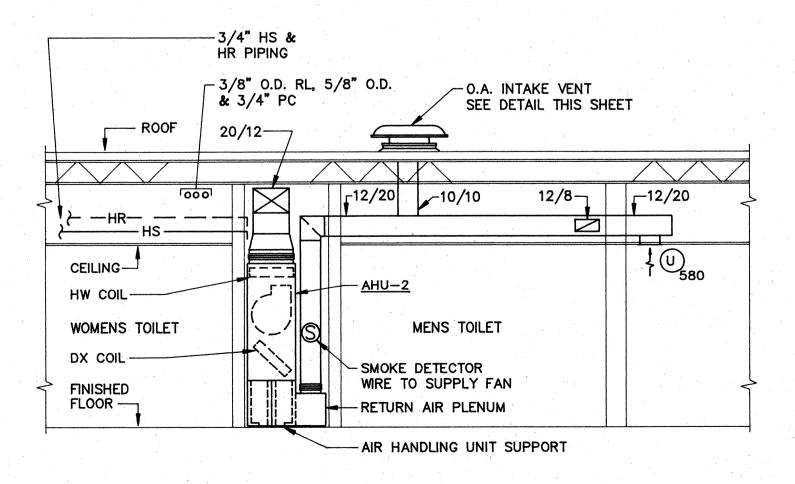
M12



# MECHANICAL ROOM PART PLAN (DEMOLITION) SCALE: 1/4" = 1'-0"




# 3 SECTION M13 M14 SCALE: 1/4" = 1'-0



4 SECTION

M13 M14 SCALE: 1/4" = 1'-0'

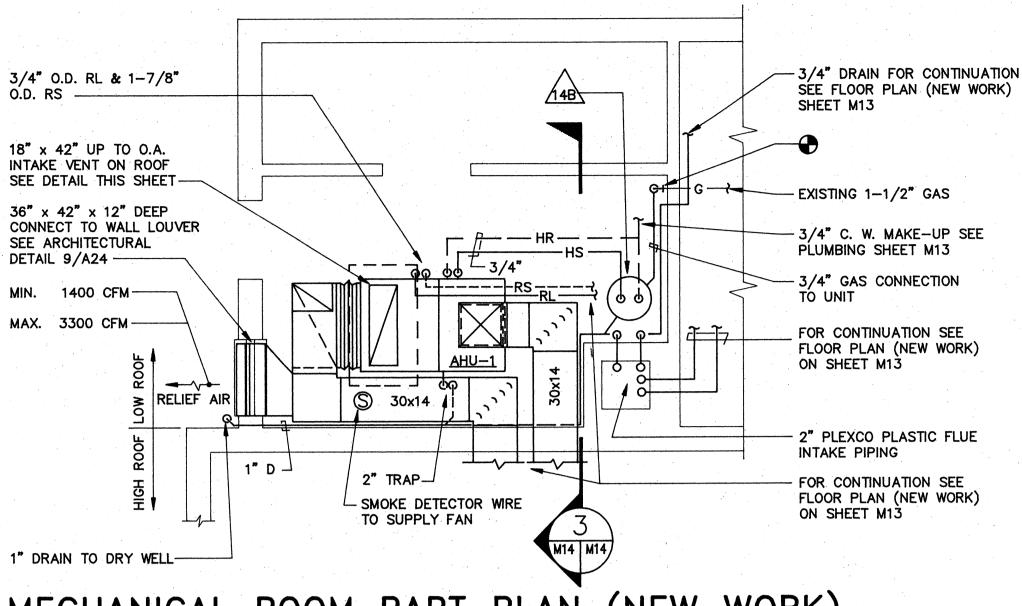


MECHANICAL ROOM PART PLAN (NEW WORK)


SCALE: 1/4" = 1'-0"

### SEQUENCE OF OPERATION

AIR HANDLING UNIT NO. 1 CONTROL: MIXED AIR ECONOMIZER CONTROLLER CONTROLS WHEN THE MIXED AIR TEMPERATURE IS BELOW THE SETTING TO MODULATE OUTSIDE AIR DAMPER UP TO ITS 100 PERCENT OPEN POSITION PROPORTIONATELY CLOSING RETURN AIR DAMPER FOR FREE COOLING. CONTROLLER INCORPORATES A MINIMUM POSITION SWITCH TO SET THE DAMPERS TO THEIR MINIMUM POSITION AND ECONOMIZER PREVENTS THE MIXED AIR TEMPERATURE FROM FALLING BELOW A PREDETERMINED TEMPERATURE. WHEN THE WALL MOUNTED THERMOSTAT IS POSITIONED TO HEAT, ON A FALL IN SPACE TEMPERATURE THE HOT WATER VALVE WILL OPEN AND THE PUMP SHALL START. ON RISE IN TEMPERATURE THE REVERSE OPERATION WILL OCCUR. WHEN THE WALL MOUNTED THERMOSTAT IS POSITIONED TO COOL, AND ON A RISE IN SPACE TEMPERATURE THE REFRIGERATION CIRCUIT SHALL ENERGIZE AND THE SOLENOID VALVE SHALL OPEN. ON A FALL IN TEMPERATURE THE REVERSE OPERATION WILL OCCUR. WHEN THE SWITCH IS PLACED IN OFF NO HEATING OR COOLING IS MADE AVAILABLE. FREEZESTAT CONTROLS TO STOP THE UNIT FAN AND CLOSE OUTSIDE AIR DAMPER AND OPEN RETURN AIR DAMPER SHOULD THE TEMPERATURE FALL BELOW A PREDETERMINED SETTING. SMOKE DETECTOR SD-1 CONTROLS TO STOP THE UNIT FAN AND CLOSE D-1 AND OPEN D-2 SHOULD SMOKE BE DETECTED.

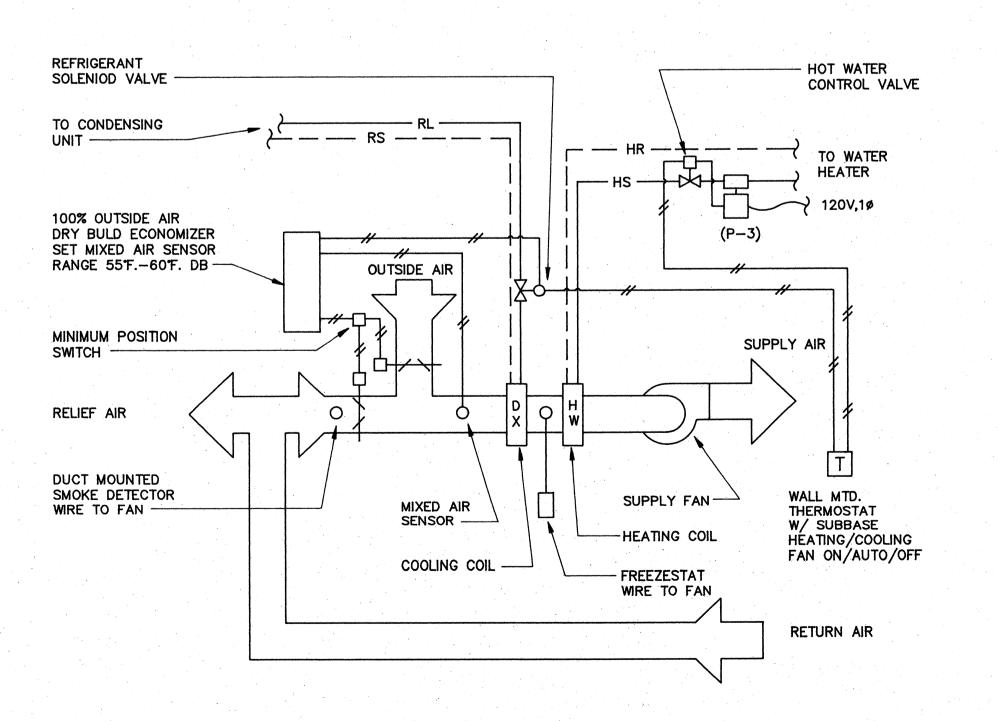


AUTOMATIC TEMPERATURE CONTROLS FOR AHU-1
NO SCALE

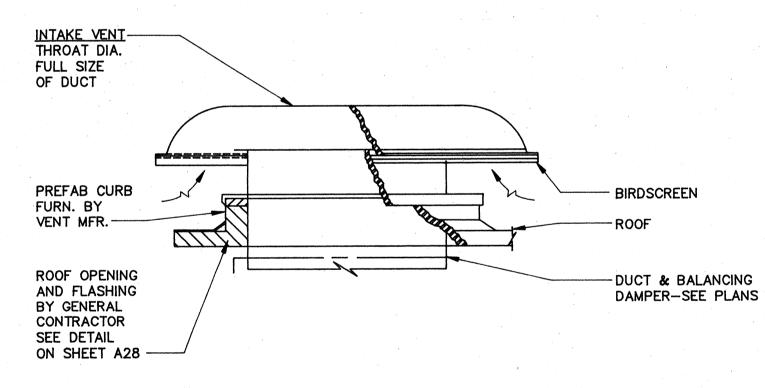

### OUTSIDE AIR INTAKE VENT DETAIL

NO SCALE

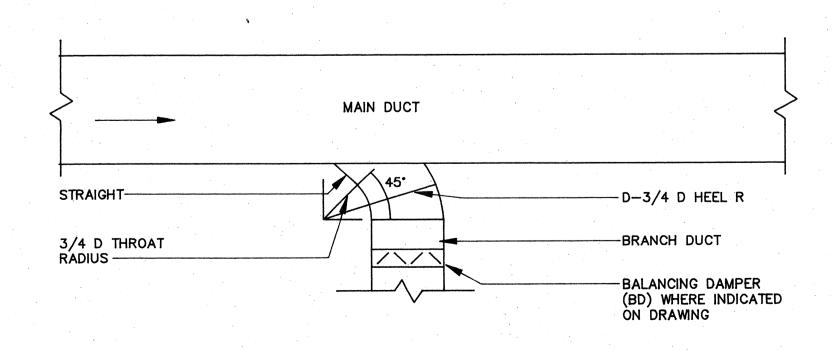

### TYPICAL BRANCH CONNECTION


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COMPREHENSIVE RENOVATION OF VA 3-2 MARSHALL COURTS

NEWPORT NEWS, VA




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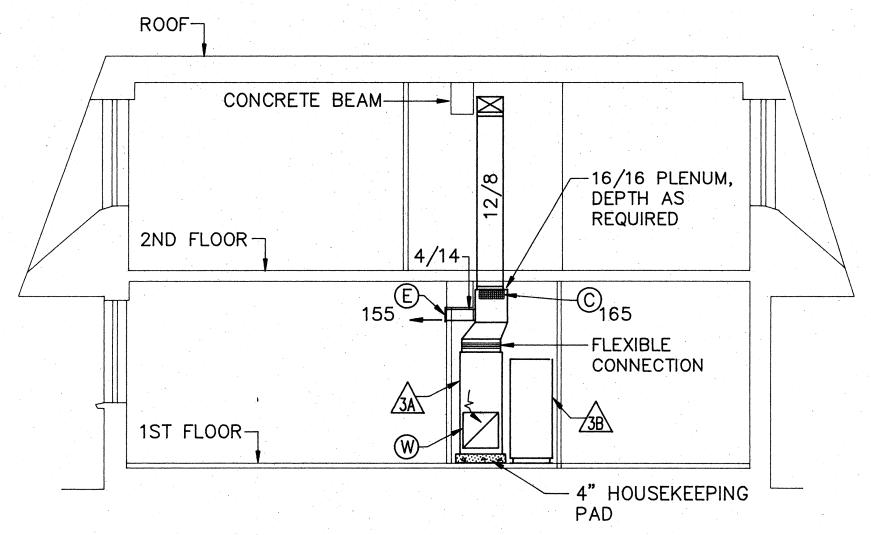
BUILDING MECHANICAL EQUIPMENT ROOM PLANS AND SECTIONS

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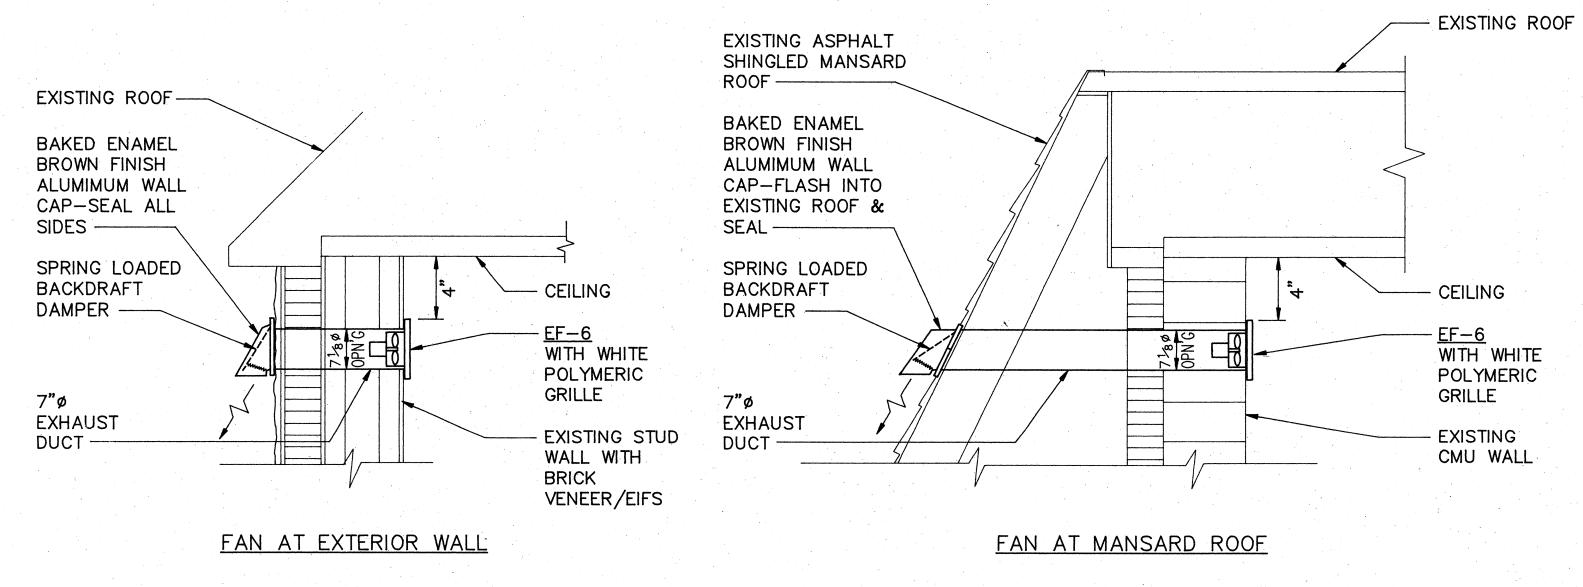
M14 Sheets

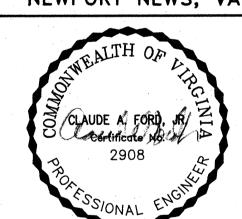



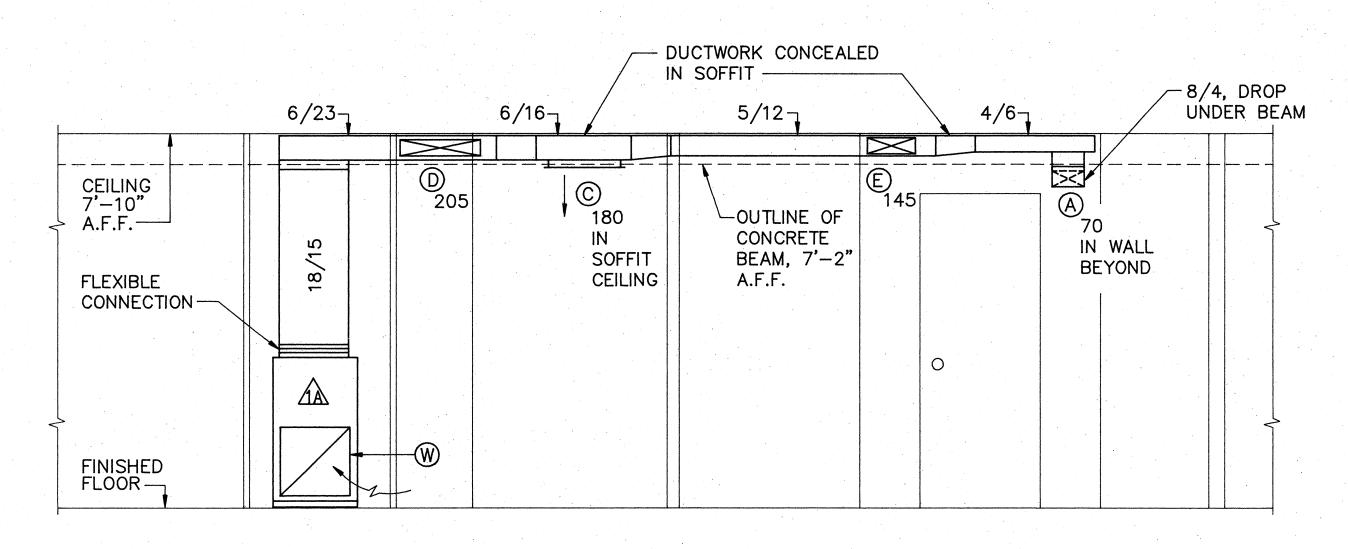


SECTION M2 M5 M17 SCALE: 1/4" = 1'-0"




### EXHAUST FAN (EF-6) MOUNTING DETAILS

NO SCALE

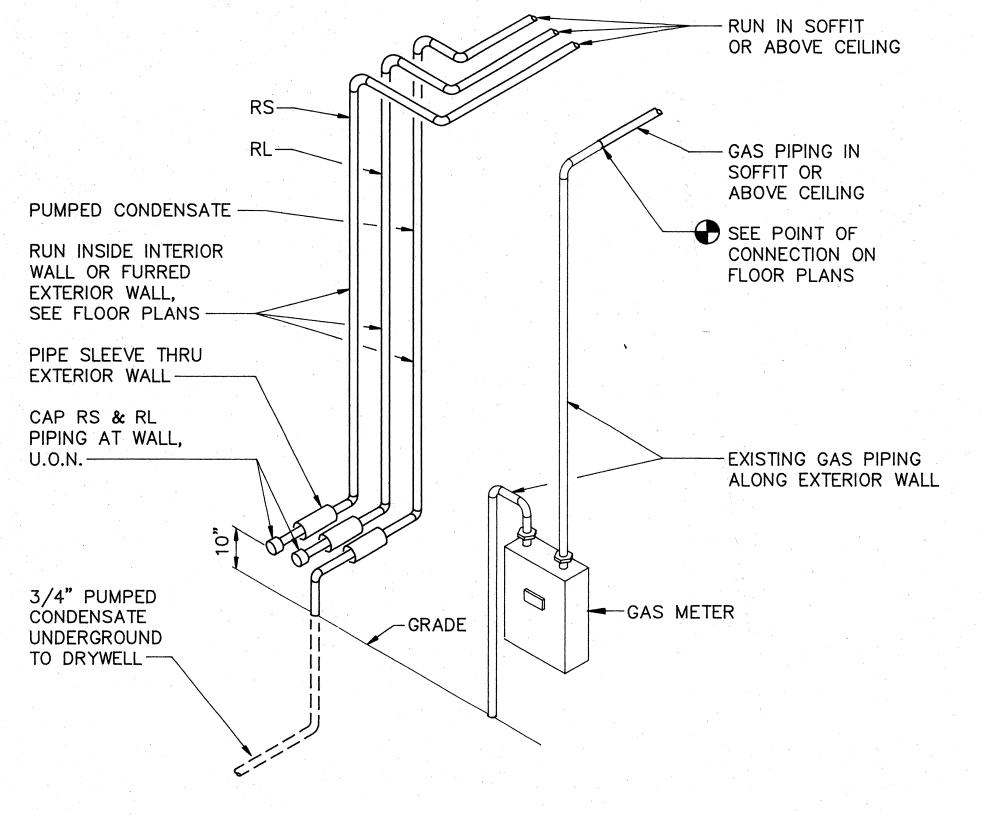

SCHEMATIC VIEW

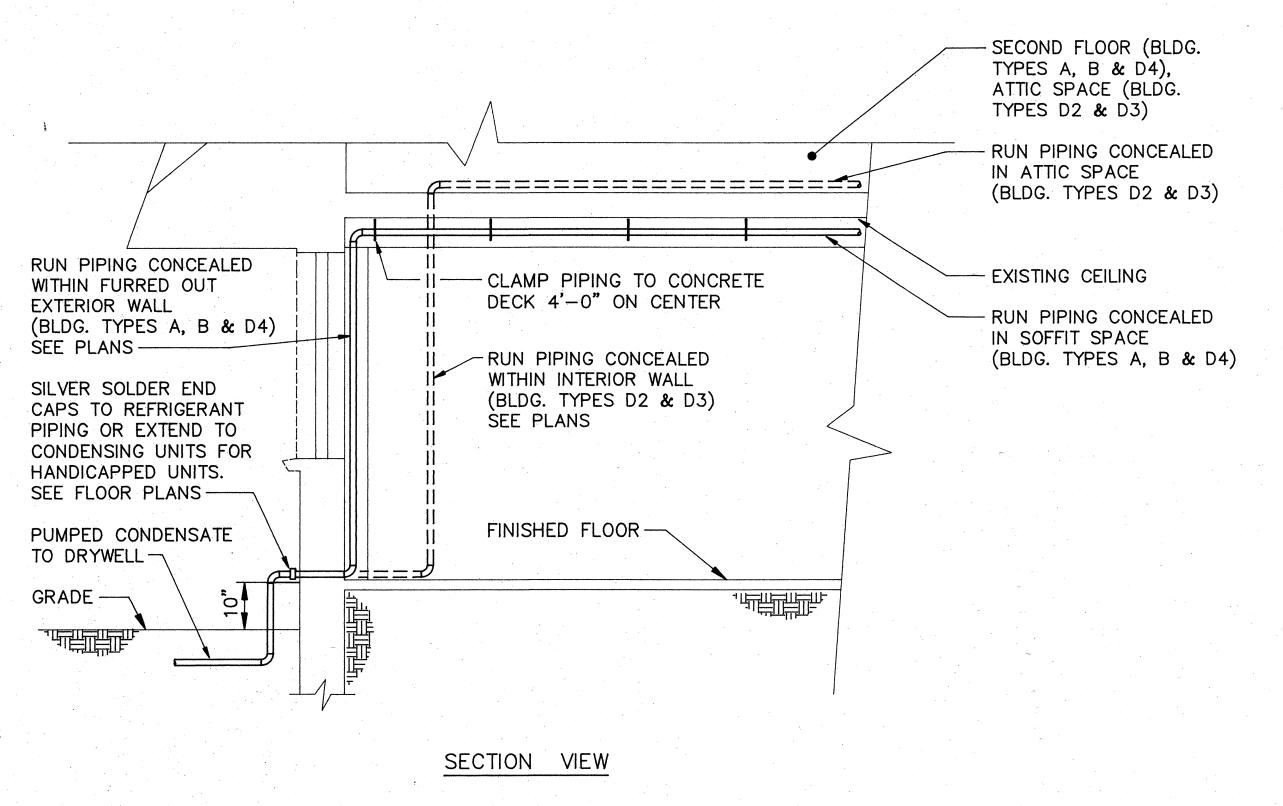

#### PIPING DETAIL


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COMPREHENSIVE RENOVATION VA 3-2 MARSHALL

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DETAIL

-	WATER HEATER/FAN COIL UNIT SYSTEM SCHEDULE																						
		FAN COIL UNIT											WATER HEATER										
					FAN			coo	LING CO	OIL		HEATING	G COIL							TANK			
	TAG	MODEL	SA CFM	ESP	HP	VOLTS	Ø	TOTAL BTU/H	SENS BTU/H	APD H <sub>2</sub> O	TOTAL BTU/H	GPM	APD IN	WPD FT.	TAG	MODEL	BTU/H	OUTPUT BTU/H	RECOVERY EFFICIENCY	TANK SIZE (GAL)	REMA	RKS	LOCATION
	<u>A</u> A	VH18HAC2	600	.10	1/5	120	1	13740	10569	.10	8739	1	.05	1.5	1B	POLARIS DVPB35	100000	94000	94%	34	SPLIT	SYSTEM	1 ST. FL 1 BR/A
	ŹA	VH18HAC2	600					15274	11749		8398			.2	2B								2 ND. FL 1 BR/B
		VH18HAC2	700					17518	13476		11592			.6	3B					,			1 ST. FL 2 BR/A
	4A	VH18HAC2	700					17530	13485		14053				<b>4B</b>								1 ST. FL 2 BR/B
	Ź5A	VH24HAC2	800					19086	14681		11743		at .		<u>∕5</u> B								3 BR/B
	6A	VH18HAC2	700					17292	13302		13456				€B								1 ST. FL D2 H.C.
	ŹÀ	VH18HAC2	700					17813	13702		12412				∕b}								1 ST. FL D2
	<u>/8</u> A	VH24HAC2	800					20529	15789		13594				8B								1 ST. FL D3
	<u>∕</u> 9A	VH18HAC2	700					17512	13470		13470				9B			:					1 ST. FL D3 H.C.
		VH24HAC2	800					18253	14041		16622			V									1 ST. FL F
	<u></u>	VH24HAC2	850					25183	19371		17856	2		1.9									1 ST. FL D4
		VH48HAC2	1835	.175				48288	30446		34600	4		1.2									REC. BLDG
		VH48HAC2	1880	.1				44730	33295		31600												REC. BLDG
	<b>14A</b>	NOT USED													14B								REC. BLDG
		40QB060	2000	.29	3/4	240	1	59978	41608	.10	36800	4.6	.05	7.1									ADMIN. BLDG
	16A	40QB048	1600	.31	1/2			47700	31928		30300	3.8		4.8	16B								ADMIN. BLDG
·	17A	40QB060	2000	.29	3/4			63396	41760		42800	5.4		7.9									ADMIN. BLDG

REGISTER, GRILLE, & DIFFUSER SCHEDULE (CONTINUED)

10x6

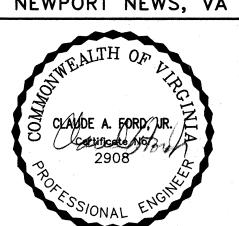8x6

10x6

16x4

24x14

36x36

STEEL ALUMINUM

SIZE IN. MAX PD IN H20 REMARKS

.022

.031

O' DEFLECTION

45° DEFLECTION

MODEL SERVICE MATERIAL

SUPPLY GRILLE SUPPLY REGISTER

RETURN

H4002

H4002D

NOTES: (1) FAN COIL MODELS 1A THRU 13A BASED ON MOR-FLO/AMERICAN; FAN COIL UNITS 15A THRU 17 BASED ON CARRIER.

(2) WATER HEATERS BASED ON MOR-FLO/AMERICAN.

	REC	SISTEF	R, GRI	LLE, 8	c DIFF	TUSER SC	HEDULE
TAG	MODEL	SERVICE	MATERIAL	FINISH	SIZE IN.	MAX PD IN H2O	REMARKS
A	H4002D	SUPPLY REGISTER	STEEL	ALUMINUM	8x4	.042	45° DEFLECTION
B					16x4		
0					18x4		
D					20x4		
Ē					12x4		
F	5800	DIFFUSER	ALUMINUM	OFF-WHITE	6 <b>"</b> ø	.020	ROUND NECK
G					8"ø	,	
J	MI-5000	DIFFUSER	ALUMINUM	OFF-WHITE	6x6	.01	4 WAY W/OBD
K					9x9	.05	
M					12x12	.03	
N					15x15	.03	
P	RH	RETURN			24×24	.022	W/OBD
R					18x18	.031	
S					12x12	.031	
Ü					16x16	.040	
$\bigcirc$					8×8	.040	
W	RAF				18x18	.018	1" T.A. FILTER
$\otimes$	ccs	EXHAUST		ALUMINUM	6x6	.031	
$\bigcirc$					8x8	.031	
Z					10×10		

NOTES: (1) ALL MODEL NOS. BASED ON METALAIRE

MU MAKE UP WATER	
——————————————————————————————————————	
RL REFRIGERANT LIQUID	
POINT OF CONNECTION NEW TO EXISTING	
—— PC —— PUMPED CONDENSATE	
EXISTING PIPING, DUCT, EQUIPMENT, ETC. TO BE	
REMOVED	
POINT OF DEMOLITION LIMIT	
——————————————————————————————————————	
PRESSURE RELIEF VALVE	•
CHECK VALVE	
GATE VALVE	
GLOBE VALVE	
COMBINATION BALANCING AND SHUTOFF VALVE WIT PRESSURE TAPS (GLOBE TYPE)	H
UNION	
O PIPING TURNING UP	
DOWNWARD SLOPE	
DIRECTION OF FLOW	
The strainer	·
AUTOMATIC AIR VENT (AV)	
PRESSURE GUAGE	
THERMOMETER	
MICKWOWLICK	
(T) THERMOSTAT	· ·
BALANCING DAMPER (MULTI-LEAF)	
ELBOW WITH TURNING VANES	
FLEXIBLE CONNECTION	
CCC FLEXIBLE DUCT	•
SUPPLY DUCT SECTION	
RETURN DUCT SECTION	
DEMOLITION NOTE	
1 NEW WORK NOTE	
FAN COIL UNIT MARK - SEE SCHEDULE THIS SHE	ET
WATER HEATER UNIT MARK - SEE SCHEDULE THIS	S SHEE
P-1 PUMP TAG - SEE SCHEDULE ON SHEET M19	
EF-1 EXHAUST FAN TAG - SEE SCHEDULE ON SHEET I	M19
CU-1 CONDENSING UNIT TAG - SEE SCHEDULE ON SHE	
AHU-1 AIR HANDLER UNIT TAG - SEE SCHEDULE ON SH	
GRILLE, REGISTER, OR DIFFUSER TAG — CFM AS I  — SEE SCHEDULE THIS SHEET  U.O.N. UNLESS OTHERWISE NOTED	HOILD
O.O.IN. DINCESS OTHERWISE INCIED	

COMPREHENSIVE RENOVATION

NEWPORT NEWS, VA

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Sheets

Date: JANUARY **31**, 1991

Project No: 90006

LEGEND, & SCHEDULES

NOTED

VA 3-2 MARSHALL

COURTS

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Sheet No:

LEGEND

#### AIR HANDLING UNIT SCHEDULE **FILTERS** FAN HOT WATER COIL DX COOLING COIL ENTERING AIR LEAVING AIR SAT. SUC. PRESS. G. MBH EADB LADB REMARKS | VOLTS | PHASE | TYPE | SIZE WPD ESP GPM **EWT** CARRIER VERTICAL D.T. MODEL 0.25 950 6.0 1.5 230 TA 0.20 | 128.5 140 0.2 137.8 | 80.7 82.7 8: 180 3390 1400 66 48 AHU-1 CLIMATE CHANGER #8. CARRIER MODEL 40 YA 060 0.20 1050 4.2 3/4 120 0.7 230 TA 52.7 39.1 78 65 45°F 0.10 35 64.7 220 56 49 80 10 140 2000 AHU-2

NOTE: HOT WATER COIL FOR AHU-2 SHALL BE DUCT MOUNTED.

AIR COOLED CONDENSING UNIT SCHEDULE												
TAG	MODEL	COOLING	ELECTRICAL			COMP.	AMBIENT	REMARKS				
	MODEL	MBH	FLA	VOLT	PH	STEPS	TEMP.					
CU-1	CARRIER 38TH018	17.6	10.1	230	1	1	95 <b>°</b>	UNIT D2 H.C. SEE 🛕				
CU-2	CARRIER 38TH018							UNIT D3 H.C. SEE 🛕				
CU-3	CARRIER 38TH048	48.0	24.2					REC. BLDG. SEE 12				
CU-4	CARRIER 38TH048							REC. BLDG. SEE 13				
CU-5	EXISTING UNIT							REC. BLDG SEE AHU #1				
CU-6	CARRIER 38TH060	52.7	32.2	230	3	1		REC. BLDG. SEE AHU #2				
CU-7	CARRIER 38TH060	59.9	21.6					ADMIN. BLDG. SEE 15A				
CU-8	CARRIER 38TH048	47.7	19.4					ADMIN. BLDG. SEE 16A				
CU-9	CARRIER 38TH060	63.4	21.6					ADMIN. BLDG. SEE 17A				

NOTE: ALL CONDENSING UNITS SHALL BE COMPLETE W/ STANDARD FACTORY CONTROLS.

P	L	J N	1P	S	Cł	-	E	D	U	L	E

TAG	TYPE	GPM	HEAD	MOTOR DATA			RPM	REMARKS	
		GEW	FT.	HP	VOLT	Ø	1 (1 10)	TALIM MANO	
P-1	IN-LINE CIRCULATING	3.0	10	1/20	120	1	2900	BASED ON B&G UPSTART SLC-25	
P-2	CONDENSATE REMOVAL W/ PAN	1.0	12	1/40	120	1	<u> </u>	BASED ON LITTLE GIANT	
P-3	IN-LINE CIRCULATING	4.0	20	1/3	120	1	1750	BASED ON HD3 SERIES PUMP	
P-4	IN-LINE CIRCULATING	3.5	15	1/4	120	1	1750	BASED ON LD3 SERIES PUMP	

NOTE: ALL MODELS BASED ON BELL & GOSSETT


1	TAG	TYPE	PE DRIVE	,_	CFM	SP IN H <sub>2</sub> O FAN RPM	FAN	MAX	M	OTOR DA	ATA .	REMARKS	
				/E			1	TIP SPEED	HP	VOLTS	PHASE		
1	EF-1	Z6TD	DIRE	СТ	100	0.10	1050	<u> </u>	1/15	120 1		WALL INSTALLATION	
	EF-2	XR82L			300	0.125	1183	2490	1/5			ROOFTOP CENTRIFUGAL	
•	EF-3	26TD			75	·	950		1/25			CEILING CABINET FAN W	
1			1										

W/GRILLE EF-5 NUTONE 8870 1.5AMP 80 THRU THE WALL BATH FAN


EXHAUST FAN SCHEDULE

NOTE: (1) MODEL TYPES BY PENN VENTILATOR UNLESS OTHERWISE NOTED.

(2) CEILING CABINET SHALL BE COMPLETE W/ WALL MOUNTED FAN SWITCH.

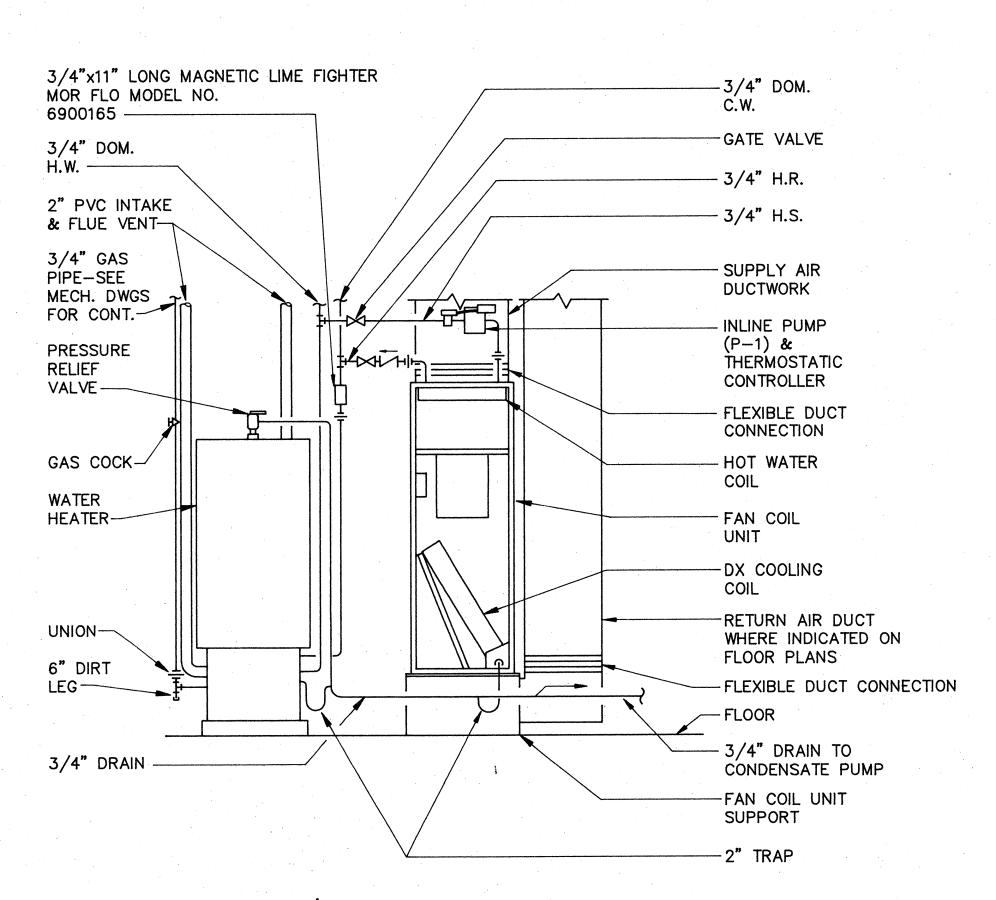

WATER HEATER/FAN COIL UNIT SYSTEM DETAIL NO SCALE

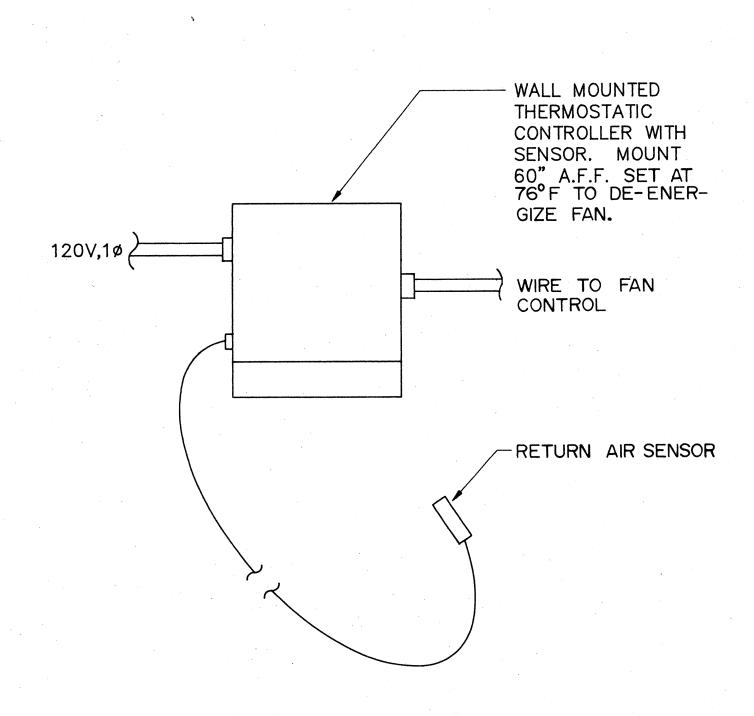


THERMOSTATIC CONTROLLER DETAIL NO SCALE





COMPREHENSIVE RENOVATION VA 3-2 MARSHALL COURTS

NEWPORT NEWS, VA

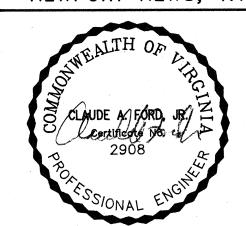


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Project	No:	90006
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SCHEDULES


Sheet No

M19 Sheets NOTE: SLAB DIMENSIONS SHALL EXCEED EQUIPMENT DIMENSIONS BY 6" ON ALL SIDES.

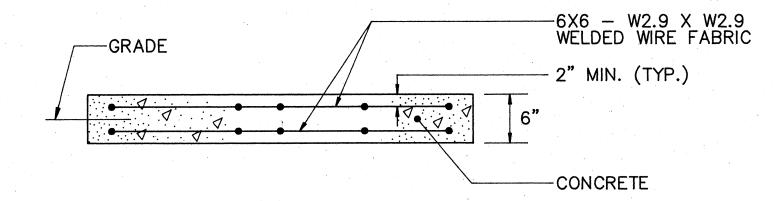


### CONCRETE UNIT SUPPORT SLAB DETAIL

NO SCALE

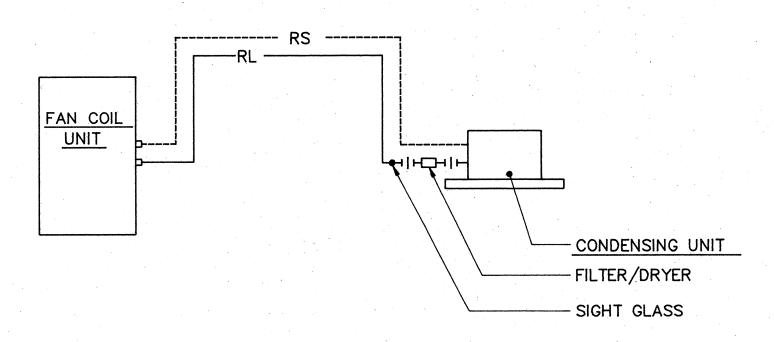

NOTE: REFRIGERANT PIPING SIZES SHALL BE AS INDICATED ON THE PLANS.

### REFRIGERANT PIPING DIAGRAM NO SCALE

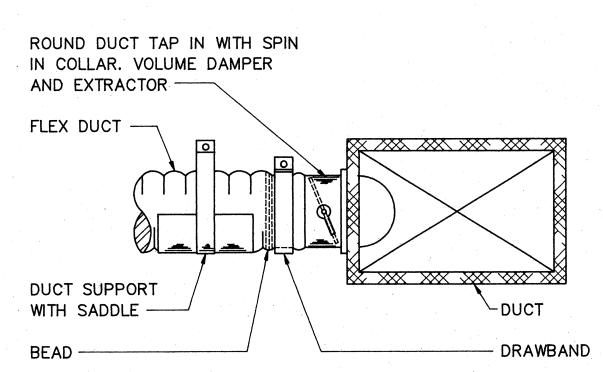



NOTES:

- 1. FLEXIBLE DUCT SUPPORT SHALL HAVE A MAX. 3'-0"
- SPACING. 2. FLEXIBLE DUCT SHALL BE U.L. LISTED.
- 3. SEE SMACA DUCT CONSTRUCTION STANDARDS FOR
- ROUND CONNECTIONS TO RECTANGULAR DUCT.


### FLEXIBLE DUCT INSTALLATION DETAIL

NO SCALE

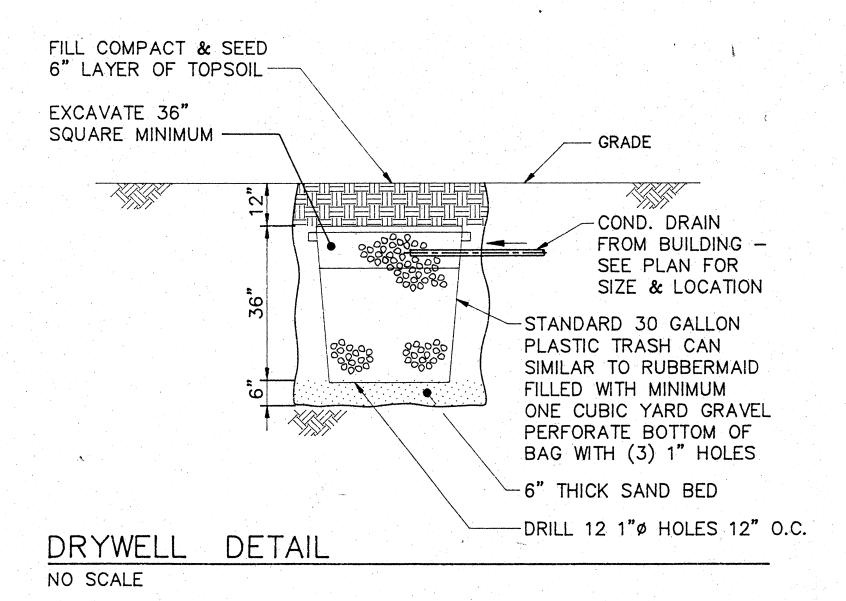

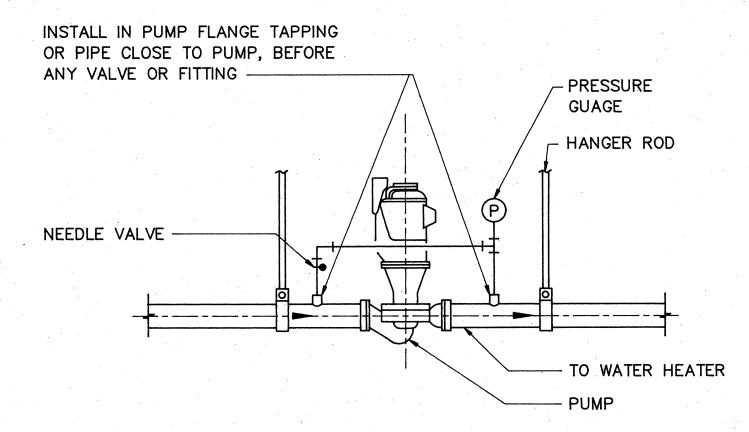

IN-LINE PUMP DETAIL

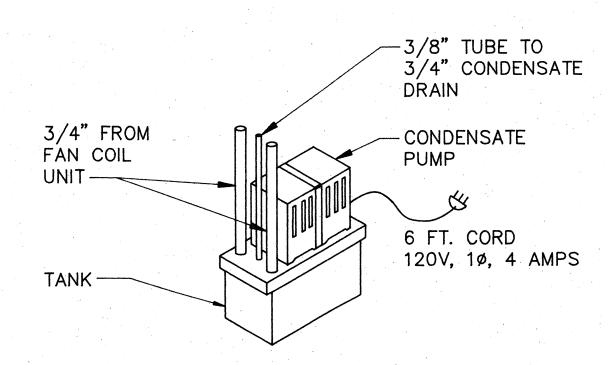

PUMP DETAIL CONDENSATE NO SCALE



COMPREHENSIVE RENOVATION VA 3-2 MARSHALL COURTS

NEWPORT NEWS, VA



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Date: JANUARY 31, 1992


File No:

Project No: 90006

MECHANICAL DETAILS


Sheet No:

M20

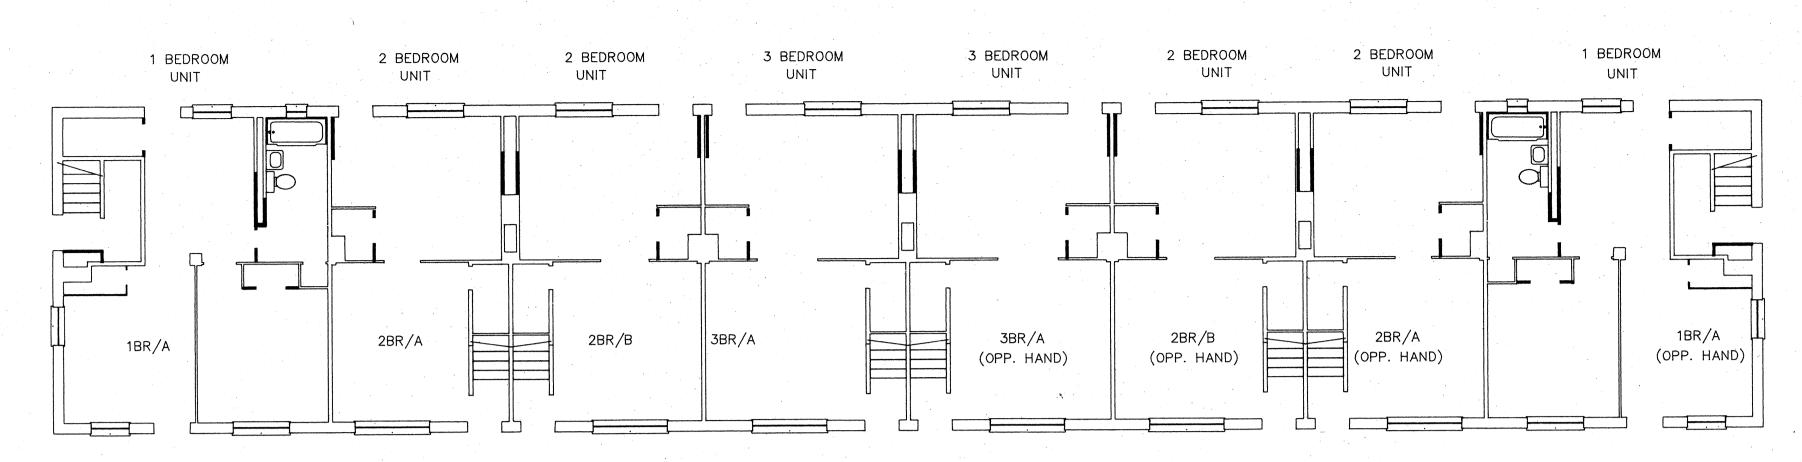

### FIRST FLOOR PLAN - BUILDING "B"


SCALE: 1/8" = 1'-0"

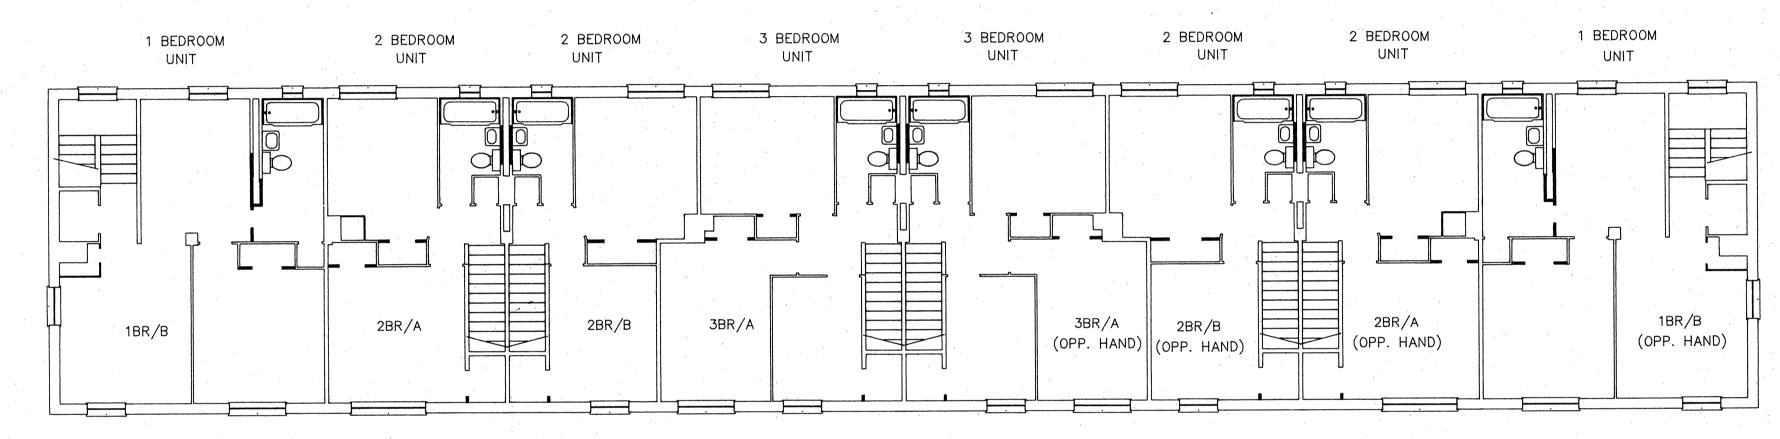



### SECOND FLOOR PLAN - BUILDING "B"


SCALE: 1/8" = 1'-0"

SCALE: 1/4" = 1'-0"

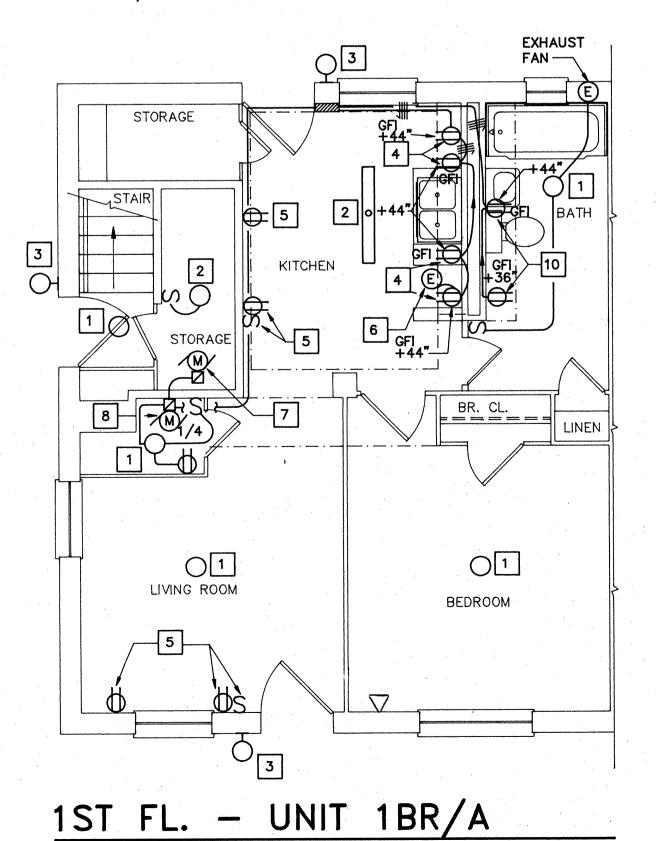

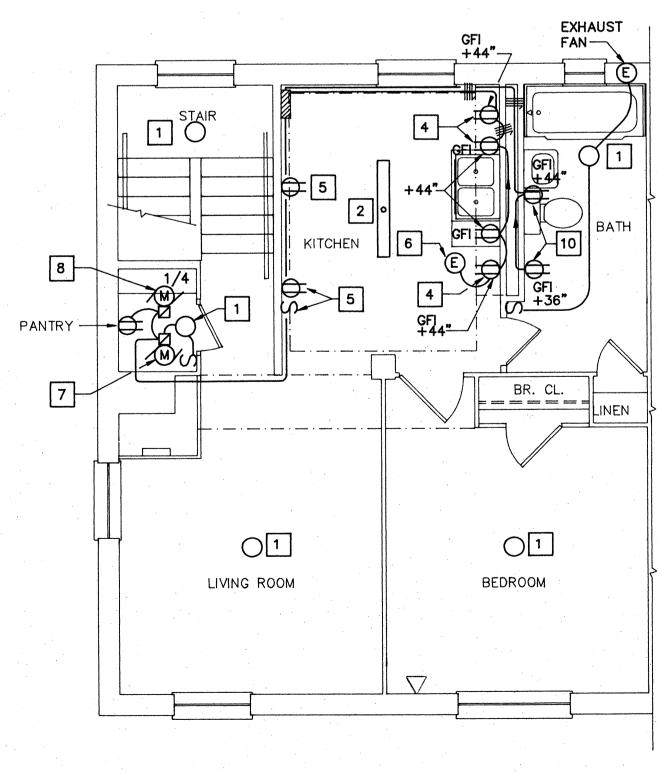

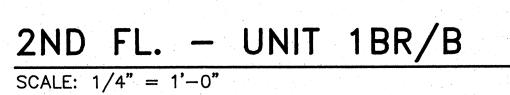

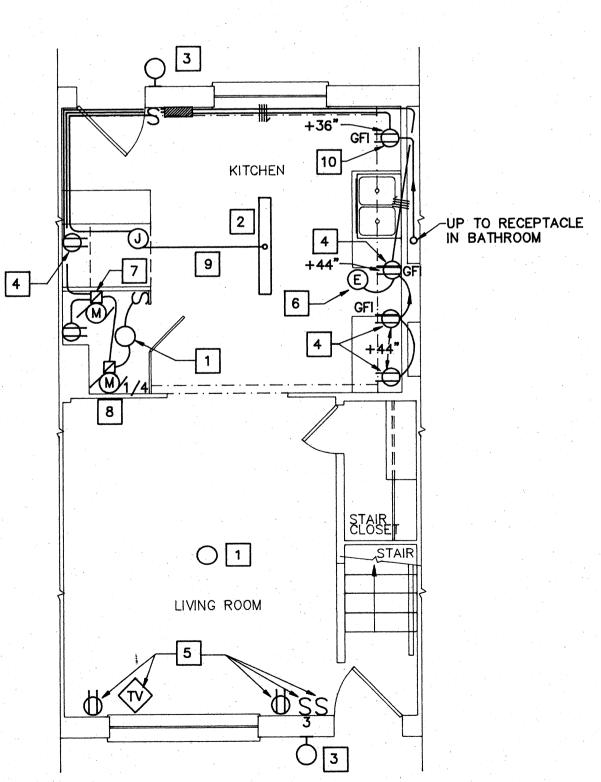

1ST FL. - UNIT 2BR/A

SCALE: 1/4" = 1'-0"

### ☐ NEW WORK NOTES

- PROVIDE COMPACT FLUORESCENT TYPE LIGHT FIXTURE WITH 3-13W LAMPS, EQUAL TO LIGHTWAY INDUSTRIES CAT. NO. C39LP. CONNECT TO EXISTING CIRCUIT SEE DEMOLITION NOTE 1.
- 2. EXISTING LIGHT FIXTURE AT NEW POSITION SEE DEMOLITION NOTE 3.
- 3. PROVIDE COMPACT FLUORESCENT TYPE, PHOTOCELL CONTROLLED LIGHT FIXTURE WITH 1-13W LAMP, FIXTURE SHALL BE EQUAL TO LIGHTWAY INDUSTRIES CAT. NO. SWP13. CONNECT TO EXISTING CIRCUIT SEE DEMOLITION NOTE 4.
- 4. PROVIDE FLUSH MOUNTED KITCHEN RECEPTACLE. CONNECT TO EXISTING KITCHEN RECEPTACLE CIRCUIT IN EXISTING PANEL.
- 5. PROVIDE FLUSH MOUNTED WIRING DEVICES, CONNECT TO EXISTING CIRCUIT SEE DEMOLITION NOTE 9.
- 6. PROVIDE ELECTRICAL CONNECTION TO NEW RANGEHOOD.
- 7. PROVIDE ELECTRICAL CONNECTION TO HOT WATER CIRCULATING PUMP.
- 8. PROVIDE ELECTRICAL CONNECTION TO AIR HANDLING UNIT.
- 9. REUSE EXISTING CONCEALED CONDUIT BETWEEN LIGHT FIXTURE AND DEMOLISHED WALL. EXTEND CIRCUIT AS NECESSARY.
- 10. PROVIDE FLUSH MOUNTED RECEPTACLE. CONNECT TO EXISTING PANEL. PROVIDE 20A, 1P CIRCUIT BREAKER IN THE EXISTING PANEL.

### GENERAL NOTES

- I. ALL CONDUIT SHALL BE CONCEALED AND WIRING DEVICES FLUSH WHERE PRACTICABLE. COORDINATE WITH ARCHITECTURAL WORK FOR DETAILS.
- 2. SURFACE MOUNTED RACEWAY & WIRING DEVICES SHALL MATCH ADJACENT SURFACE COLOR.
- 3. SEE LEGEND ON SHEET E4.
- 4. PROVIDE ONE TELEPHONE OUTLET IN THE KITCHEN AND ONE IN THE MASTER BEDROOM. COORDINATE CONNECTION AND WIRING WITH THE AUTHORITIES.



COMPREHENSIVE RENOVATION OF VA 3-2 MARSHALL COURTS

NEWPORT NEWS, VA



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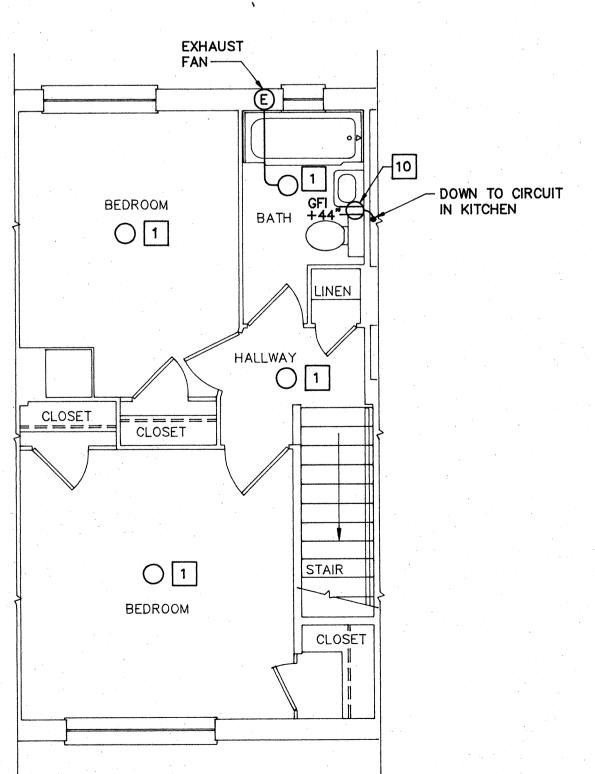
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Project No: 90006

BUILDING
TYPE B —
FLOOR PLANS
(NEW WORK)


Sheet No:

E5 Sheets




2ND FL. — UNIT 2BR/A

SCALE: 1/4" = 1'-0"

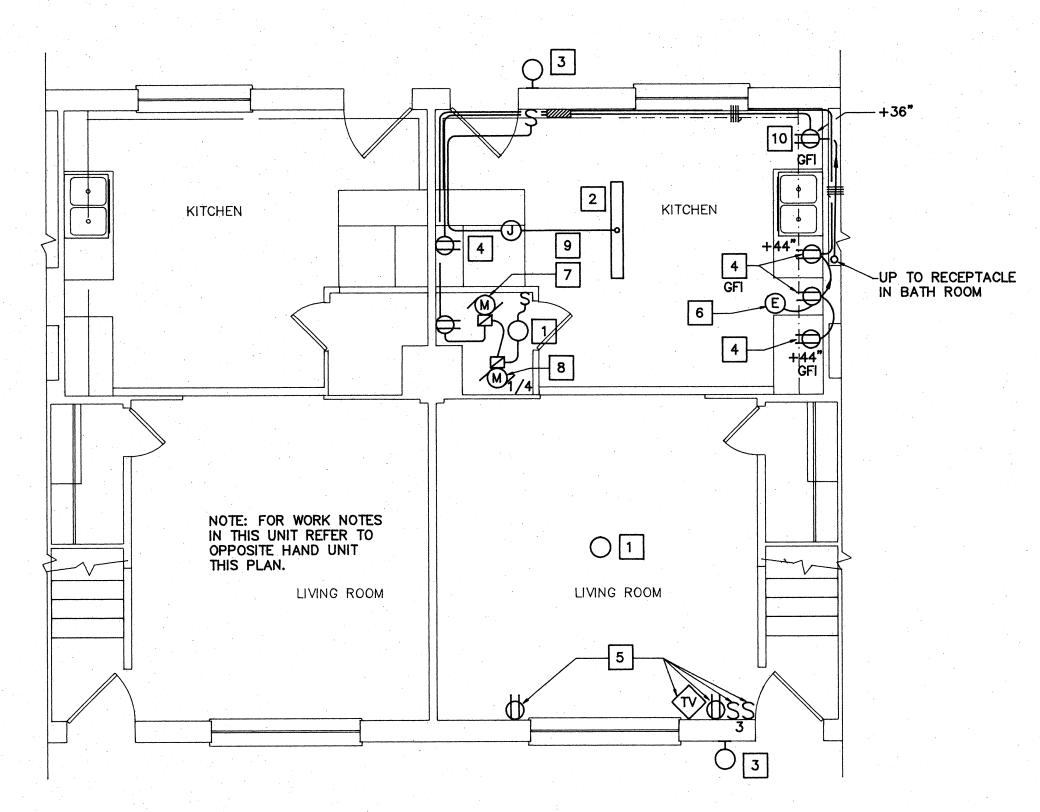

1ST FL. - UNIT 2BR/B & 3BR/A

SCALE: 1/4" = 1'-0"

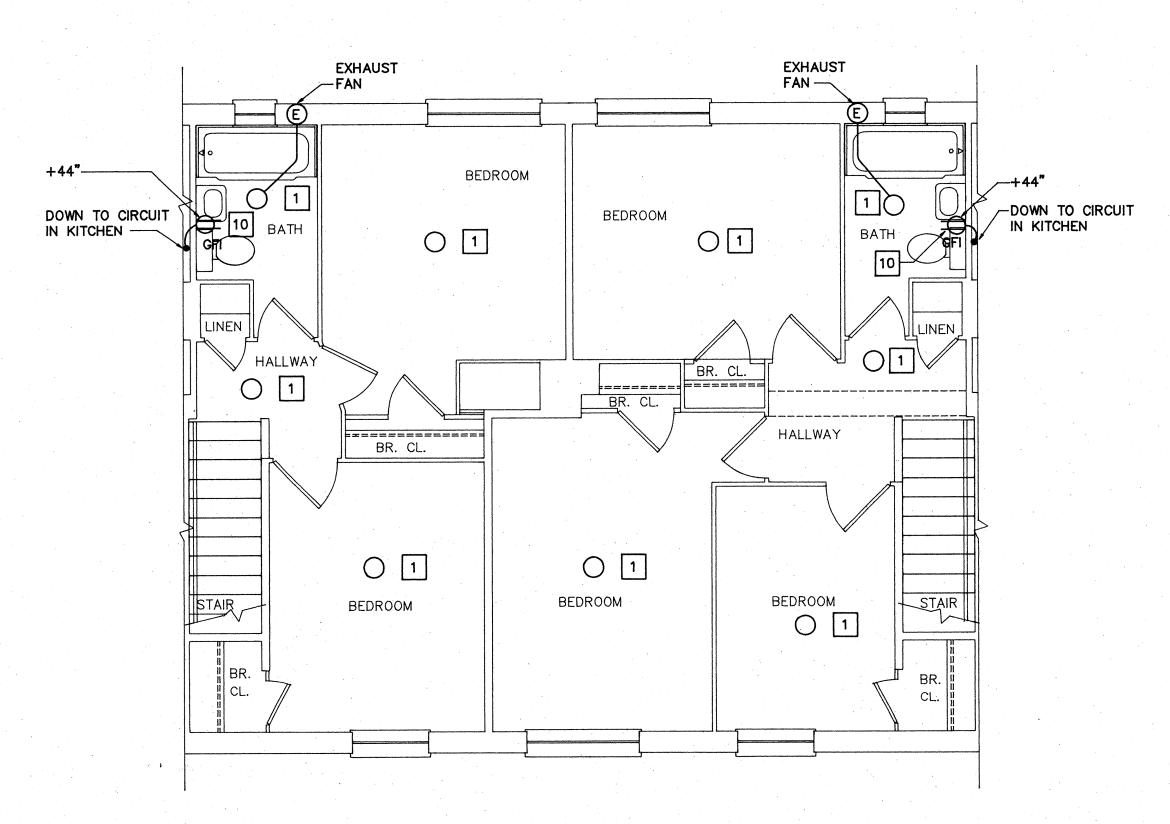


2ND FL. - UNIT 2BR/B & 3BR/A

### ☐ NEW WORK NOTES

- 1. PROVIDE COMPACT FLUORESCENT TYPE LIGHT FIXTURE WITH 3-13W LAMPS, EQUAL TO LIGHTWAY INDUSTRIES CAT. NO. C39LP. CONNECT TO EXISTING CIRCUIT. SEE DEMOLITION NOTE 1 AND GENERAL NOTE 4
- 2. EXISTING LIGHT FIXTURE AT NEW POSITION SEE DEMOLITION NOTE 3.
- 3. PROVIDE COMPACT FLUORESCENT TYPE, PHOTOCELL CONTROLLED LIGHT FIXTURE WITH 1-13W LAMP, FIXTURE SHALL BE EQUAL TO LIGHTWAY INDUSTRIES CAT. NO. SWP13. CONNECT TO EXISTING CIRCUIT SEE DEMOLITION NOTE 4.
- 4. PROVIDE FLUSH MOUNTED RECEPTACLE. CONNECT TO EXISTING RECEPTACLE CIRCUIT IN EXISTING PANEL.
- 5. PROVIDE FLUSH MOUNTED WIRING DEVICES, CONNECT TO EXISTING CIRCUIT SEE DEMOLITION NOTE 9.
- 6. PROVIDE ELECTRICAL CONNECTION TO NEW RANGEHOOD.
- 7. PROVIDE ELECTRICAL CONNECTION TO HOT WATER CIRCULATING PUMP.
- 8. PROVIDE ELECTRICAL CONNECTION TO AIR HANDLING UNIT.
- 9. REUSE EXISTING CONCEALED CONDUIT BETWEEN LIGHT FIXTURE AND DEMOLISHED WALL. EXTEND CIRCUIT AS NECESSARY.
- 10. PROVIDE FLUSH MOUNTED RECEPTACLE. CONNECT TO EXISTING PANEL. PROVIDE 20A, 1P CIRCUIT BREAKER IN THE EXISTING PANEL.

### GENERAL NOTES


- 1. ALL CONDUIT SHALL BE CONCEALED AND WIRING DEVICES FLUSH WHERE PRACTICABLE. COORDINATE WITH ARCHITECTURAL WORK FOR DETAILS.
- 2. SURFACE MOUNTED RACEWAY SHALL MATCH ADJACENT SURFACE COLOR.
- 3. SEE LEGEND ON SHEET E4.
- 4. PROVIDE ONE TELEPHONE OUTLET IN THE KITCHEN AND ONE IN THE MASTER BEDROOM. COORDINATE CONNECTION AND WIRING WITH THE AUTHORITIES.

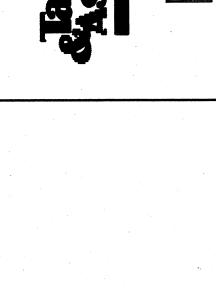



COMPREHENSIVE RENOVATION OF VA 3-2 MARSHALL COURTS

NEWPORT NEWS, VA

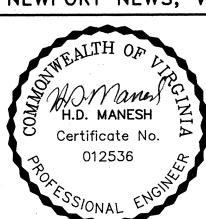

Designe	d: PG					
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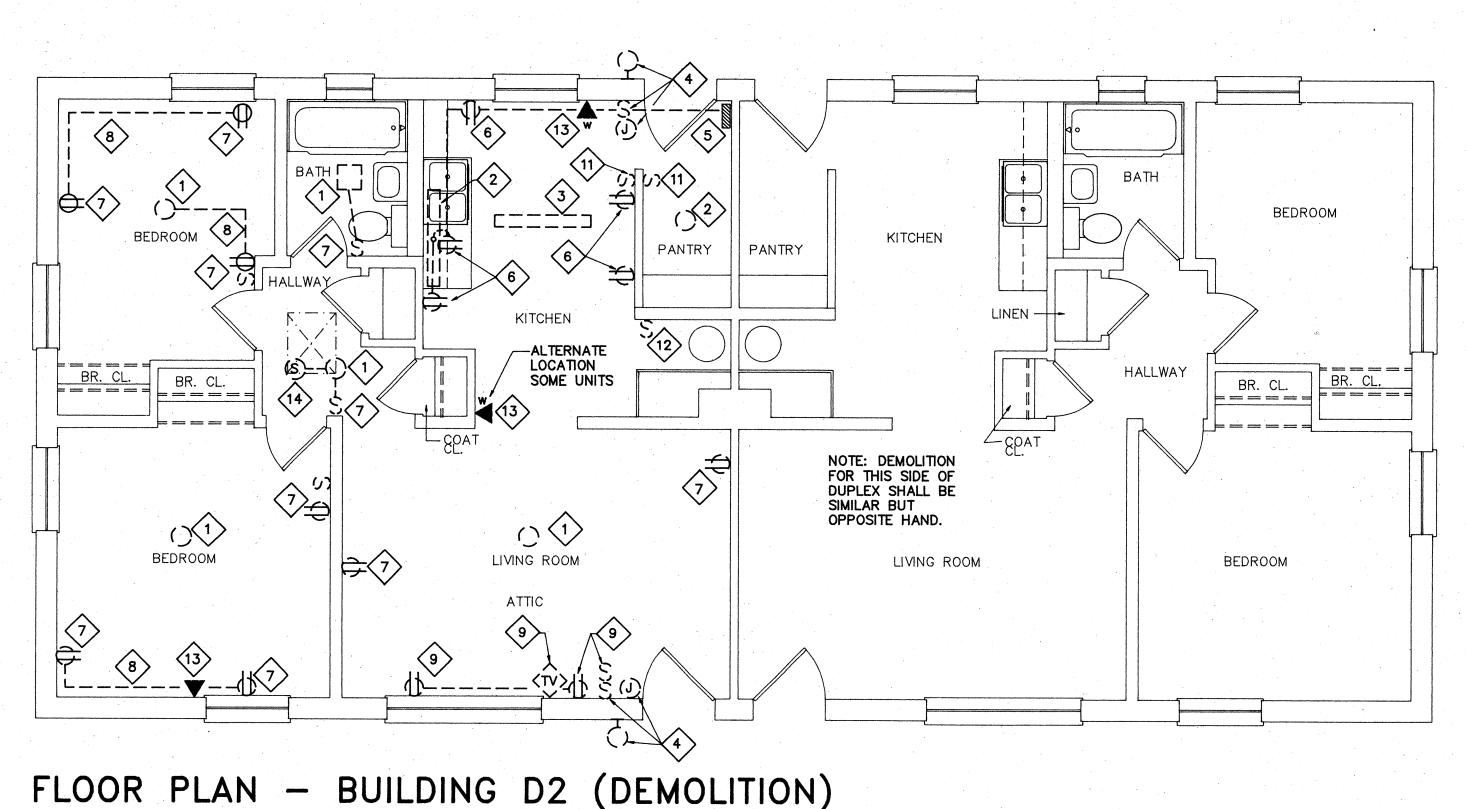
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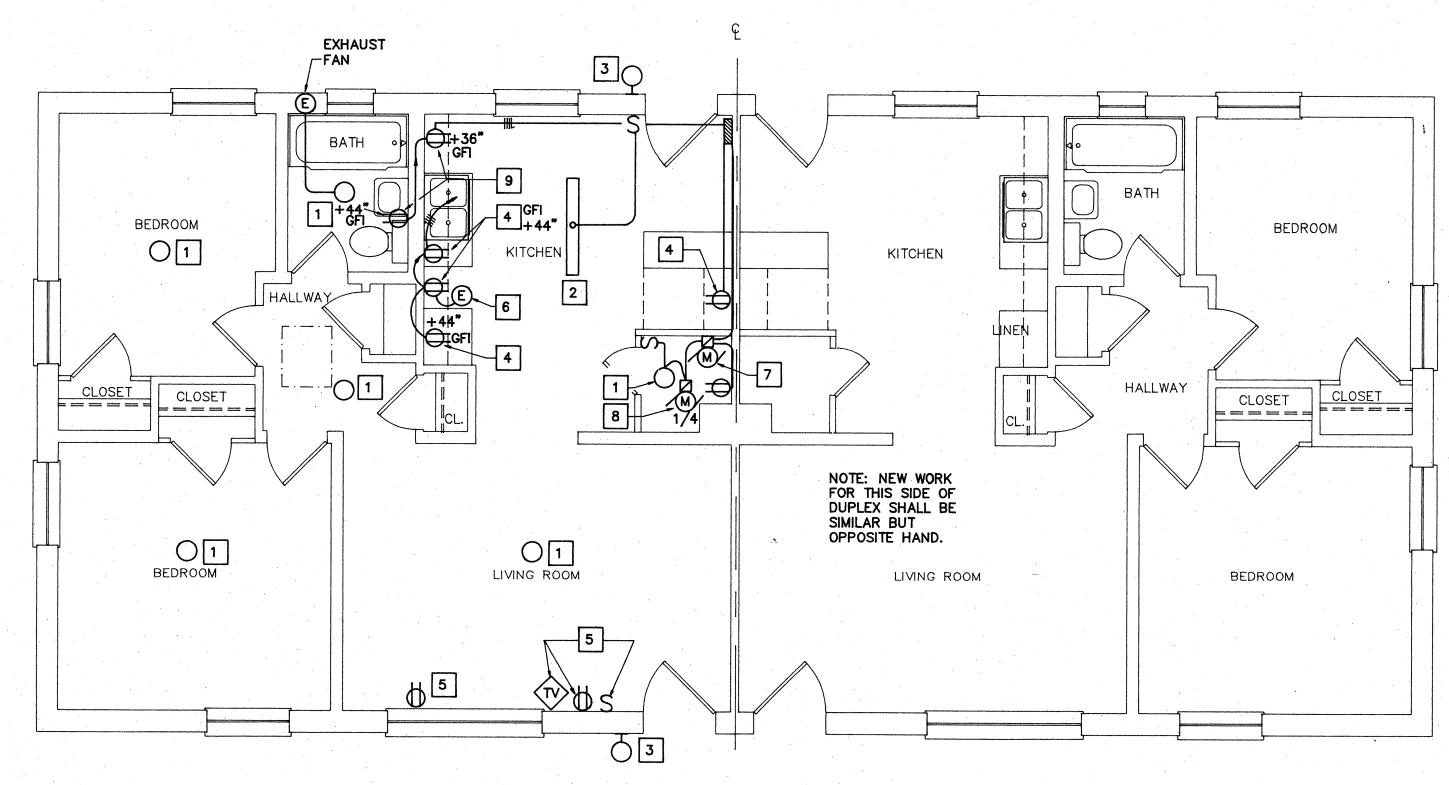
Project No: 90006

BUILDING TYPE B — FLOOR PLANS (NEW WORK)

E6 Sheets

Sheet No:





FLOOR PLAN - BUILDING D2 (NEW WORK)

SCALE: 1/4" = 1'-0"

### ○ DEMOLITION NOTES

- REMOVE LIGHT FIXTURE. EXISTING CIRCUIT TO REMAIN FOR NEW LIGHT FIXTURE INSTALLATION.
- 2. REMOVE LIGHT FIXTURE WITH ASSOCIATED CONDUIT AND WIRING.
- 3. RELOCATE LIGHT FIXTURE. EXTEND EXISTING CIRCUIT AS NECESSARY. SEE NEW WORK FOR LOCATION.
- 4. REMOVE LIGHT FIXTURE WITH ASSOCIATED SWITCH. EXISTING CIRCUIT TO REMAIN FOR NEW PHOTOCELL CONTROL LIGHT FIXTURE.
- 5. EXISTING PANEL TO REMAIN. REMOVE LEAD BASE PAINT. SEE ABATEMENT
- 6. REMOVE RECEPTACLE WITH ASSOCIATED CONDUIT AND WIRING. RE-USE EXISTING CIRCUIT TO SERVE NEW RECEPTACLES.
- REMOVE WIRING DEVICE TO FACILITATE ARCHITECTURAL WORK.

  RE-INSTALL NEW WIRING DEVICE AFTER ARCHITECTURAL WORK IS COMPLETED. PROVIDE EXTENSION RING AS NECESSARY. SEE GENERAL NOTES THIS SHEET.
- . REMOVE ALL SURFACE MOUNTED CONDUIT AND RACEWAY. REINSTALL NEW CONCEALED CONDUIT OR SURFACE MOUNTED RACEWAY (WIREMOLD). SEE GENERAL NOTE 7 THIS SHEET.
- 9. REMOVE SURFACE MOUNTED WIRING DEVICE. EXISTING CIRCUIT TO REMAIN. SEE NEW WORK NOTE 5.
- 10. REMOVE JUNCTION BOX WITH ASSOCIATED CONDUIT & WIRING.
- 11. REMOVE LIGHT SWITCH WITH ASSOCIATED CONDUIT AND WIRING.
- 12. REMOVE SWITCH AND WIRING FOR EXISTING HEATING UNIT. RE-USE EXISTING CIRCUIT FOR NEW HEATING SYSTEM.
- 13. REMOVE TEL. OUTLET TO FACILITATE ARCHITECTURAL WORK. RE-INSTALL AFTER ARCHITECTURAL WORK IS COMPLETE. EXTEND EXISTING WIRING AS NECESSARY.
- 14. REMOVE 120V SMOKE DETECTOR TO FACILITATE ARCHITECTURAL WORK. RE-INSTALL AFTER ARCHITECTURAL WORK IS COMPLETE.

### NEW WORK NOTES

- PROVIDE COMPACT FLUORESCENT TYPE LIGHT FIXTURE WITH 3-13W LAMPS, EQUAL TO LIGHTWAY INDUSTRIES CAT. NO. C39LP. CONNECT TO EXISTING CIRCUIT SEE DEMOLITION NOTE 1.
- EXISTING LIGHT FIXTURE AT NEW LOCATION SEE DEMOLITION NOTE 3.
- PROVIDE COMPACT FLUORESCENT TYPE, PHOTOCELL CONTROLLED LIGHT FIXTURE WITH 1-13W LAMP, FIXTURE SHALL BE EQUAL TO LIGHTWAY INDUSTRIES CAT. NO. SWP13. CONNECT TO EXISTING CIRCUIT SEE DEMOLITION NOTE 4.
- PROVIDE FLUSH MOUNTED RECEPTACLE. CONNECT TO EXISTING KITCHEN RECEPTACLE CIRCUIT IN EXISTING PANEL.
- PROVIDE FLUSH MOUNTED WIRING DEVICES, CONNECT TO EXISTING CIRCUIT SEE DEMOLITION NOTE 9.
- 6. PROVIDE ELECTRICAL CONNECTION TO NEW RANGEHOOD.
- 7. PROVIDE ELECTRICAL CONNECTION TO HOT WATER CIRCULATING PUMP.
- PROVIDE ELECTRICAL CONNECTION TO AIR HANDLING UNIT.
- PROVIDE FLUSH MOUNTED RECEPTACLE. CONNECT TO EXISTING PANEL. PROVIDE 20A, 1P CIRCUIT BREAKER IN THE EXISTING PANEL.

### GENERAL NOTES


- PROVIDE ALL ELECTRICAL DEMOLITION WORK NECESSARY TO INSTALL NEW WORK. ELECTRICAL CONTRACTOR SHALL REROUTE AND RECONNECT ANY CIRCUITS THAT WILL REMAIN IN USE BUT INTERFERE WITH NEW CONSTRUCTION.
- ALL EXISTING CONDUITS THAT WILL NOT BE REUSED SHALL BE REMOVED WHERE THEY WILL BE EXPOSED AFTER COMPLETION OF THE CONSTRUCTION. ALL OTHERS MAY BE ABANDONED IN WALLS ONLY. CONTRACTOR SHALL REMOVE ALL WIRING FROM ABANDONED CONDUITS, DISCONNECT FROM ALL POWER SOURCES AND PROVIDE BLANK PLATES ON ALL ABANDONED OUTLETS. CUT-OFF ABANDONED CONDUIT 2" BELOW FINISHED FLOOR AND
- MAINTAIN CONTINUITY OF ALL EXISTING CIRCUITS TO REMAIN OR PORTIONS THEREOF AFFECTED BY NEW WORK.
- ALL MATERIALS REMOVED UNDER DEMOLITION (AND NOT TO BE RELOCATED) SHALL BECOME THE PROPERTY OF THE CONTRACTOR AND SHALL BE REMOVED COMPLETELY FROM THE SITE.
- CONTRACTOR SHALL EXERCISE CARE IN REMOVING DEMOLITION ITEMS AND SHALL REPAIR OR REPLACE AT HIS COST ANY DAMAGE CAUSED TO EXISTING CONSTRUCTION AND EQUIPMENT TO REMAIN.
- DRAWINGS ARE BASED ON EXISTING PLANS AND FIELD INVESTIGATION WITHOUT DEMOLITION. CONTRACTOR SHALL VISIT THE EXISTING BUILDING AND FAMILIARIZE HIMSELF WITH EXISTING CONDITIONS AND SHALL EXAMINE ALL RELATED DRAWINGS TO AVOID CONFLICTS.
- ALL CONDUIT SHALL BE CONCEALED AND WIRING DEVICES FLUSH WHERE PRACTICABLE. COORDINATE WITH ARCHITECTURAL WORK.
- 8. SURFACE MOUNTED RACEWAY SHALL MATCH ADJACENT SURFACE COLOR.
- 9. SEE LEGEND ON SHEET E-4.
- IO. PROVIDE ONE TELEPHONE OUTLET IN THE KITCHEN AND ONE IN THE MASTER BEDROOM. COORDINATE CONNECTION AND WRING WITH THE AUTHORITIES.

ELECTRICAL EXPOSED AND PAINTED CONDUIT AND DEVICES HAVE BEEN TESTED AND ARE KNOWN TO CONTAIN LEAD BASED PAINT. ALL ELECTRICAL EXPOSED CONDUIT AND DEVICES SHALL BE HANDLED IN ACCORDANCE WITH SPECIFICATION SECTION 02090 BY THE ABATEMENT CONTRACTOR.



COMPREHENSIVE RENOVATION VA 3-2 MARSHALL COURTS

NEWPORT NEWS, VA

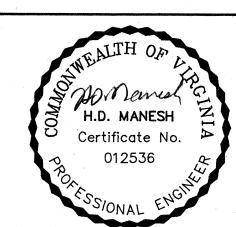

Designed: PG Drawni

Checked: HDM


AS NOTED Scale Date: JANUARY **31**, 1992

File No:

Project No: 90006


BUILDING TYPE D2 -FLOOR PLANS (DEMOLITION & NEW WORK)

Sheet No:

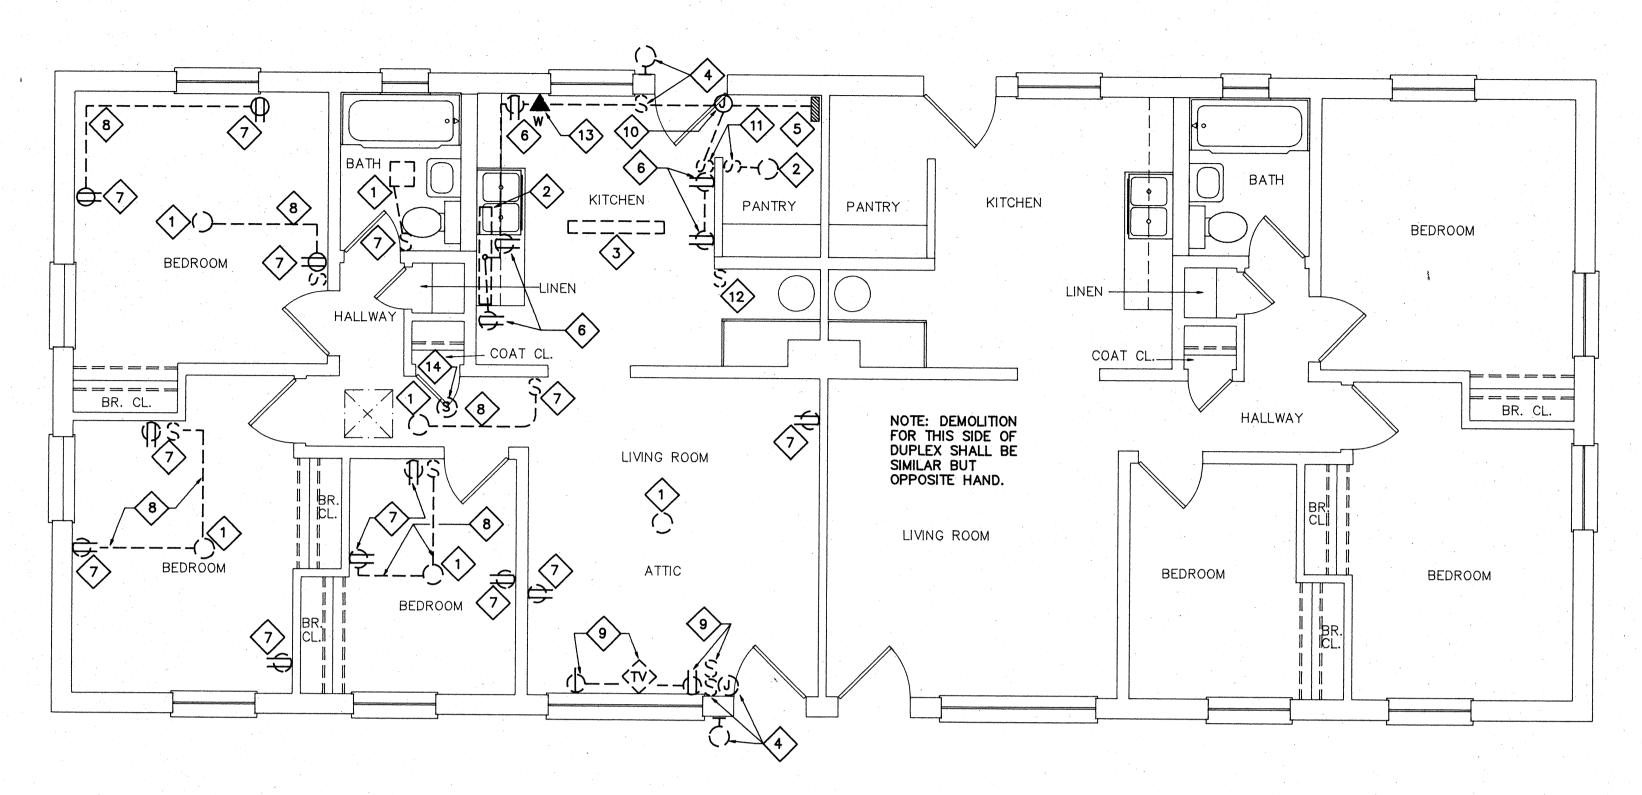

### FLOOR PLAN - BUILDING D3 (DEMOLITION)

SCALE: 1/4" = 1'-0"

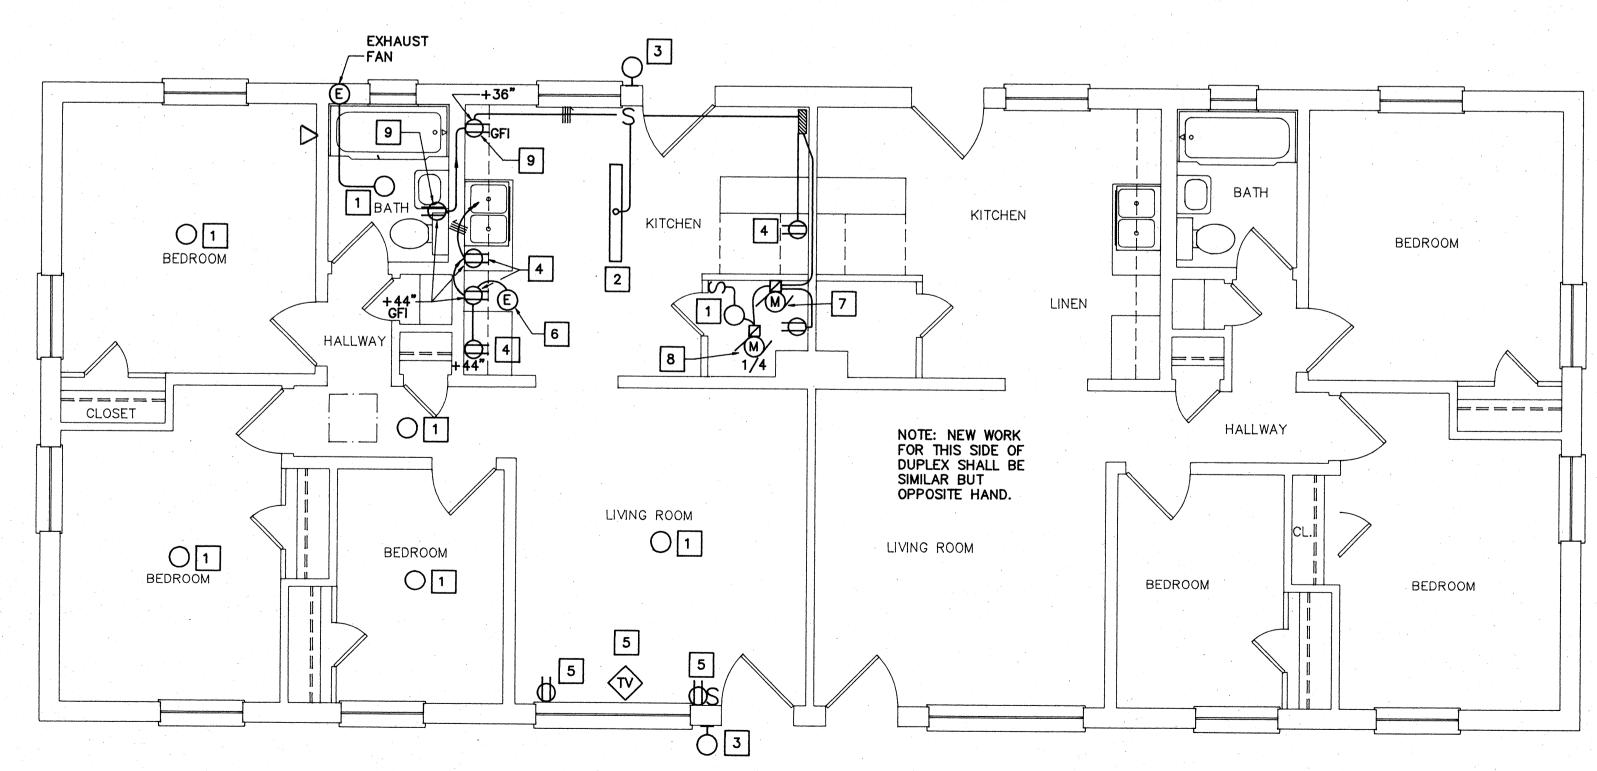

FLOOR PLAN - BUILDING D3 (NEW WORK)

SCALE: 1/4" = 1'-0"

### DEMOLITION NOTES

- I. REMOVE LIGHT FIXTURE. EXISTING CIRCUIT TO REMAIN FOR NEW LIGHT FIXTURE INSTALLATION.
- 2. REMOVE LIGHT FIXTURE WITH ASSOCIATED CONDUIT AND WIRING.
- 3. RELOCATE LIGHT FIXTURE. EXTEND EXISTING CIRCUIT AS NECESSARY. SEE NEW WORK FOR LOCATION.
- 4. REMOVE LIGHT FIXTURE WITH ASSOCIATED SWITCH. EXISTING CIRCUIT TO REMAIN FOR NEW PHOTOCELL CONTROL LIGHT FIXTURE.
- 5. EXISTING PANEL TO REMAIN. REMOVE LEAD BASE PAINT. SEE ABATEMENT NOTE
- 6. REMOVE RECEPTACLE WITH ASSOCIATED CONDUIT AND WIRING. RE-USE EXISTING CIRCUIT TO SERVE NEW RECEPTACLES.
- 7. REMOVE WIRING DEVICE TO FACILITATE ARCHITECTURAL WORK.
  RE-INSTALL NEW WIRING DEVICE AFTER ARCHITECTURAL WORK IS COMPLETED.
  PROVIDE EXTENSION RING AS NECESSARY. SEE GENERAL NOTES.
- 8. REMOVE ALL SURFACE MOUNTED CONDUIT AND RACEWAY. REINSTALL NEW CONCEALED CONDUIT OR SURFACE MOUNTED RACEWAY (WREMOLD). SEE GENERAL NOTE 7.
- 9. REMOVE SURFACE MOUNTED WIRING DEVICE. EXISTING CIRCUIT TO REMAIN. SEE NEW WORK NOTE 5.
- 10. REMOVE JUNCTION BOX WITH ASSOCIATED CONDUIT & WIRING.
- 11. REMOVE LIGHT SWITCH WITH ASSOCIATED CONDUIT AND WIRING.
- 12. REMOVE SWITCH AND WIRING FOR EXISTING HEATING UNIT. RE-USE EXISTING CIRCUIT FOR NEW HEATING SYSTEM.
- 13. REMOVE TEL. OUTLET TO FACILITATE ARCHITECTURAL WORK. RE—INSTALL AFTER ARCHITECTURAL WORK IS COMPLETE. EXTEND EXISTING WIRING AS NECESSARY.
- 14. REMOVE 120V SMOKE DETECTOR TO FACILITATE ARCHITECTURAL WORK. RE-INSTALL AFTER ARCHITECTURAL WORK IS COMPLETE.

### NEW WORK NOTES

- 1. PROVIDE COMPACT FLUORESCENT TYPE LIGHT FIXTURE WITH 3-13W LAMPS, EQUAL TO LIGHTWAY INDUSTRIES CAT. NO. C39LP. CONNECT TO EXISTING CIRCUIT. SEE DEMOLITION NOTE 1.
- EXISTING LIGHT FIXTURE AT NEW LOCATION SEE DEMOLITION NOTE 3.
- PROVIDE COMPACT FLUORESCENT TYPE, PHOTOCELL CONTROLLED LIGHT FIXTURE WITH 1-13W LAMP, FIXTURE SHALL BE EQUAL TO LIGHTWAY INDUSTRIES CAT. NO. SWP13. CONNECT TO EXISTING CIRCUIT SEE DEMOLITION NOTE 4.
- 4. PROVIDE FLUSH MOUNTED RECEPTACLE. CONNECT TO EXISTING KITCHEN RECEPTACLE CIRCUIT IN EXISTING PANEL.
- 5. PROVIDE FLUSH MOUNTED WIRING DEVICES, CONNECT TO EXISTING CIRCUIT SEE DEMOLITION NOTE 9.
- 6. PROVIDE ELECTRICAL CONNECTION TO NEW RANGEHOOD.
- 7. PROVIDE ELECTRICAL CONNECTION TO HOT WATER CIRCULATING PUMP.
- 8. PROVIDE ELECTRICAL CONNECTION TO AIR HANDLING UNIT.
- 9. PROVIDE FLUSH MOUNTED RECEPTACLE. CONNECT TO EXISTING PANEL. PROVIDE 20A, 1P CIRCUIT BREAKER IN THE EXISTING PANEL.

### GENERAL NOTES

- 1. PROVIDE ALL ELECTRICAL DEMOLITION WORK NECESSARY TO INSTALL NEW WORK. ELECTRICAL CONTRACTOR SHALL REPOUTE AND RECONNECT ANY CIRCUITS THAT WILL REMAIN IN USE BUT INTERFERE WITH NEW CONSTRUCTION.
- 2. ALL EXISTING CONDUITS THAT WILL NOT BE REUSED SHALL BE REMOVED WHERE THEY WILL BE EXPOSED AFTER COMPLETION OF THE CONSTRUCTION. ALL OTHERS MAY BE ABANDONED IN WALLS ONLY. CONTRACTOR SHALL REMOVE ALL WIRING FROM ABANDONED CONDUITS, DISCONNECT FROM ALL POWER SOURCES AND PROVIDE BLANK PLATES ON ALL ABANDONED OUTLETS. CUT—OFF ABANDONED CONDUIT 2" BELOW FINISHED FLOOR AND GROUT FLUSH.
- 3. MAINTAIN CONTINUITY OF ALL EXISTING CIRCUITS TO REMAIN OR PORTIONS THEREOF AFFECTED BY NEW WORK.
- 4. ALL MATERIALS REMOVED UNDER DEMOLITION (AND NOT TO BE RELOCATED) SHALL BECOME THE PROPERTY OF THE CONTRACTOR AND SHALL BE REMOVED COMPLETELY FROM THE SITE.
- 5. CONTRACTOR SHALL EXERCISE CARE IN REMOVING DEMOLITION ITEMS AND SHALL REPAIR OR REPLACE AT HIS COST ANY DAMAGE CAUSED TO EXISTING CONSTRUCTION AND EQUIPMENT TO REMAIN.
- 6. DRAWINGS ARE BASED ON EXISTING PLANS AND FIELD INVESTIGATION WITHOUT DEMOLITION. CONTRACTOR SHALL VISIT THE EXISTING BUILDING AND FAMILIARIZE HIMSELF WITH EXISTING CONDITIONS AND SHALL EXAMINE ALL RELATED DRAWINGS TO AVOID CONFLICTS.
- 7. ALL CONDUIT SHALL BE CONCEALED AND WRING DEVICES FLUSH WHERE PRACTICABLE. COORDINATE WITH ARCHITECTURAL WORK.
- 8. SURFACE MOUNTED RACEWAY & WIRING DEVICES SHALL MATCH ADJACENT SURFACE COLOR.
- 9. SEE LEGEND ON SHEET E-4.
- 10. PROVIDE ONE TELEPHONE OUTLET IN THE KITCHEN AND ONE IN THE MASTER BEDROOM. COORDINATE CONNECTION AND WIRING WITH THE AUTHORITIES.

### ABATEMENT NOTE


ELECTRICAL EXPOSED AND PAINTED CONDUIT AND DEVICES HAVE BEEN TESTED AND ARE KNOWN TO CONTAIN LEAD BASED PAINT. ALL ELECTRICAL EXPOSED CONDUIT AND DEVICES SHALL BE HANDLED IN ACCORDANCE WITH SPECIFICATION SECTION 02090 BY THE ABATEMENT CONTRACTOR.



COMPREHENSIVE RENOVATION OF VA 3-2 MARSHALL

COURTS

NEWPORT NEWS, VA

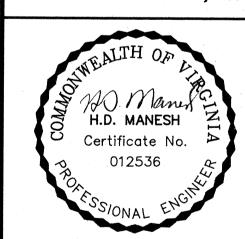

Designed: PG

Drawn: DPM

Checked: HDM

Scale: AS NOTED


Date: JANUARY 31, 1992 File No:

Project No: 90006


BUILDING
TYPE D3 FLOOR PLANS
(DEMOLITION &
NEW WORK)

Sheet No:

E8

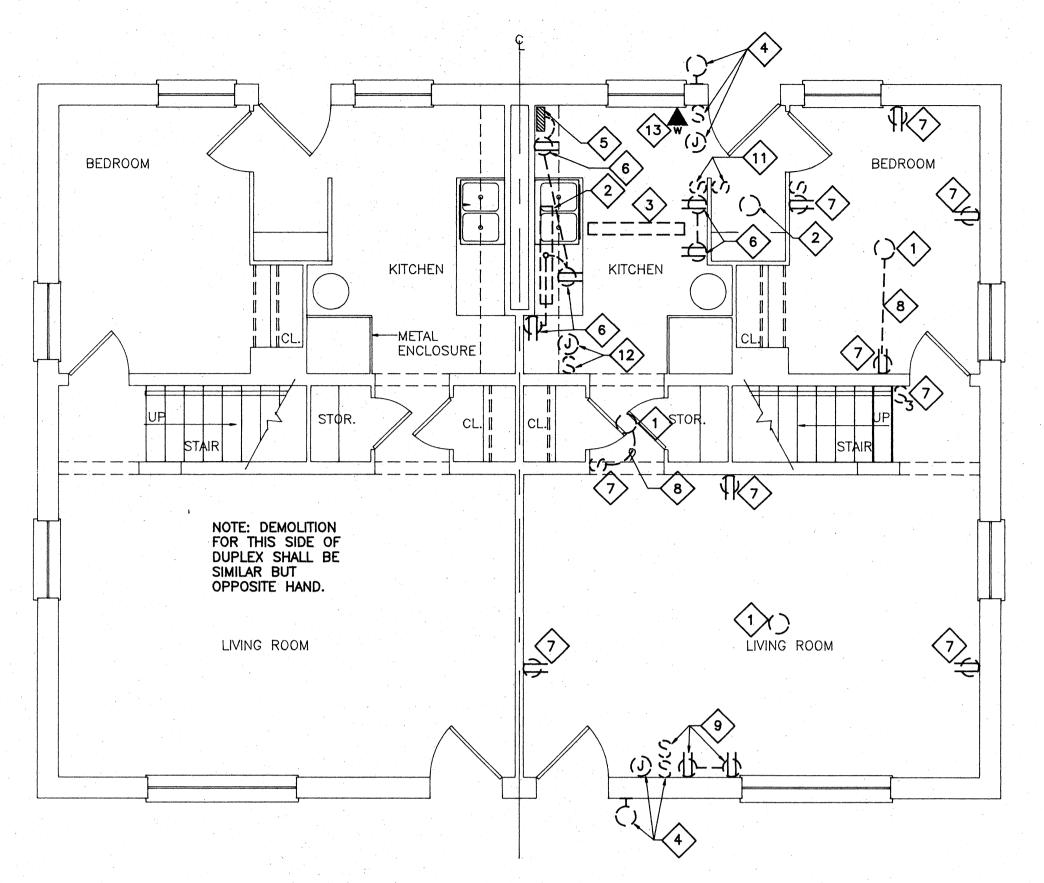



FIRST FLOOR PLAN - BLDG. D4 (DEMOLITION)

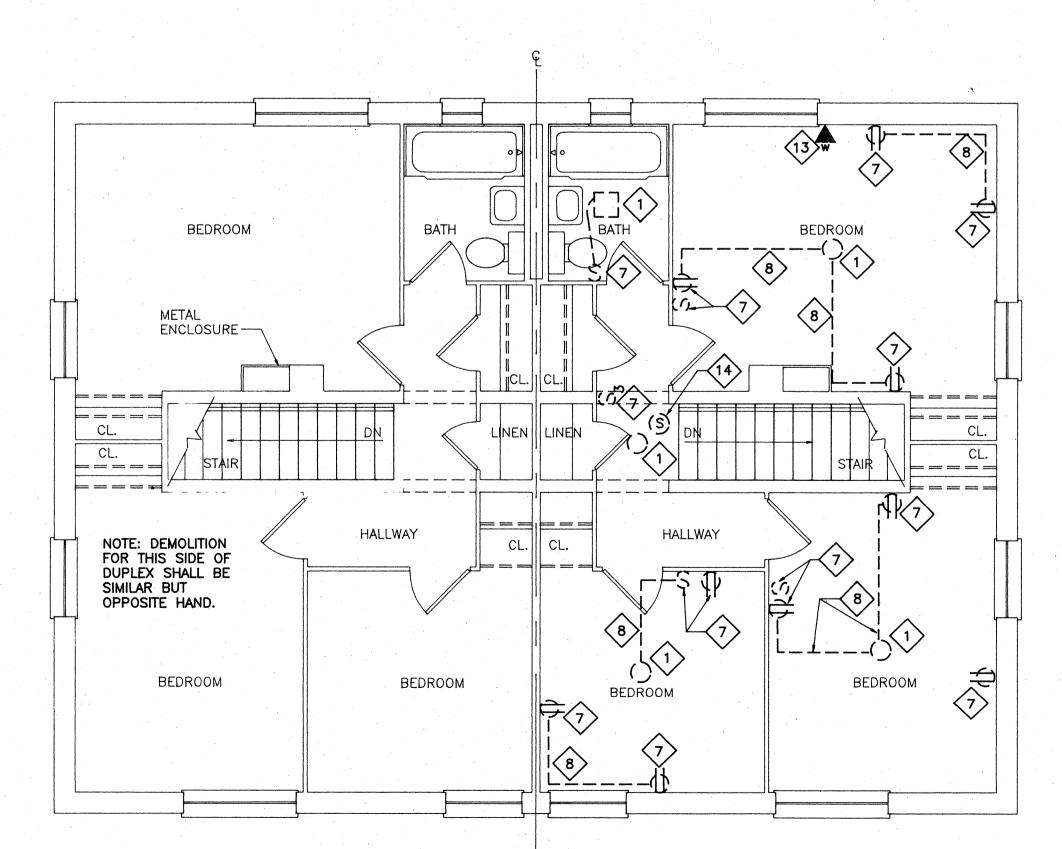

SECOND FLOOR PLAN - BLDG. D4 (DEMOLITION)

SCALE: 1/4" = 1'-0"

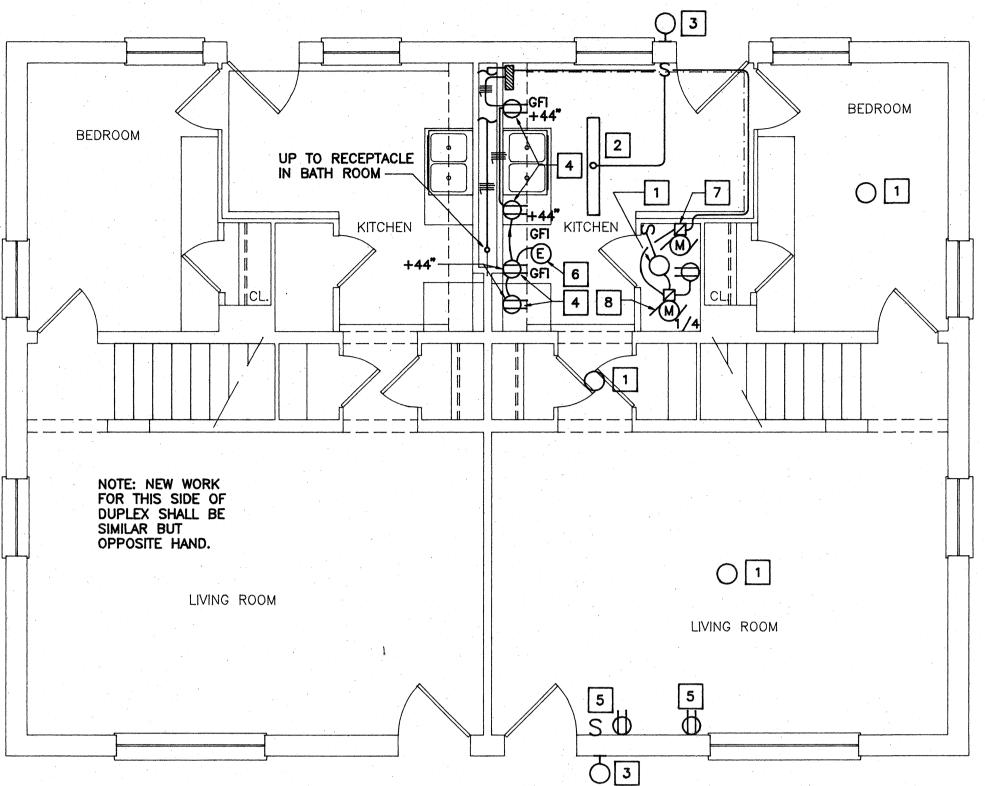

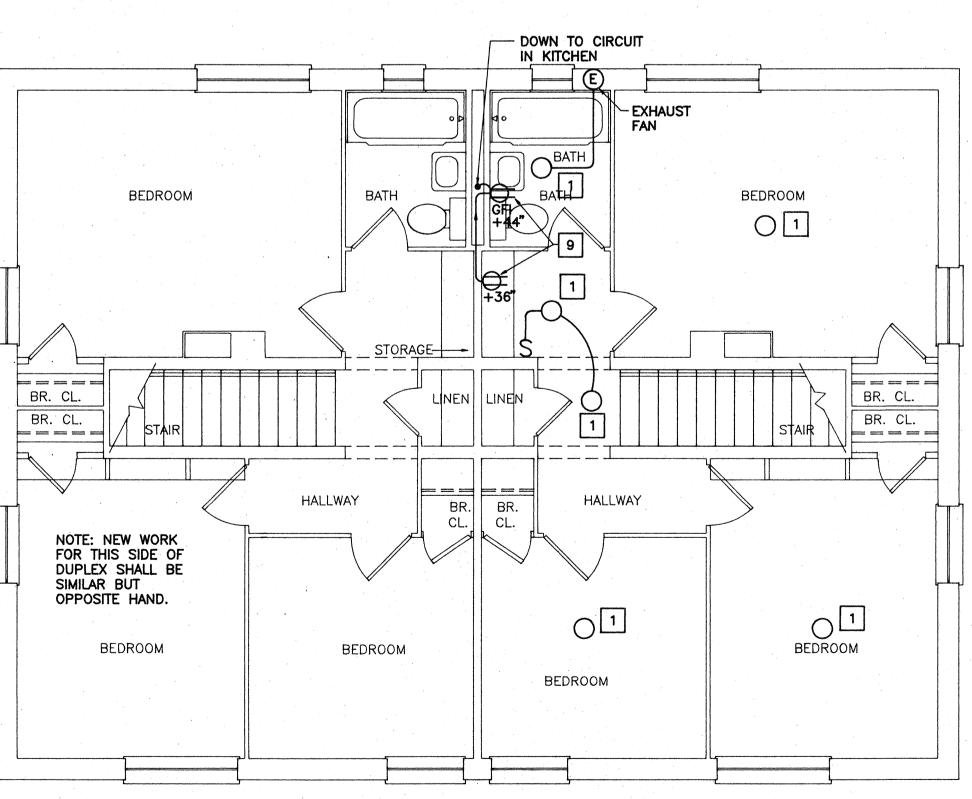

SECOND FLOOR PLAN - BLDG. D4 (NEW WORK)

SCALE: 1/4" = 1'-0"

### DEMOLITION NOTES

- 1. REMOVE LIGHT FIXTURE. EXISTING CIRCUIT TO REMAIN FOR NEW LIGHT FIXTURE INSTALLATION.
- 2. REMOVE LIGHT FIXTURE WITH ASSOCIATED CONDUIT AND WIRING.
- 3. RELOCATE LIGHT FIXTURE. EXTEND EXISTING CIRCUIT AS NECESSARY. SEE NEW WORK FOR LOCATION.
- 4. REMOVE LIGHT FIXTURE WITH ASSOCIATED SWITCH. EXISTING CIRCUIT TO REMAIN FOR NEW PHOTOCELL CONTROL LIGHT FIXTURE.
- 5. EXISTING PANEL TO REMAIN. REMOVE LEAD BASE PAINT. SEE ABATEMENT NOTE.
- 6. REMOVE RECEPTACLE WITH ASSOCIATED CONDUIT AND WIRING. RE-USE EXISTING CIRCUIT TO SERVE NEW RECEPTACLES.
- 7. REMOVE WIRING DEVICE TO FACILITATE ARCHITECTURAL WORK.
  RE-INSTALL NEW WIRING DEVICE AFTER ARCHITECTURAL WORK IS COMPLETED. PROVIDE EXTENSION RING AS NECESSARY. SEE GENERAL NOTES THIS SHEET.
- 8. REMOVE ALL SURFACE MOUNTED CONDUIT AND RACEWAY. REINSTALL NEW CONCEALED CONDUIT OR SURFACE MOUNTED RACEWAY (WIREMOLD). SEE GENERAL NOTE 7 THIS SHEET.
- 9. REMOVE SURFACE MOUNTED WIRING DEVICE. EXISTING CIRCUIT TO REMAIN. SEE NEW WORK NOTE 5.
- 10. REMOVE JUNCTION BOX WITH ASSOCIATED CONDUIT & WIRING.
- 11. REMOVE LIGHT SWITCH WITH ASSOCIATED CONDUIT AND WIRING.
- 12. REMOVE SWITCH AND WIRING FOR EXISTING HEATING UNIT. RE-USE EXISTING CIRCUIT FOR NEW HEATING SYSTEM.
- 13. REMOVE TEL. OUTLET TO FACILITATE ARCHITECTURAL WORK. RE-INSTALL AFTER ARCHITECTURAL WORK IS COMPLETE. EXTEND EXISTING WIRING AS NECESSARY.
- 14. REMOVE 120V SMOKE DETECTOR TO FACILITATE ARCHITECTURAL WORK. RE-INSTALL AFTER ARCHITECTURAL WORK IS COMPLETE.

### NEW WORK NOTES

- PROVIDE COMPACT FLUORESCENT TYPE LIGHT FIXTURE WITH 3-13W LAMPS, EQUAL TO LIGHTWAY INDUSTRIES CAT. NO. C39LP. CONNECT TO EXISTING CIRCUIT. SEE DEMOLITION NOTE 1.
- EXISTING LIGHT FIXTURE AT NEW LOCATION SEE DEMOLITION NOTE 3.
- PROVIDE COMPACT FLUORESCENT TYPE, PHOTOCELL CONTROLLED LIGHT FIXTURE WITH 1-13W LAMP, FIXTURE SHALL BE EQUAL TO LIGHTWAY INDUSTRIES CAT. NO. SWP13. CONNECT TO EXISTING CIRCUIT SEE DEMOLITION NOTE 4.
- PROVIDE FLUSH MOUNTED RECEPTACLE. CONNECT TO EXISTING KITCHEN RECEPTACLE CIRCUIT IN EXISTING PANEL.
- PROVIDE FLUSH MOUNTED WIRING DEVICES, CONNECT TO EXISTING CIRCUIT SEE DEMOLITION NOTE 9.
- PROVIDE ELECTRICAL CONNECTION TO NEW RANGEHOOD.
- PROVIDE ELECTRICAL CONNECTION TO HOT WATER CIRCULATING PUMP.
- PROVIDE ELECTRICAL CONNECTION TO AIR HANDLING UNIT.
- PROVIDE FLUSH MOUNTED RECEPTACLE. CONNECT TO EXISTING PANEL. PROVIDE 20A, 1P CIRCUIT BREAKER IN THE EXISTING PANEL.

### GENERAL NOTES

- PROVIDE ALL ELECTRICAL DEMOLITION WORK NECESSARY TO INSTALL NEW WORK. ELECTRICAL CONTRACTOR SHALL REROUTE AND RECONNECT ANY CIRCUITS THAT WILL REMAIN IN USE BUT INTERFERE WITH NEW CONSTRUCTION.
  - ALL EXISTING CONDUITS THAT WILL NOT BE REUSED SHALL BE REMOVED WHERE THEY WILL BE EXPOSED AFTER COMPLETION OF THE CONSTRUCTION. ALL OTHERS MAY BE ABANDONED IN WALLS ONLY. CONTRACTOR SHALL REMOVE ALL WIRING FROM ABANDONED CONDUITS, DISCONNECT FROM ALL POWER SOURCES AND PROVIDE BLANK PLATES ON ALL ABANDONED OUTLETS. CUT-OFF ABANDONED CONDUIT 2" BELOW FINISHED FLOOR AND GROUT FLUSH.
  - MAINTAIN CONTINUITY OF ALL EXISTING CIRCUITS TO REMAIN OR PORTIONS THEREOF AFFECTED BY NEW WORK.
  - ALL MATERIALS REMOVED UNDER DEMOLITION (AND NOT TO BE RELOCATED) SHALL BECOME THE PROPERTY OF THE CONTRACTOR AND SHALL BE REMOVED COMPLETELY FROM THE SITE.
- CONTRACTOR SHALL EXERCISE CARE IN REMOVING DEMOLITION ITEMS AND SHALL REPAIR OR REPLACE AT HIS COST ANY DAMAGE CAUSED TO EXISTING CONSTRUCTION AND EQUIPMENT TO REMAIN.
- DRAWINGS ARE BASED ON EXISTING PLANS AND FIELD INVESTIGATION WITHOUT DEMOLITION. CONTRACTOR SHALL VISIT THE EXISTING BUILDING AND FAMILIARIZE HIMSELF WITH EXISTING CONDITIONS AND SHALL EXAMINE ALL RELATED
- ALL CONDUIT SHALL BE CONCEALED AND WIRING DEVICES FLUSH WHERE PRACTICABLE. COORDINATE WITH ARCHITECTURAL WORK.
- SURFACE MOUNTED RACEWAY & WIRING DEVICES SHALL MATCH ADJACENT SURFACE COLOR.
- 9. SEE LEGEND ON SHEET E-4.

DRAWINGS TO AVOID CONFLICTS.

10. PROVIDE ONE TELEPHONE OUTLET IN THE KITCHEN AND ONE IN THE MASTER BEDROOM. COORDINATE CONNECTION AND WIRING WITH THE AUTHORITIES.

### ABATEMENT NOTE

ELECTRICAL EXPOSED AND PAINTED CONDUIT AND DEVICES HAVE BEEN TESTED AND ARE KNOWN TO CONTAIN LEAD BASED PAINT. ALL ELECTRICAL EXPOSED CONDUIT AND DEVICES SHALL BE HANDLED IN ACCORDANCE WITH SPECIFICATION SECTION 02090 BY THE ABATEMENT CONTRACTOR.



COMPREHENSIVE RENOVATION VA 3-2MARSHALL COURTS

NEWPORT NEWS, VA



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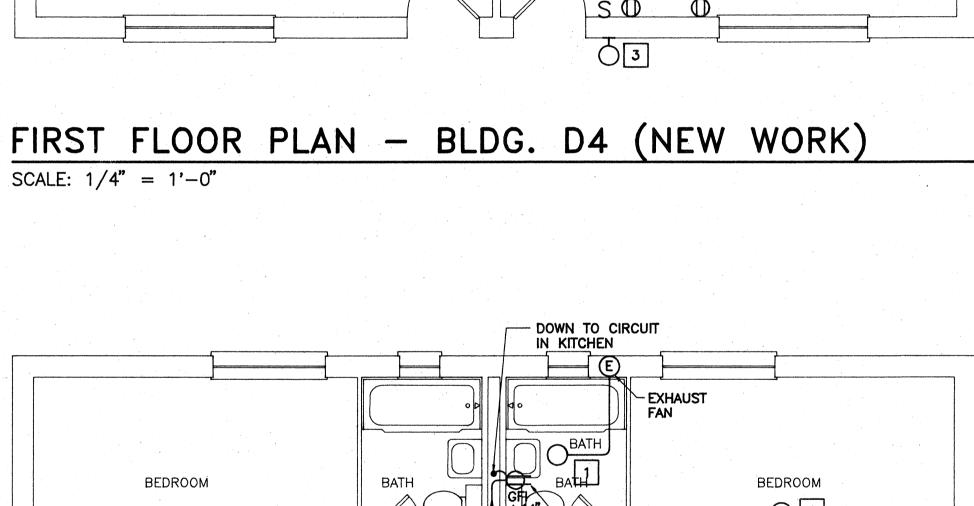
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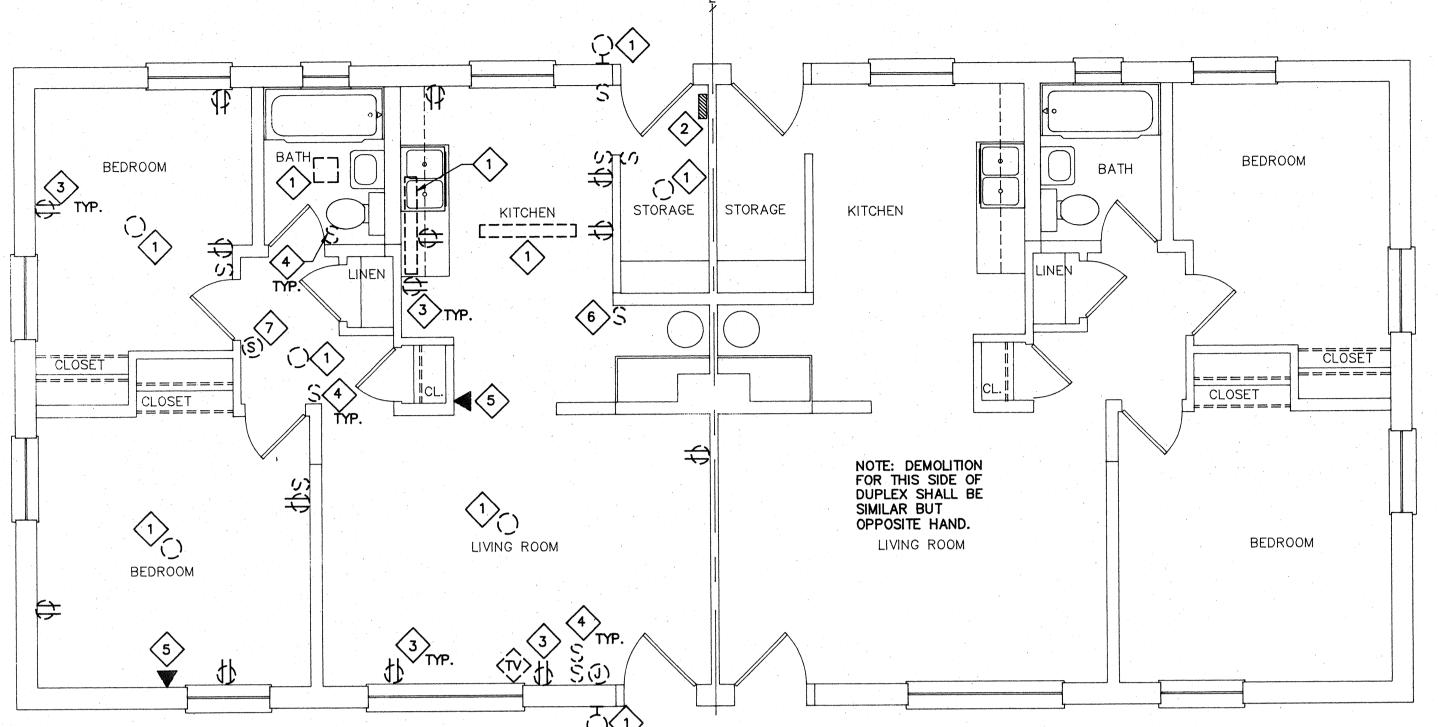
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BUILDING TYPE D4 -FLOOR PLANS (DEMOLITION & NEW WORK)


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FLOOR PLAN - BUILDING D2 / 1BR HANDICAPPED CONVERSION (DEMOLITION)

SCALE: 1/4" = 1'-0"



FLOOR PLAN - BUILDING D2 / 1BR HANDICAPPED CONVERSION (NEW WORK)

SCALE: 1/4" = 1'-0"
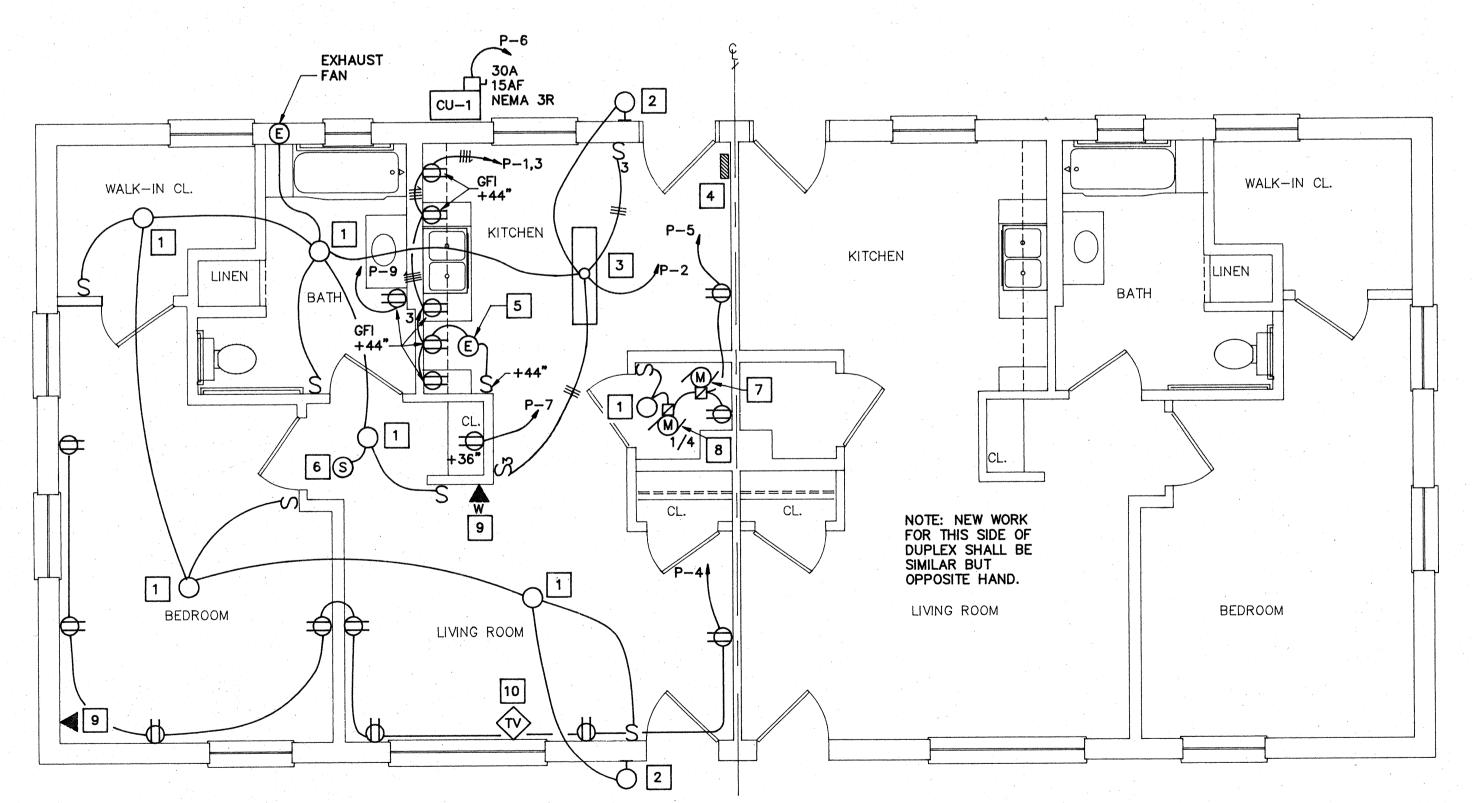
#### PANELBOARD SCHEDULE CKT. NO. DESCRIPTION DESCRIPTION LIGHTS KITCHEN RECEPTACLE RECEPTACLE CU-1 \* WASHING MACHINE SPACE \* BATHROOM RECEPTACLE 10 NOTE: ALL BRANCH CIRCUIT BREAKERS ARE 20A-IP, U.O.N.

PANEL: P

TYPE : EXISTING

MAINS: 100 A MLO
VOLTAGE: 120/240V ,1 PHASE, 3 WIRE, SN

MOUNTING: SURFACE KITCHEN

\* PROVIDE 20A, 1P CIRCUIT BREAKER

### DEMOLITION NOTES

- 1. REMOVE LIGHT FIXTURE WITH ASSOCIATED CONDUIT AND WRING.
- 2. EXISTING PANEL TO REMAIN. REMOVE LEAD BASE PAINT. SEE ABATEMENT NOTE.
- 3. REMOVE EXISTING RECEPTACLE WITH ASSOCIATED CONDUIT AND WIRING.
- 4. REMOVE LIGHT SWITCH WITH ASSOCIATED CONDUIT AND WRING.
- 5. REMOVE TELEPHONE OUTLET WITH ASSOCIATED WIRING, TELEPHONE SERVICE TO REMAIN.
- 6. REMOVE EXISTING SWITCH WITH ASSOCIATED CONDUIT & WIRING FOR EXISTING HEAT UNIT.
- 7. REMOVE SMOKE DETECTOR WITH ASSOCIAETD WIRING.
- 8. REMOVE TV OUTLET. EXISTING SERVICE TO REMAIN.

### NEW WORK NOTES

- PROVIDE COMPACT FLUORESCENT TYPE LIGHT FIXTURE WITH 3-13W LAMPS, EQUAL TO LIGHTWAY INDUSTRIES CAT. NO. C39LP.
- PROVIDE COMPACT FLUORESCENT WITH 1-13W LAMP, FIXTURE SHALL BE EQUAL TO LIGHTWAY INDUSTRIES CAT. NO. SWP13. SEE GENERAL NOTE 10.
- INSTALL SURFACE MOUNTED 2 LAMP, 4 FT. FLUORESCENT LIGHT FIXTURE.

FIXTURE SHALL BE EQUAL TO MIDWEST CAT. NO. F-92-40R-A.

- EXISTING 100A, MLO, 120/240V, 1 PHASE, 3 WIRE. SEE PANELBOARD SCHEDULE THIS SHEET.
- 5. PROVIDE ELECTRICAL CONNECTION TO RANGEHOOD.
- 6. CONNECT SMOKE DETECTOR AHEAD OF SWITCH.
- 7. PROVIDE ELECTRICAL CONNECTION TO HOT WATER CIRCULATING PUMP.
- 8. PROVIDE ELECTRICAL CONNECTION TO AIR HANDLING UNIT.
- 9. CONNECT TO EXISTING TELEPHONE SERVICE.
- 10. PROVIDE FLUSH MOUNTED TV OUTLET. CONNECT TO EXISTING SERVICE.

### GENERAL NOTES

- PROVIDE ALL ELECTRICAL DEMOLITION WORK NECESSARY TO INSTALL NEW WORK. ELECTRICAL CONTRACTOR SHALL REROUTE AND RECONNECT ANY CIRCUITS THAT WILL REMAIN IN USE BUT INTERFERE WITH NEW CONSTRUCTION.
- ALL EXISTING CONDUITS THAT WILL NOT BE REUSED SHALL BE REMOVED WHERE THEY WILL BE EXPOSED AFTER COMPLETION OF THE CONSTRUCTION. ALL OTHERS MAY BE ABANDONED IN WALLS ONLY. CONTRACTOR SHALL REMOVE ALL WIRING FROM ABANDONED CONDUITS, DISCONNECT FROM ALL POWER SOURCES AND PROVIDE BLANK PLATES ON ALL ABANDONED OUTLETS. CUT-OFF ABANDONED CONDUIT 2" BELOW FINISHED FLOOR AND GROUT FLUSH.
- MAINTAIN CONTINUITY OF ALL EXISTING CIRCUITS TO REMAIN OR PORTIONS THEREOF AFFECTED BY NEW WORK.
- 4. ALL MATERIALS REMOVED UNDER DEMOLITION (AND NOT TO BE RELOCATED) SHALL BECOME THE PROPERTY OF THE CONTRACTOR AND SHALL BE REMOVED COMPLETELY FROM THE SITE.
- 5. CONTRACTOR SHALL EXERCISE CARE IN REMOVING DEMOLITION ITEMS AND SHALL REPAIR OR REPLACE AT HIS COST ANY DAMAGE CAUSED TO EXISTING CONSTRUCTION AND EQUIPMENT TO REMAIN.
- 6. DRAWINGS ARE BASED ON EXISTING PLANS AND FIELD INVESTIGATION WITHOUT DEMOLITION. CONTRACTOR SHALL VISIT THE EXISTING BUILDING AND FAMILIARIZE HIMSELF WITH EXISTING CONDITIONS AND SHALL EXAMINE ALL RELATED DRAWINGS TO AVOID CONFLICTS.
- 7. ALL CONDUIT SHALL BE CONCEALED AND WRING DEVICES FLUSH.

**ABATEMENT** 

- 8. SEE LEGEND ON SHEET E-4.
- MOUNTING HEIGHT FOR LIGHT SWITCHES, RECEPTACLES AND TELEPHONE OUTLETS, SHALL BE PER ANSI A 117.1 SECTION 4.27.

ELECTRICAL EXPOSED AND PAINTED CONDUIT AND DEVICES HAVE BEEN TESTED AND ARE KNOWN TO CONTAIN LEAD BASED PAINT. ALL ELECTRICAL

EXPOSED CONDUIT AND DEVICES SHALL BE HANDLED IN ACCORDANCE WITH SPECIFICATION SECTION 02090 BY THE ABATEMENT CONTRACTOR.

#### DPM Drawn: HDMChecked

NOTE

AS NOTED Scale Date: JANUARY 31, 1992

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VA 3-2

COURTS

**MARSHALL** 


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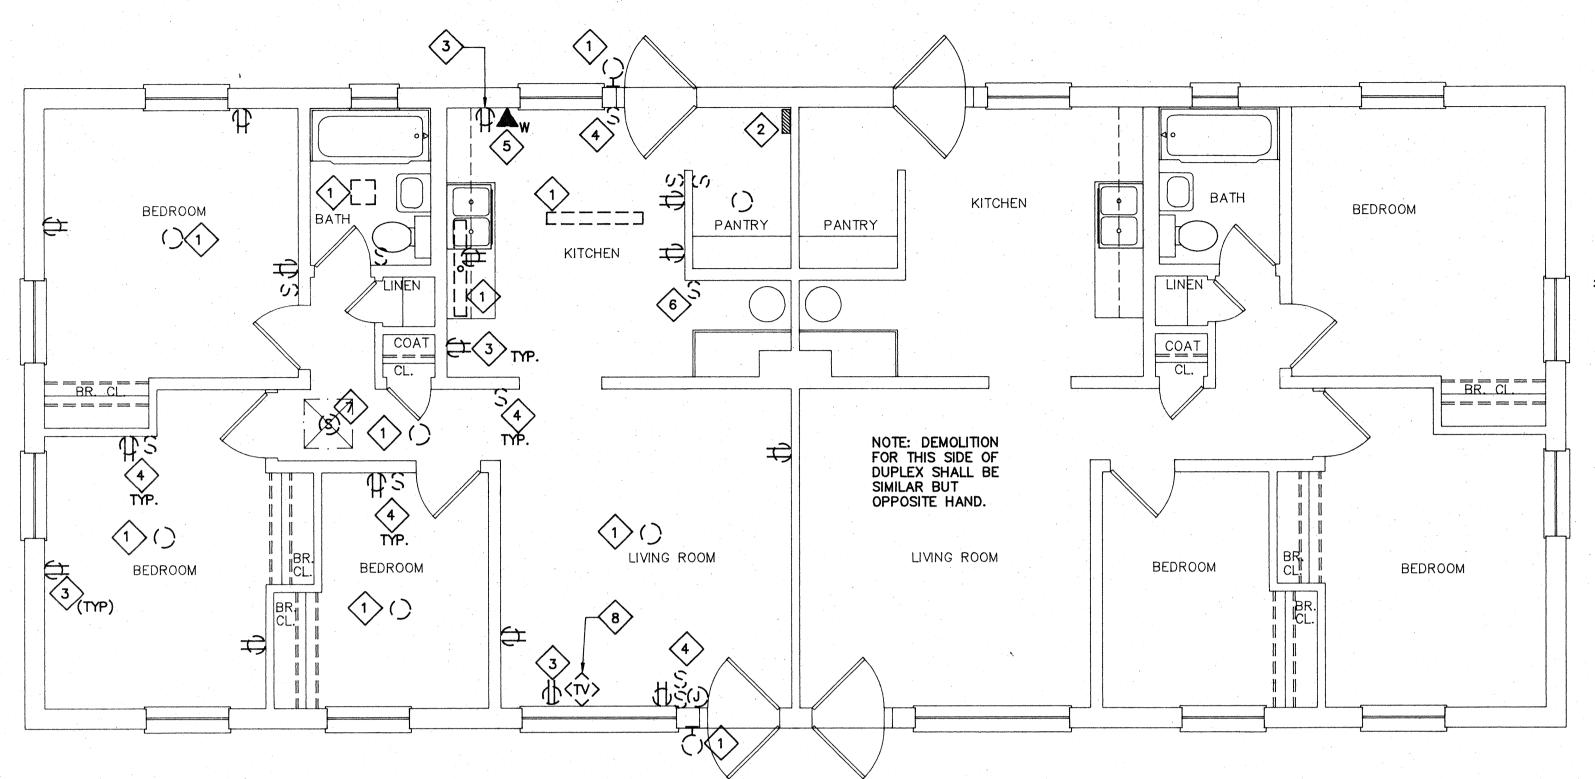
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BUILDING TYPE D2 -FLOOR PLANS (DEMOLITION & NEW WORK / HANDICAPPED CONVERSION)


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FLOOR PLAN - BUILDING D3 - HANDICAPPED CONVERSION (DEMOLITION)

SCALE: 1/4" = 1'-0"



FLOOR PLAN - BUILDING D3 - HANDICAPPED CONVERSION (NEW WORK)

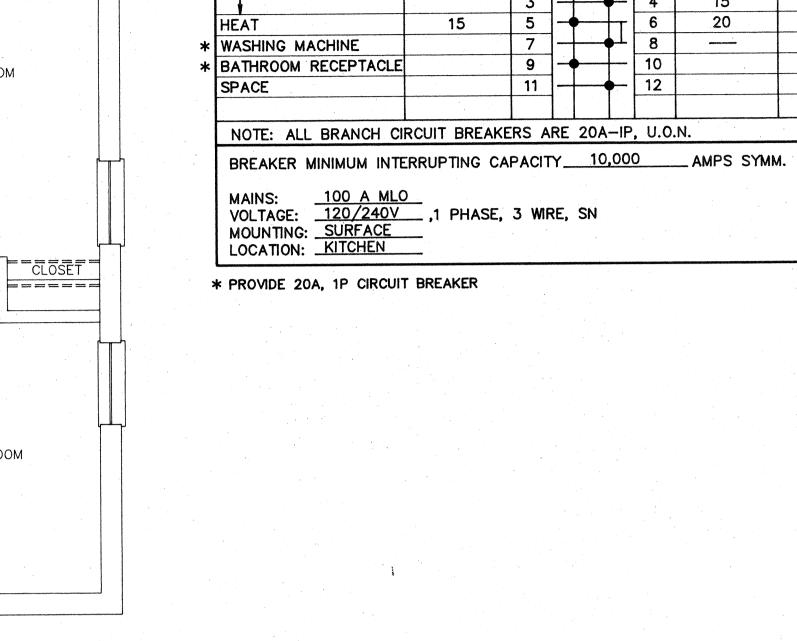SCALE: 1/4" = 1'-0"
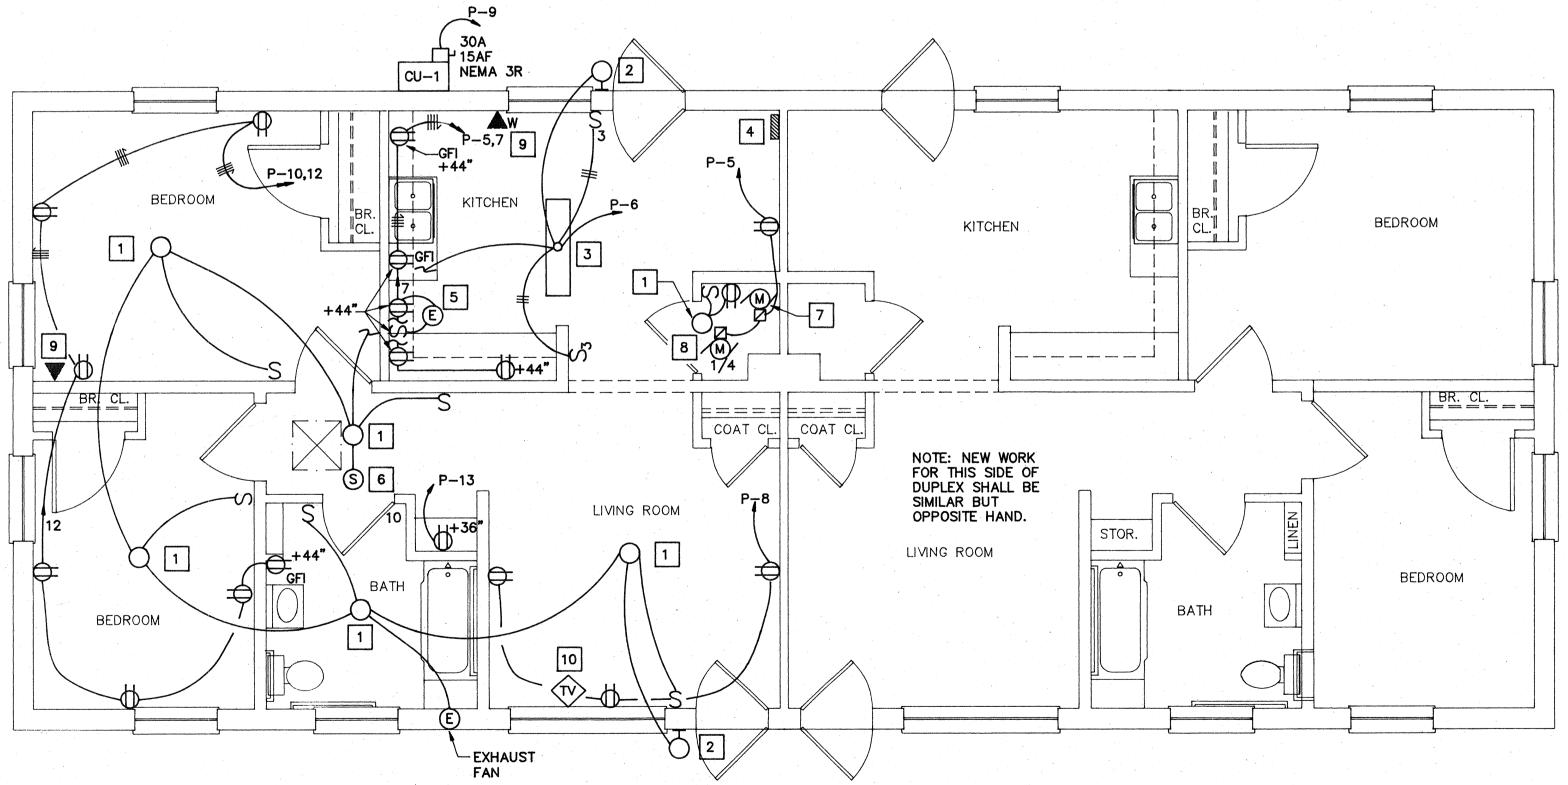
#### 

NOTE: ALL BRANCH CIRCUIT BREAKERS ARE 20A-IP, U.O.N.

BREAKER MINIMUM INTERRUPTING CAPACITY 10,000 AMPS SYMM. PANEL: P

TYPE: EXISTING

MAINS: 100 A MCB
VOLTAGE: 120/240V ,1 PHASE, 3 WIRE, SN
MOUNTING: SURFACE
LOCATION: KITCHEN

\* PROVIDE 20A, 1P CIRCUIT BREAKER.

### > DEMOLITION NOTES

- 1. REMOVE LIGHT FIXTURE WITH ASSOCIATED CONDUIT AND WRING.
- 2. EXISTING PANEL TO REMAIN. REMOVE LEAD BASE PAINT. SEE ABATEMENT NOTE.
- 3. REMOVE EXISTING RECEPTACLE WITH ASSOCIATED CONDUIT AND WIRING.
- 4. REMOVE LIGHT SWITCH WITH ASSOCIATED CONDUIT AND WIRING.
- 5. REMOVE TELEPHONE OUTLET WITH ASSOCIATED WIRING. TELEPHONE SERVICE TO REMAIN.
- 6. REMOVE EXISTING SWITCH WITH ASSOCIATED CONDUIT & WIRING FOR EXISTING HEAT UNIT.
- 7. REMOVE SMOKE DETECTOR WITH ASSOCIATED WIRING.
- 8. REMOVE TV OUTLET. EXISTING SERVICE TO REMAIN.

### NEW WORK NOTES

- . PROVIDE COMPACT FLUORESCENT TYPE LIGHT FIXTURE WITH 3-13W LAMPS, EQUAL TO LIGHTWAY INDUSTRIES CAT. NO. C39LP.
- 2. PROVIDE COMPACT FLUORESCENT WITH 1-13W LAMP, FIXTURE SHALL BE EQUAL TO LIGHTWAY INDUSTRIES CAT. NO. SWP13.
- 3. INSTALL SURFACE MOUNTED 2 LAMP, 4 FT. FLUORESCENT LIGHT FIXTURE. FIXTURE SHALL BE EQUAL TO MIDWEST CAT. NO. F-92-40R-A.
- 4. EXISTING 100A, MCB, 120/240V, 1 PHASE, 3 WIRE. SEE PANELBOARD SCHEDULE THIS SHEET.
- 5. PROVIDE ELECTRICAL CONNECTION TO RANGEHOOD.
- 6. CONNECT SMOKE DETECTOR AHEAD OF SWITCH.
- 7. PROVIDE ELECTRICAL CONNECTION TO HOT WATER CIRCULATING PUMP.
- 8. PROVIDE ELECTRICAL CONNECTION TO AIR HANDLING UNIT.
- 9. CONNECT TO EXISTING TELEPHONE SERVICE.
- 10. PROVIDE FLUSH MOUNTED TV OUTLET. CONNECT TO EXISTING SERVICE.

### GENERAL NOTES

- 1. PROVIDE ALL ELECTRICAL DEMOLITION WORK NECESSARY TO INSTALL NEW WORK. ELECTRICAL CONTRACTOR SHALL REROUTE AND RECONNECT ANY CIRCUITS THAT WILL REMAIN IN USE BUT INTERFERE WITH NEW CONSTRUCTION.
- ALL EXISTING CONDUITS THAT WILL NOT BE REUSED SHALL BE REMOVED WHERE THEY WILL BE EXPOSED AFTER COMPLETION OF THE CONSTRUCTION. ALL OTHERS MAY BE ABANDONED IN WALLS ONLY. CONTRACTOR SHALL REMOVE ALL WIRING FROM ABANDONED CONDUITS, DISCONNECT FROM ALL POWER SOURCES AND PROVIDE BLANK PLATES ON ALL ABANDONED OUTLETS. CUT—OFF ABANDONED CONDUIT 2" BELOW FINISHED FLOOR AND GROUT FLUSH.
- 3. MAINTAIN CONTINUITY OF ALL EXISTING CIRCUITS TO REMAIN OR PORTIONS THEREOF AFFECTED BY NEW WORK.
- 4. ALL MATERIALS REMOVED UNDER DEMOLITION (AND NOT TO BE RELOCATED) SHALL BECOME THE PROPERTY OF THE CONTRACTOR AND SHALL BE REMOVED COMPLETELY FROM THE SITE.
- 5. CONTRACTOR SHALL EXERCISE CARE IN REMOVING DEMOLITION ITEMS AND SHALL REPAIR OR REPLACE AT HIS COST ANY DAMAGE CAUSED TO EXISTING CONSTRUCTION AND EQUIPMENT TO REMAIN.
- 6. DRAWINGS ARE BASED ON EXISTING PLANS AND FIELD INVESTIGATION WITHOUT DEMOLITION. CONTRACTOR SHALL VISIT THE EXISTING BUILDING AND FAMILIARIZE HIMSELF WITH EXISTING CONDITIONS AND SHALL EXAMINE ALL RELATED DRAWINGS TO AVOID CONFLICTS.
- 7. ALL CONDUIT SHALL BE CONCEALED AND WIRING DEVICES FLUSH. COORDINATE WITH ARCHITECTURAL WORK.
- 8. SEE LEGEND ON SHEET E-4.
- MOUNTING HEIGHT FOR LIGHT SWITCHES, RECEPTACLES, AND TELEPHONE OUTLETS, SHALL BE PER ANSI A 117.1 SECTION 4.27.

### ABATEMENT NOTE


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COMPREHENSIVE RENOVATION OF VA 3-2 MARSHALL

COURTS

NEWPORT NEWS, VA



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Project No: 90006

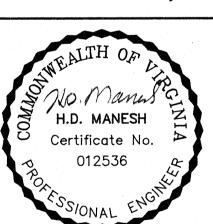File No:

BUILDING
TYPE D3 FLOOR PLANS
(DEMOLITION &
NEW WORK /
HANDICAPPED
CONVERSION)

Sheet No

E12